# 145 BERGEN AVENUE BLOCK 18402 LOT 36 70NING COMPARISON CHART

ZUNING CUMPA	MISUN CHART			
ITEM	DISTRICT "R-3" REQUIREMENTS	EXISTING	PROPOSED	VARIANCE REQUIRED
USE	SEE NOTE 1*	VACANT	THREE FAMILY DWELLING W/ PRIVATE GARAGE	NO
MIN. LOT AREA	2,500 SF ( THREE OR FOUR FAMILY)	4,694.05 SF	NO CHANGE	NO
MIN. LOT WIDTH	25 FT. (THREE OR FOUR FAMILY)	33.63 FT / 34. 12 FT	NO CHANGE	NO
MIN. LOT DEPTH	100 FT.	141.58 FT / 139.47 FT	NO CHANGE	NO
FRONT SETBACK	SHALL MATCH THE SETBACK OF THE PRIMARY BUILDING FACADE OF THE CLOSEST PERMITTED USE ON EITHER SIDE. (THREE OR FOUR FAMILY) 12.92 FT.	N/A	13.79 FT.	NO
FRONT + REAR SETBACK REAR SETBACK	FRONT (12.92') + REAR = MIN. 35 FT. REAR YARD = MIN.20 FT. (THREE OR FOUR FAMILY)	N/A N/A	35.00 FT. (13.79' + 29.27') 43.06 FT.	NO NO
SIDE YARD SETBACK	SEE NOTE 3***	N/A	3.08 FT / 4.08 FT	NO
MIN. BUILDING HEIGHT	3 STORIES	VACANT	4 STORY	NO
MAX. BUILDING HEIGHT	4 STORIES 42.0'	VACANT	4 STORY/ 35'-3"	NO
MIN. CEILING HEIGHT	9.0' FOR RESIDENTIAL	VACANT	9.0'	NO
MAXIMUM BLDG. COVERAGE	60% ( THREE OR FOUR FAMILY)	0%	52.59 %	NO
MAXIMUM LOT COVERAGE	80% ( THREE OR FOUR FAMILY)	0%	79.93 %	NO
OFF-STREET PARKING REQ. (LESS THAN 37' LOT WIDE)	PARKING IS NOT REQUIRED ( THREE OR FOUR FAMILY MAX. 2 PARKING SPACE	) N/A	0 SPACES	NO
MIN. FRONT LANDSCAPING AREA	30% ( AT FRONT YARD AREA)	N/A	71.42%	NO

. MID-RISE APARTMENT BUILDINGS, (SEE 345-6 FOR DEFINITION). / 2. TOWNHOUSES ( 4 UNITS MAX.). / 3. THREE AND FOUR FAMILY DETACHED DWELLINGS. / 4. HOUSES OF WORSHIP. / 5. PARKS AND PLAYGROUNDS. / 6. ESSENTIAL SERVICES. / 7. SCHOOLS. / 8. GOVERNMENTAL USES. / 9. OFFICE USES, INCLUDING MEDICAL OFFICES FOR NO MORE THAN TWO PRACTITIONERS. AS PART OF THE GROUND FLOOR OF MID-RISE APARTMENT BUILDINGS ALONG JOHN F. KENNEDY BOULEVARD. / 10. ASSISTED LIVING RESIDENCES. / 11. NURSING HOMES. / 12. SENIOR HOUSING. / 13. PUBLIC UTILITIES, EXCEPT THAT NATURAL GAS TRANSMISSION LINES SHALL BE PROHIBITED. / 14. GROUND FLOOR RETAIL, LIMITED TO NEW CONSTRUCTION ON CORNER LOTS.

\*\*NOTE 3: THREE- AND FOUR-FAMILY DETACHED DWELLINGS: MINIMUM TWO (2) FEET ONE (1) SIDE, THREE (3) FEET OTHER SIDE, FIVE (5) FEET TOTAL BOTH SIDES ON LOTS LESS THAN ihirty-seven (37) feet in width; minimum five (5) feet on each side on lots thirty-seven (37) feet in width or greater.

## ZONING AND BUILDING CODE DATA: FOUR-FAMILY DETACHED

ADDRESS: 145 BERGEN AVENUE, JERSEY CITY, NJ PROPOSED WORK: NEW 4 STORY BUILDING W/ 4 DWELLING UNITS EXISTING USE: VACANT

PROPOSED USE: FOUR FAMILY DWELLING EXISTING AREA OF LARGEST FLOOR: 0 SF TOTAL NEW AREA OF LARGEST FLOOR: 2,469 SF TOTAL 9,804 SF TOTAL GROSS BUILDING AREA:

\*NOTE 1: PERMITTED PRINCIPAL USES

**VOLUME OF BUILDING:** 88,236 CU. FT. SPRINKLER SYSTEM: NFPA 13R SPRINKLER SYSTEM (SEC. 903.3.1.1)

BUILDING CONSTRUCTION CLASSIFICATION: 5-A BUILDING USE GROUP: R-2

FIRST FLOOR: 2,469 SF SECOND FLOOR: 2,433 SF VOLUME OF BUILDING: 88.236 CU. FT.

## APPLICABLE CODE:

1. BUILDING SUBCODE (NJAC 5:23-3.14) International Building Code/2018,NJ ed (IBC w/NJ edits from 3.14) International Residential Code/2018, International Fire Code/2018

2. PLUMBING SUBCODE (NJAC 5:23-3.15) National Standard Plumbing Code/2018 3. ELECTRICAL SUBCODE (NJAC 5:23-3.16) National Electrical Code (NFPA 70)/2017 4. ENERGY SUBCODE (NJAC 5:23-3.18) International Energy Conservation Code/2018(Residential)

5. MECHANICAL SUBCODE (NJAC 5:23-3.20) International Mechanical Code/2018 6. FUEL GAS SUBCODE (NJAC 5:23-3.22) International Fuel Gas Code/2018

## BUILDING DATA

FIRE RATINGS:

EXTERIOR WALLS: SIDE - 1 HR REQ'D (LOAD BEARING EXT. WALL) FRONT - 0 HR REQ'D (NONBEARING EXT. WALL) SIDE - 2 HR REQ'D (FIRE EXT. WALL) REAR - 0 HR. REQ'D (NONBEARING EXT. WALL > 30' FROM PROP. LINE) DWELLING UNIT SEPARATION: DEMISING WALLS & LOAD BEARING WALLS - 1 HR. REQ'D

FLOOR-CEILING - 1 HR. REQ'D DESIGN LOADS:

FLOORS: LL 40 PSF ROOFS: LL 25 PSF COMMON AREAS: LL 100 PSF DL 20 PSF DL 15 PSF

WIND LOAD: BASIC WINDSPEED 100 MPH BUILDING OCCUPANCY: 8,629 SF NET/200 SF PER PERSON = 43.1 PERSONS

## UNIT DATA

UNIT 1: (4 BR + 4 BA) GROUND LEVEL: 1,586 SF TERRACE: 201 SF

UNIT 2: (4 BR + 4.5 BA) 1ST FLOOR: 2,018 SF BALCONY: 55 SF

UNIT 3: (4 BR + 4.5 BA) 2ND FLOOR: 2,178 SF BALCONY: 55 SF

UNIT 4: (4 BR + 4.5 BA)

3RD FLOOR: 2,218 SF ROOF DECK: 460 SF BALCONY: 55 SF

## **DEMOLITION NOTES:**

1) CONFORM TO APPLICABLE CODE FOR DEMOLITION WORK, DUST CONTROL AND PRODUCTS REQUIRING ELECTRICAL DISCONNECTION. 2) OBTAIN REQUIRED PERMITS FROM AUTHORITIES AND DISPOSE OF ALL MATERIALS IN ACCORDANCE WITH ALL APPLICABLE REGULATIONS OF PUBLIC AGENCIES HAVING

3) THE CONTRACTOR IS RESPONSIBLE FOR THE METHODS. MEANS AND DESTINATION OF ALL OFF-SITE DISPOSAL. 4) DO NOT CLOSE OR OBSTRUCT EGRESS WIDTH TO ANY BUILDING OR SITE EXIT. 5) PROVIDE, ERECT AND MAINTAIN TEMPORARY BARRIERS AND SECURITY DEVICES.

6) PREVENT MOVEMENT OR SETTLEMENT OF ADJACENT STRUCTURES. PROVIDE BRACING AND SHORING.

7) MARK LOCATION AND TERMINATION OF UTILITIES.

8) NOTIFY AFFECTED UTILITY COMPANIES 9) CONDUCT DEMOLITION TO MINIMIZE INTERFERENCE WITH ADJACENT STRUCTURES. 10) CEASE OPERATIONS IMMEDIATELY IF ADJACENT STRUCTURES APPEAR TO BE IN DANGER. NOTIFY AUTHORITY HAVING JURISDICTION AND ARCHITECT/ ENGINEER. DO NOT RESUME OPERATIONS UNTIL DIRECTED.

11) OBTAIN WRITTEN PERMISSION FROM ADJACENT PROPERTY OWNERS WHEN DEMOLITION EQUIPMENT WILL TRAVERSE, INFRINGE UPON OR LIMIT ACCESS TO THEIR

12) SPRINKLE WORK WITH WATER TO MINIMIZE DUST. PROVIDE HOSES AND WATER CONNECTIONS FOR THIS PURPOSE.

13) DO NOT BURN OR BURY MATERIALS ON SITE. LEAVE SITE IN CLEAN CONDITION.

N 36°-04'-00"E 33.63'(TM)

141.58

2 1/2 STORY BRICK FRAME

2

# PROPOSED 4 STORY NEW FOUR FAMILY DWELLING

145 BERGEN AVENUE, JERSEY CITY, NJ BLOCK 18402 LOT 36

- T-1: PROPOSED ZONING / BUILDING NOTES & EXISTING SITE PLANS / DETAILS
- S-1: PROPOSED SITE PLAN & SITE DETAILS C-1: PROPOSED SITE DETAILS
- C-2: PROPOSED SITE DETAILS

DRAWING INDEX

- C-3: PROPOSED STREET TREE SITE DETAILS & NOTES
- C-4: PROPOSED SITE DETAILS
- A-1: PROPOSED FLOOR PLANS A-2: PROPOSED FLOOR PLANS

LOT 35

2 STORY WOOD FRAME

BUILDING

4 EXISTING SITE PLAN


SCALE: 1"= 10'-0"

00


- A-3: PROPOSED ELEVATIONS
- A-4: PROPOSED ELEVATIONS
- A-5: PROPOSED ELEVATIONS
- A-6: WALL & FLOOR/CEILING ASSEMBLY DETAILS & SCHEDULES A-7: WINDOW DETAILS, SCHEDULES & BUILDING NOTES


### GENERAL NOTES

TEMPORARY SHORING, SHEETING AND BRACING OF THE EXCAVATIONS AND STRUCTURE DURING CONSTRUCTION. THE G.C. IS ALSO RESPONSIBLE

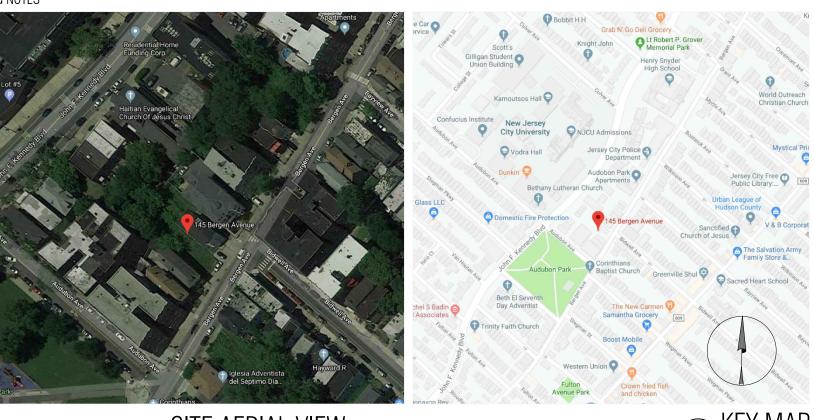



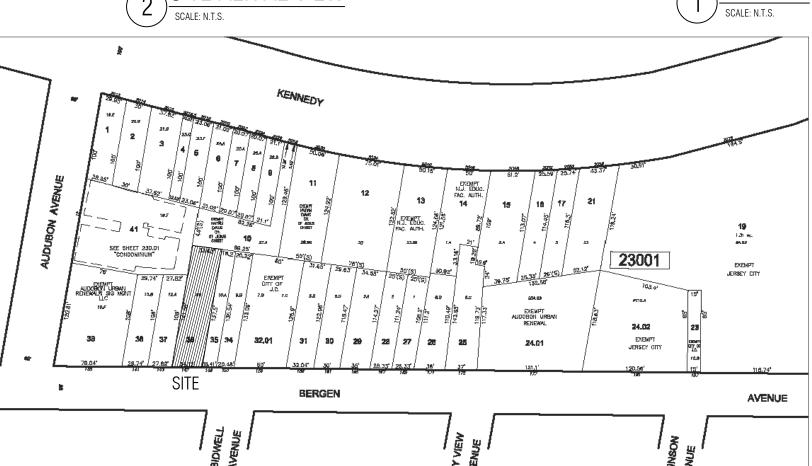

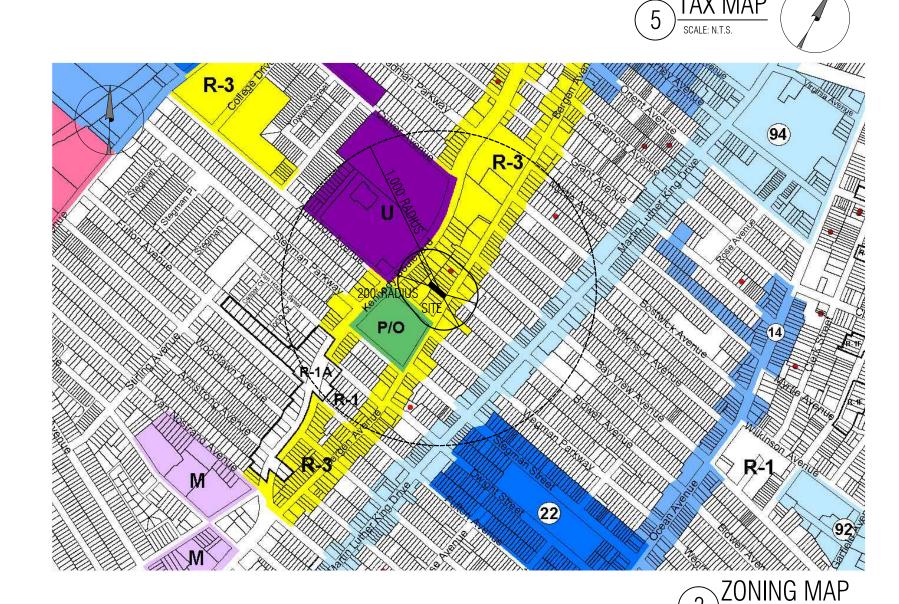

## HAMPTON HILL ARCHITECTURE

Jersey City, NJ 07304 201.401.0954. TEL

bob.a@hamptonhillnj.com m.kil@hamptonhillnj.com



MIN W. KIL Registered Architect: NJ LIC 21 AI 019B8530

OTHER THAN THE SPECIFIC PROJECT FOR WHICH IT WAS PREPARED WITHOUT THE EXPLICIT CONSENT OF HAMPTON HILL ARCHITECTURE.

**PROPOSED** 4 STORY **NEW FOUR FAMILY DWELLING** 


145 BERGEN AVENUE JERSEY CITY, **NEW JERSEY** 

BLOCK: 18402 LOT:36

CHKD BY: ISSUE DATE: 07.13.2020 PROJECT NO:

SHEET TITLE: EXISTING SITE PLANS, **ZONING CHART & BUILDING NOTES** 

SHEET No.

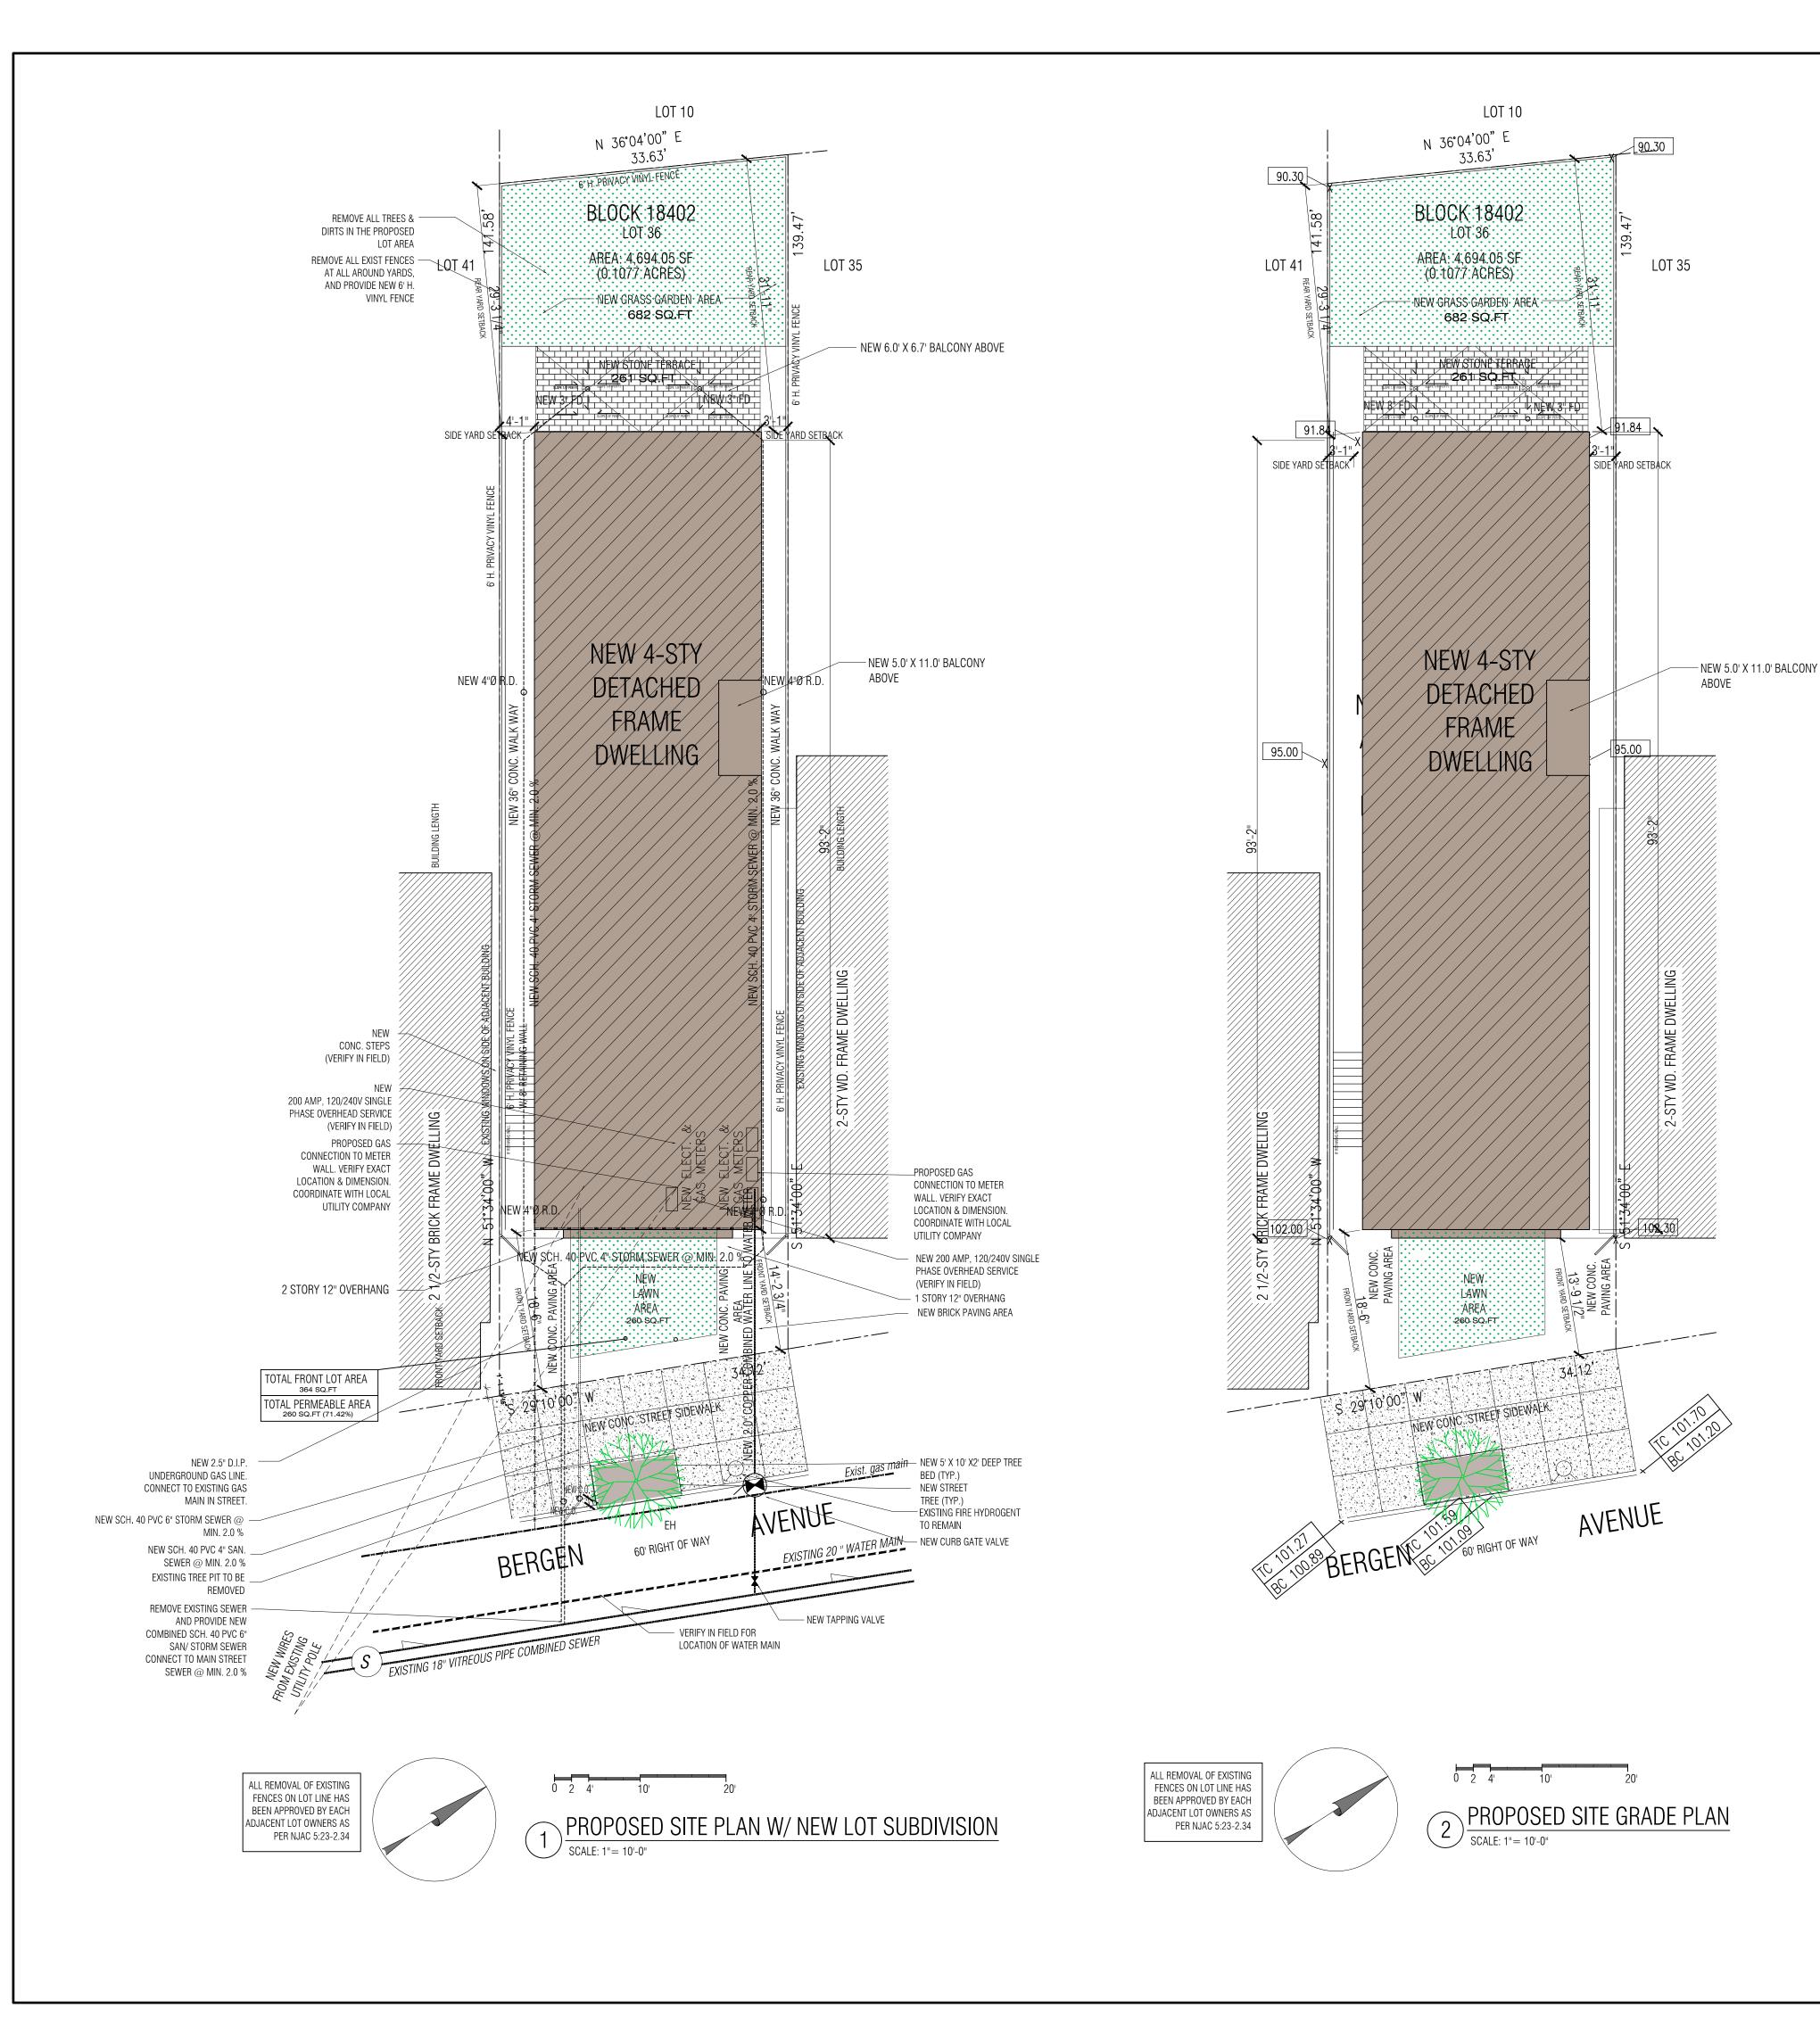



EXISTING SITE STREET VIEW

### SEWER CALCULATION:

#### ESTIMATED SEWER FLOW -(19) BATHGROUPS @ 3.0 DFUs = 57 DFUs @ 3.0 DFUs = 12 DFUs (4) KITCHEN GROUPS (4) LAUNDRY UNITS @ 3.0 DFUs = 12 DFU PER 2015 NSPC 11.4 AND 11.5:

4"Ø @ 1/8" MIN. SLOPE = 180 DFUs MAX. >>> THUS NEW 4"Ø LATERAL OK (VERIFY EXISTING IN FIELD)

## WATER CALCULATIONS:

	ESTIMATED DOMESTIC WATER	R USE -		
Js	(19) BATHGROUPS	@ 3.5 WSFUs	=	61.5 WSFU
Js	(4) KITCHEN GROUPS	@ 2.0 WSFUs	=	8.0 WSFU
<u>Js</u>	(4) LAUNDRY UNITS	@ 4.0 WSFUs	=	16.0 WSFU
Js	TOTAL		_	85.5 WSFU
	PER 2015 NSPC APPENDIX B:			

1.5"Ø COPPER PIPE @ 8FPS = 96.0 WSFUs MAX. >>> THUS MIN. 1.5"Ø SERVICE OK (VERIFY EXISTING IN FIELD)

4 STORY **NEW FOUR** FAMILY DWELLING

#### PLANTING SCHEDULE

FLANTING SCHEDOLE				
COMMON NAME KEY	BOTANICAL NAME	<u>Planting Size</u>	MATURE SIZE	
	TREE			
EUROPEAN HORNBEAM EH	Carpinus betulus	12' HIGH 3.5" CAL. (MIN.)	40' HIGH	

#### PLANTING MAINTENANCE:

_							
	1.	MAINTENANCE SEASON:	MARCH 1st - NOVEMBER 30th				
Ε	2.	SPRING MAINTENANCE:	MARCH -APRIL				
<u>E</u>		A. REMOVE WINTER DEBRIS FROM LANDSCAPE AREAS.					
		B. PRUNE TREES AS NEEDED.					
-		C. FERTILIZE TREES AND SHRUBS.					
		D. REPLACE MULCH FROM BED	S AS NEEDED.				
	3.	SUMMER MAINTENANCE:	MAY - SEPTEMBER				
		A. REMOVE DEBRIS FROM BEDS	S AND WEED AS NEEDED.P				
		B. PRUNE AND TRIM SHRUBS A	S NEEDED.				
	4.	FALL MAINTENANCE:	SEPTEMBER - NOVEMBER				
_		A. REMOVE DEBRIS FROM BEDS	S AND WEED AS NEEDED.				


B. REPLENISH MULCH IN BEDS.

### SITE PLAN NOTES:

1. ALL STREET CURBING AND SIDEWALKS ALONG PROPERTY FRONTAGES ARE TO BE REPLACED BY THE DEVELOPER AND SHALL COMPLY WITH THE REQUIREMENTS OF THE JERSEY CITY ENGINEERING STANDARDS.

2. SURVEY INFORMATION HAS BEEN TAKEN FROM SURVEY PREPARED BY AREA SURVEYING LLC. 3. ALL STRIPING AND SIGNAGE IN PARKING AREA SHALL BE IN ACCORDANCE WITH THE LATEST EDITION OF THE MANUAL OF UNIFORM TRAFFIC CONTROL DEVICES.

## LEGEND:

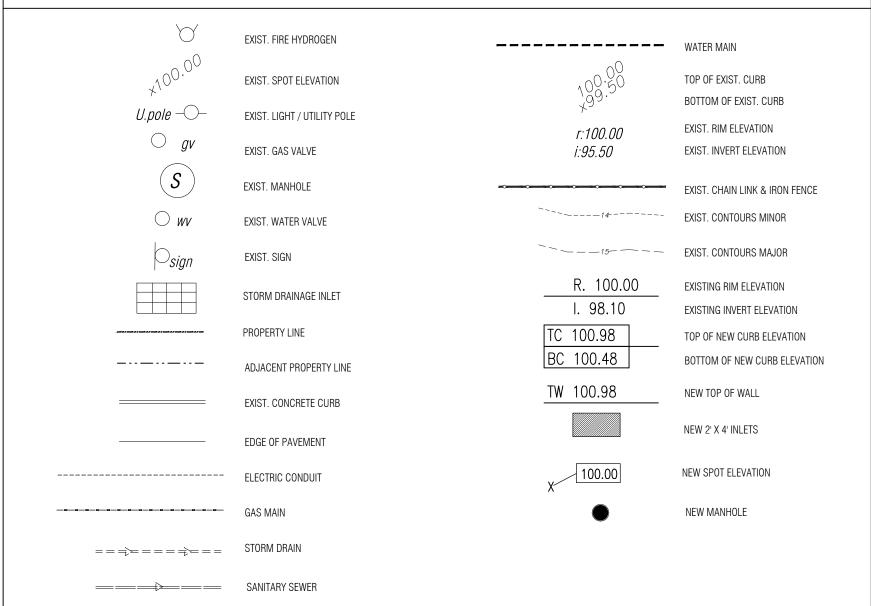

## HAMPTON HILL ARCHITECTURE

346 Virginia Avenue Jersey City, NJ 07304 201.401.0954. TEL mnaval2@comcast.net bob.a@hamptonhillnj.com

m.kil@hamptonhillnj.com SEAL:

MIN W. KIL Registered Architect: NJ LIC 21 AI 019B85300

THIS DOCUMENT IS THE EXCLUSIVE PROPERTY OF HAMPTON HILL ARCHITECTURE. THE DOCUMENT AND THE INFORMATION IT CONTAINS MAY NOT BE REPRODUCED OR USED FOR OTHER THAN THE SPECIFIC PROJECT FOR WHICH IT WAS PREPARED WITHOUT THE EXPLICIT CONSENT OF HAMPTON HILL ARCHITECTURE.

**PROPOSED** 

ADDRESS: 145 BERGEN AVENUE JERSEY CITY,

BLOCK: 18402 LOT:36

**NEW JERSEY** 

**REVISIONS:** 

DRAWN BY: CHKD BY: ISSUE DATE: 07.13.2020 PROJECT NO: 19059

SHEET TITLE: PROPOSED SITE PLAN & DETAILS

SHEET No.

## JCMUA STANDARD REQUIREMENTS FOR NEW SANITARY AND STORM SEWERS AND SERVICE LATERALS

## November 3, 2005

ALL APPLICATIONS SUBMITTED TO THE JERSEY CITY PLANNING BOARD MUST BE PRESENTED TO THE JCMUA FOR REVIEW AND COMMENTS ON THE PROPOSED SANITARY AND STORM SEWER CONNECTIONS. ALL PLANS MUST BE SIGNED AND SEALED BY A PROFESSIONAL ENGINEER OR REGISTERED ARCHITECT LICENSED TO PRACTICE IN NEW JERSEY AND SUBMITTED TO THE JCMUA'S SEWER ENGINEERING OFFICE, 555 ROUTE 440, JERSEY CITY, NJ FOR APPROVAL.

THE FOLLOWING TECHNICAL REQUIREMENTS SHALL BE ADDRESSED IN PREPARATION OF SITE/UTILITY PLANS: (UNDERLINED TEXT IS JCMUA TEXT VERBATIM: NON-UNDERLINED TEXT IS PROJECT ENGINEER'S COMMENT AS TO HOW IT IS ADDRESSED IN THIS APPLICATION.)

- 1. <u>BEDDING AND BACKFILL MATERIAL SHALL COMPLY WITH THE NUDOT'S STANDARD SPECIFICATION FOR ROAD AND </u> BRIDGE CONSTRUCTION, AND THE DESIGN AND CONSTRUCTION OF URBAN STORMWATER MANAGEMENT SYSTEMS, ASCE MANUALS AND REPORTS OF ENGINEERING PRACTICE NO. 77, 1993, AS APPLICABLE
- ALL BEDDING AND BACKFILLING WILL COMPLY WITH NJDOT'S STANDARDS.
- 2. <u>ALL SEWER SERVICE CONNECTIONS 6 INCHES IN SIZE OR SMALLER MUST BE MADE DIRECTLY TO THE SEWER</u> MAIN AND ALL CONNECTIONS 8 INCHES IN SIZE OR LARGER MUST BE MADE TO A MANHOLE. WHERE A CONNECTION TO A MANHOLE IS REQUIRED, MANHOLE BENCH AND CHANNEL MAY REQUIRE MODFICATION.
- NEW 6" COMBINED SANITARY/ STORM LATERAL IS SHOWN CONNECTED TO THE EXISTING MAIN SEWER
- 3. THE JCMUA RECOMMENDS THAT SEWER SERVICE CONNECTIONS TO BE RE-USED BE TELEVISED TO TO VERIFY THEIR <u>INTEGRITY.</u>

THIS DOES NOT APPLY. LATERAL PROPOSED IS NEW. AND ALL EXIST. LATERALS ARE TO BE ABANDONED.

- 4. <u>EACH BUILDING CONNECTION REQUIRES A CURB CLEANOUT (REFER TO ATTACHED DETAIL DRAWINGS). A T-WYE</u> CLEANOUT SHOULD BE INSTALLED ON BOTH THE STORM AND SANITARY LATERAL.
- 5. PROPOSED SEWER LATERAL CONNECTION TO JCMUA'S SEWER MAIN SHALL BE MADE ABOVE HORIZONTAL CENTER LINE OF PIPE (REFER TO ATTACHED SEWER SERVICE CONNECTION DETAILS)
- → DETAIL FOR SEWER CONNECTION IS PROVIDED ON THE SHEET C-1.
- 6. THE SIZE, MATERIAL, DEPTH, CONDITION, DIRECTION OF FLOW AND ANY OTHER RELEVANT CONDITIONS OF THE <u>EXISTING JCMUA SEWER TO WHICH YOU PLAN TO CONNECT MUST BE FIELD VERIFIED BY DEVELOPER TO DETERMINE</u> IF SAID CONNECTION IS PHYSICALLY POSSIBLE AND PRACTICAL. THIS VERIFICATION IS TO BE INCLUDED ON THE PLANS FOR THE PROJECT. ALSO, THE CONDITION, INVERTS AND RIM ELEVATION OF ANY EXISTING MANHOLE TO WHICH CONNECTION IS PROPOSED MUST BE FIELD VERIFIED.
- THE PROJECT ENGINEER PERFORMED AN INSPECTION OF THE SEWER WHERE THE PROPOSED EXTENSION IS TO BEGIN, AND FIELD VERIFIED THE INDICATED RIM AND INVERT ELEVATIONS.

- 7. <u>CIRCULAR HOLE SAWS WHICH ARE APPROPRIATELY SIZED OR HAND DRILLS WILL BE USED TO MAKE THE</u> OPENINGS IN THE EXISTING SEWER TO RECEIVE THE LATERALS. JACKHAMMERS, SLEDGEHAMMERS AND OTHER UNSUITABLE TOOLS OR MACHINERY WHICH MAY DAMAGE THE JCMUA'S SEWER MAIN ARE NOT ALLOWED TO BE USED TO MAKE THE LATERAL OPENINGS. ALL DEBRIS MUST BE REMOVED AND NOT ALLOWED TO FALL INTO
- THIS APPLIES IN THIS APPLICATION TO THE CUTTING OF THE EXISTING SEWER TO RECEIVE THE NEW 4" SEWER EXTENSION AND THE CONTRACTOR SHALL COMPLY
- 8. A DETAIL OF ANY PROPOSED MANHOLE OR CATCH BASIN SHOWING ALL DIMENSIONS IN ADDITION TO RIM, GRATE AND INVERT ELEVATIONS OF THE STRUCTURE AND ALL PIPES CONNECTED TO THE STRUCTURE MUST BE SHOWN ON PLANS. REFER TO JCMUA STANDARD DETAIL DRAWINGS FOR MANHOLES AND CATCH BASINS.
- → NO NEW MANHOLES ARE PROPOSED AS A PART OF THIS PROJECT.
- 9. PROPOSED MANHOLES CONSTRUCTED IN THE PUBLIC R.O.W. ON EXISTING OR PROPOSED JCMUA SEWERS SHALL BE FURNISHED WITH CONCENTRIC MANHOLE COVERS AS MANUFACTURED BY CAMPBELL FOUNDRY PATTERN #4428 OR EQUAL WITH OUTSIDE COVER DIAMETER OF 31-3/4 INCHES AND INSIDE COVER DIAMETER OF 24
- THE LETTERS "JCMUA" AND "SEWER" SHALL BE CAST IN THE INSIDE COVER. MANHOLE FRAMES SHALL BE CAMPBELL FOUNDRY CO. PATTERN #4428 OR 1206 OR EQUAL FURNISHED WITH A PATTERN #4428 CONCENTRIC COVER AS SPECIFIED IN THE PRECEDING PARAGRAPH.
- REFER TO THE JCMUA'S STANDARD DETAIL FOR MANHOLE FRAMES AND COVERS.
- THIS DOES NOT APPLY TO THIS APPLICATION.
- 10. STORM INLETS WHICH ARE CONNECTED DIRECTLY TO JCMUA COMBINED SEWERS MUST BE FURNISHED WITH A SUMP AND TRAP AS PER JCMUA STANDARD DETAILS.
- THIS DOES NOT APPLY TO THIS APPLICATION.
- 11. THE JCMUA HAS A COMBINED SEWER SYSTEM WHICH SURCHARGES DURING WET-WEATHER PERIODS, RESULTING IN POSSIBLE SEWER BACK-UPS THROUGH PLUMBING FIXTURES (SINKS, TOILETS, FLOOR DRAINS, ETC.) BELOW STREET LEVEL. THIS POSSIBILITY MUST BE ADDRESSED DURING THE DESIGN/CONSTRUCTION PHASE.
- THE APPLICANT IS AWARE OF THE LIMITATIONS OF THE CITY'S INFRASTRUCTURE. ALL OF PLUMBING FIXTURES IN THIS ADDITION HAVE BEEN DESIGNED ABOVE THE STREET LEVEL.

- 12. <u>A DROP MANHOLE CONNECTION SHALL BE USED WHERE THERE IS A DIFFERENCE IN ELEVATION OF TWO (2) FEET OR</u> GREATER BETWEEN THE INVERT OF A SANITARY OR COMBINED INLET PIPE TO MANHOLE AND THE CROWN OF THE OUTLET PIPE FROM MANHOLE. REFER TO ATTACHED JCMUA'S STANDARDS DETAIL FOR DROP MANHOLE CONNECTION WHICH MUST BE SHOWN ON THE PLANS IF REQUIRED.
- NO DROP MANHOLES ARE REQUIRED OR PROPOSED AS A PART OF THIS PROJECT.
- 13. TEST PITS MUST BE PERFORMED AT THE DEVELOPER'S EXPENSE DURING THE DESIGN PHASE OF THE PROJECT TO ENSURE THAT PROPOSED SEWERS AND SEWER SERVICES MAY BE CONSTRUCTED AS PROPOSED WITHOUT CONFLICTING WITH OTHER UNDERGROUND UTILITIES OR STRUCTURES
- THE CONTRACTOR SHALL BE RESPONSIBLE FOR COMPLYING WITH THIS REQUIREMENT IF ANY EXISTING SEWER LATERALS ARE UNCOVERED DURING EXCAVATION. NONE ARE KNOWN TO EXIST.
- 14. <u>ALL EXISTING SEWER MAINS AND STORM</u> AND SANITARY LATERALS TO BE ABANDONED MUST BE FILLED WITH CONCRETE SLURRY OR REMOVED FROM THE GROUND. CATCH BASINS AND MANHOLES MUST BE REMOVED FROM THE GROUND. <u>CONNECTIONS MUST BE CUT AND SEALED AT THE MAIN AND PRECAUTIONS MUST BE UNDERTAKEN BY THE CONTRACTOR TO</u> ENSURE CONCRETE AND OTHER MATERIALS DO NOT ENTER THE MAIN AND CREATE OBSTRUCTION(S).
- THE CONTRACTOR SHALL BE RESPONSIBLE FOR COMPLYING WITH THIS REQUIREMENT IF ANY EXISTING SEWER LATERALS ARE UNCOVERED DURING EXCAVATION.
- 15. <u>ALL PROPOSED INLETS/CATCH BASINS MUST BE CONSTRUCTED WITH A BICYCLE SAFE GRATE AND CAMPBELL FOUNDRY</u> <u>CO. TYPE 'N' CURBPIECE WHERE REQUIRED.</u>
- THIS DOES NOT APPLY TO THIS APPLICATION
- 16. PROPOSED WATER SERVICES REQUIRE THE REVIEW AND APPROVAL OF THE DIVISION OF WATER ENGINEERING.
- THE APPLICANT IS AWARE OF THIS REQUIREMENT AND HAS APPLIED SEPARATELY FOR THEIR WATER SERVICE CONNECTION.
- 17. THE CONTRACTOR IS RESPONSIBLE FOR OBTAINING PERMITS FOR STREET OPENINGS (EXCAVATIONS) AND SEWER SERVICE CONNECTIONS FROM THE JERSEY CITY BUILDING DEPARTMENT LOCATED AT 30 MONTGOMERY STREET, JERSEY
- THE APPLICANT IS AWARE OF THIS REQUIREMENT AND MUST APPLY FOR ALL REQUIRED STREET OPENING PERMITS.
- THE SYSTEM DESIGNER IS ALSO RESPONSIBLE FOR COMPLIANCE WITH THE APPLICABLE REGULATIONS OF THE NEW JERSEY ADMINISTRATIVE CODE, NJDEP RULES AND REGULATIONS GOVERNING TREATMENT WORKS APPROVAL PROGRAM, PROGRAM, LOCAL CODES AND ORDINANCES, FEDERAL AND STATE REGULATIONS, ETC. IN ADDITION TO OTHER REQUIREMENTS THAT MAY

TEE SADDLE

SECTION A-A

CONFIGURATION)

THE ENGINEER CERTIFIES THAT THIS PLAN COMPILES WITH ALL REGULATIONS OF OTHER PUBLIC AGENCIES HAVING JURISDICTION.

EXISTING SEWER MAD


TYPICAL CONNECTION TO PVC,

CLAY OR DUCTTILE SEWER DETAIL


WYE SADDLE

NOT TO SCALE

NOT TO SCALE

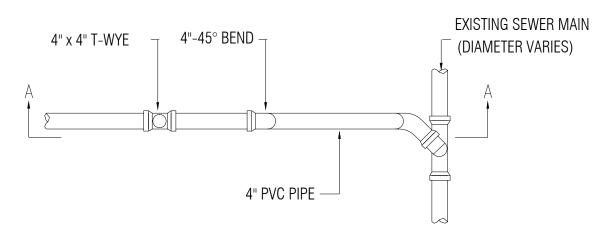

## TYPICAL CONNECTION TO PVC SEWER DETAIL

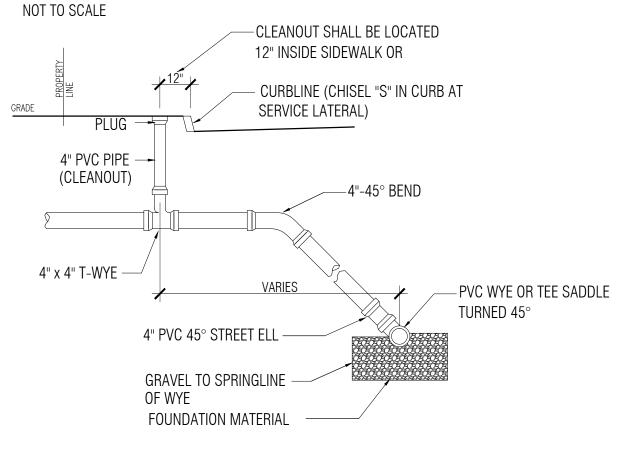

## PROFILE OF TYPICAL SEWER LINE


4" MIN. CONCRETE

- BOTTOM OF PIPE TRENCH

EXISTING OR - NEW REINFORCED CONCRETE PIPE


(DIAMETER VARIES)

NOT TO SCALE

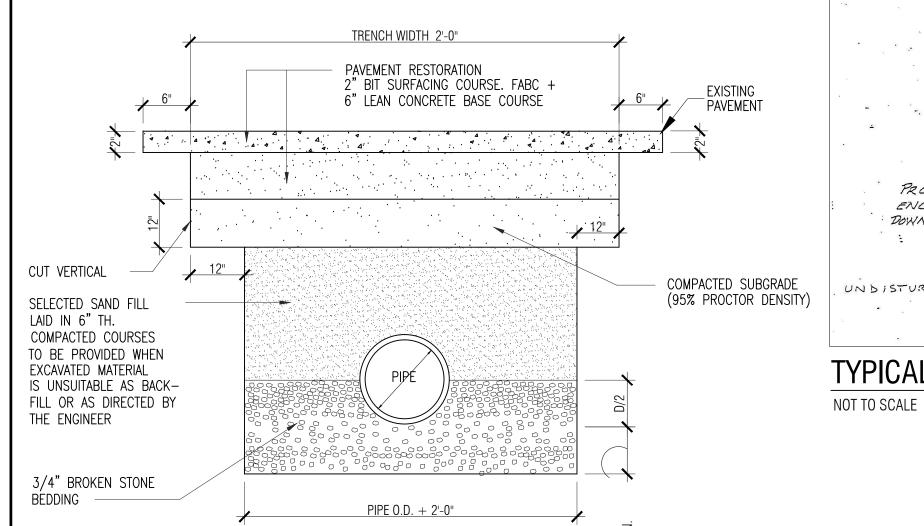

PROPOSED STAIN LESS STEEL - SAWCUT HOLE IN EXISTING SEWER CLEAVIS HANGER -PROPOSED 4"ORG" SERVICE . -EXISTING BRICK SEWER . (SIZE + SHAPE VARIES) HON SHRINK GROUT MUST PROPOSED CONC. ENCASEMENT IN BETWEEN LATERAL -DOWN TO SUBGRADE BRICK WALL UNDISTURBED SUBGRADE -

TYPICAL CONNECTION TO CONCRETE BRICK SEWER DETAIL

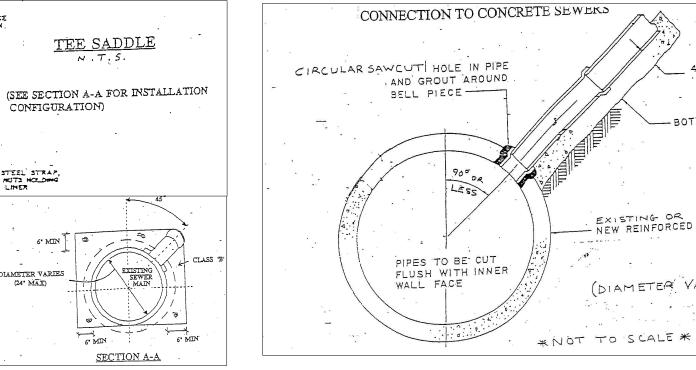


TYPICAL CONNECTION TO **CONCRETE SEWER DETAIL** 


2. INSTALL C.O AS INDICATED ON PLAN

ROLL IT PROPERLY.

- 1. SUBBASE SHALL BE FIRM AND APPROVED BY THE ENGINEER OR HIS
- REPRESENTATIVE PRIOR TO POURING. 2. CONTRACTOR MUST PROVIDE SQUARE AND UNIFORM PAVEMENT CUT
- PRIOR TO PAVEMENT REPACEMENT.
- 3. REMOVE 6" WIDTH AND 2" THICK TOP SURFACE LAYER BEYOND TRENCH WIDTH 4. CONSTRUCT: PUT TACK COAT ALONG VERTICAL & HORIZONTAL SURFACES 5. CONSTUCT: 2" THICK BITUMINOUS CONCRETE SURFACE COURSE AND

## PIPE INSTALLATION & PAVEMENT RESTORATION NOT TO SCALE

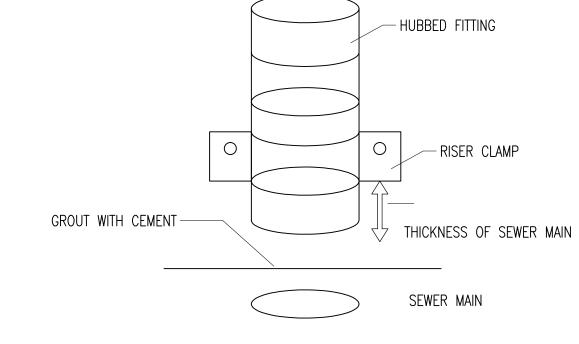

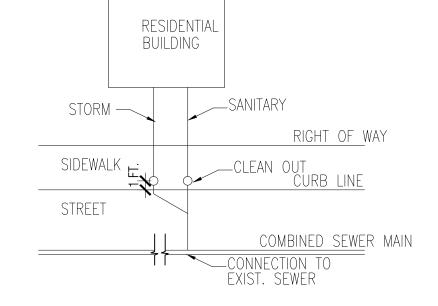

SEWER CONNECTION DETAIL FOR RESIDENTIAL DWELLING NOT TO SCALE


OTHER SUITABLE MATERIAL. AN ASSEMBLY CONSISTING OF A HUBBED FITTING AND A RISER CLAMF THE JCMUA'S SEWER IS EQUAL TO THE THICKNESS OF THE MAIN AS SHOWN IN THE ABOVE

MAKE THE OPENINGS IN THE EXISTING SEWER TO RECEIVE THE ASSEMBLY. THE DIAMETER OF THE

HOLE IN THE SEWER MAIN TO ACCEPT THE NEW LATERAL SHALL BE NO MORE THAN 1/8-INCH

NOT TO SCALE

WIDER THAN THE PIPE TO BE INSERTED INTO THE SEWER.

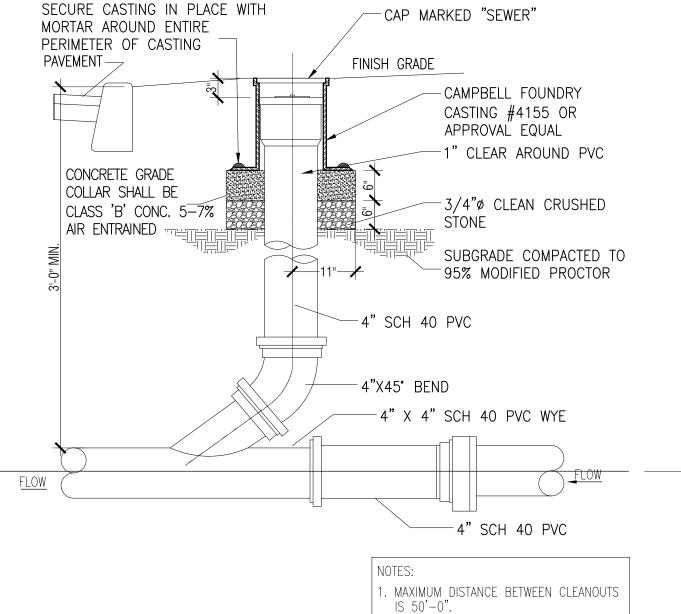

NEW 4"Ø SANITARY SEWER LATERAL & CLEANOUT

NOT TO SCALE

SECURE CASTING IN PLACE WITH -CAP MARKED "SEWER" MORTAR AROUND ENTIRE PERIMETER OF CASTING PAVEMENT — FINISH GRADE CASTING #4155 OR APPROVAL EQUAL 1" CLEAR AROUND PVC CONCRETE GRADE COLLAR SHALL BE 3/4"ø CLEAN CRUSHED CLASS 'B' CONC. 5-7%AIR ENTRAINED SUBGRADE COMPACTED TO 95% MODIFIED PROCTOR -4" SCH 40 PVC -4"X45° BEND -4" X 6" SCH 40 PVC WYE <u>FLOW</u> -6"SCH 40 PVC . MAXIMUM DISTANCE BETWEEN CLEANOUTS

NEW 6"Ø STORM SEWER LATERAL & CLEANOUT

IS 50'-0".

. INSTALL C.O AS INDICATED ON PLAN

SHEET No.

TYPICAL SEWER CONNECTION

NOTES AND DETAILS

07.13.2020

HAMPTON HILL

ARCHITECTURE

346 Virginia Avenue

201.401.0954. TEL

SEAL:

Jersey City, NJ 07304

mnaval2@comcast.net

bob.a@hamptonhillnj.com

m.kil@hamptonhillnj.com

Registered Architect: NJ LIC 21 AI 019B85300

THIS DOCUMENT IS THE EXCLUSIVE

PROPERTY OF HAMPTON HILL

ARCHITECTURE. THE DOCUMENT AND

THE INFORMATION IT CONTAINS MAY

NOT BE REPRODUCED OR USED FOR

OTHER THAN THE SPECIFIC PROJECT

FOR WHICH IT WAS PREPARED

WITHOUT THE EXPLICIT CONSENT OF

HAMPTON HILL ARCHITECTURE.

PROPOSED

**NEW FOUR** 

**DWELLING** 

145 BERGEN AVENUE

JERSEY CITY,

**NEW JERSEY** 

BLOCK: 18402

LOT:36

**REVISIONS:** 

DRAWN BY

CHKD BY: ISSUE DATE:

PROJECT NO

SHEET TITLE:

## REQUIREMENTS FOR FIRE AND DOMESTIC WATER LINE AND METER INSTALLATIONS

1. ALL FIRE SERVICE APPLICATIONS AND ALL DOMESTIC SERVICE APPLICATIONS TWO (2) INCHES AND LARGER MUST BE SUBMITTED TO THE JCMUA'S BUREAU OF WATER ENGINEERING FOR APPROVAL. FIVE(5) SETS OF PLANS SHALL BE SUBMITTED FOR APPROVAL. ALL PLANS SHALL BE SIGNED AND SEALED BY A PROFESSIONAL ENGINEER OR REGISTERED ARCHITECT LICENSED TO PRACTICE IN NEW JERSEY.

2. SUBMITTED PLANS SHALL BE STANDARD ENGINEERING DRAWINGS, SIZE 24 INCHES X 36 INCHES. INCLUDED SHALL BE A SITE PLAN SHOWING ADJACENT STREETS WITH WATER MAIN, SERVICE, AND DETAILS INDICATED. ALSO INCLUDED SHALL BE A KEY MAP SHOWING GENERAL LOCATION WITHIN THE CITY.

3. INDICATED ON THE SUMITTED PLANS SHALL BE THE SIZE OF TAP, LOCATION OF TAPPING AND CURB GATE VALVES, DETAILED METER SET-UP, AND SIZE OF FACILITY'S METER. ALSO INDICATED ON THE PLANS SHALL BE THE TYPE OF OCCUPANCY OF THE FACILITY RECEIVING THE WATER SERVICE. (I.E. HOSPITAL, WAREHOUSE, APARTMENT BUILDING, ETC.)

4. ALL EXISTING WATER SERVICE LINES TO BE ABANDONED SHALL BE CUT AND CAPPED AT THE MAIN, IN ACCORDANCE WITH JCMUA STANDARDS, AND INSPECTED WITHIN 24 HOURS AFTER INSTALLTION OF NEW TAP. THE MAXIMUM OF ONE(1) TAP SHALL BE MADE FOR DOMESTIC AND FIRE SERVICE PER FACILITY. THE TAP SHALL BE THE MAXIMUM OF ONE (1) SIZE SMALLER THAN THE CITY'S WATER MAIN. NO TAPPING SHALL BE DONE BY ANYONE EXCEPT BY UNITED WATER JERSEY CITY (UWJC) UNLESS SPECIFICALLY APPROVED BY JCMUA.

5. ONLY ONE DOMESTIC/ FIRE SERVICE IS ALLOWED FOR EACH FACILITY. APPLICANT MAY INSTALL CHECK METER ON INDIVIDUAL BRANCH CONNECTIONS DOWNSTREAM OF DOMESTIC METER SETUP WHERE THERE IS MORE THAN ONE OWNER/ TENANT FOR A FACILITY. HOWEVER, ONLY ONE WATER BILL WILL BE ISSUED FOR THE FACILITY.

6. A SOLID DUCTILE IRON TAPPING SLEEVE SUCH AS MUELLER H-615 TAPPING SLEEVE OR APPROVED EQUAL SHALL BE UTILIZED FOR ALL TAPS 2-INCHES AND LARGER. THE TAPPING SLEEVE SHALL PASS PRESSURE TESTING BASED ON AWWA STANDARDS BEFORE TAP IS MADE.

7. FOR ALL SERVICES INCLUDED HEREIN, TWO (2) GATE VALVES ARE REQUIRED THAT ARE TO BE INSTALLED BY THE APPLICANT; A TAPPING VALVE, LOCATED AT THE TAP AND CURB VALVE, LOCATED IN THE SIDEWALK BEFORE THE METER. TAPPING GATES SHALL BE FURNISHED OPENED RIGHT. ALL TAPPING AND CURB VALVUES SHALL BE DOUBLE DISC GATE VALVES AND MEET AWWA STANDARDS. THE WET TAP UP TO 12 INCHES SHALL BE PERFORMED BY UWJC.

8. FOR TAPS OFF MAINS SIXTEEN (16) INCHES AND LARGER, THE APPLICANT SHALL FURNISH AND INSTALL AN ADDITIONAL GATE VALVE ADJACENT TO THE TAPPING VALVE. NO TAPS SHALL BE PERMITTED ON MAINS LARGER THAN TWENTY (20) INCHES UNLESS THERE IS NO ALTERNATIVE WATER SOURCE, AND SPECIAL WRITTEN APPROVAL IS ISSUED BY THE JCMUA.

9. VALVE BOX PARTS FOR ALL VALVES SHALL BE PROVIDED BY THE APPLICANT. ALL TAPPING GATE VALVES LARGER THAN 2-INCHES AND ALL CURB VALVES/ STOPS REGARDLESS OF SIZE REQUIRE A VALVE BOX WITH THE WORD "WATER" CAST IN THE COVER. BURIED CORPORATION VALVES/ STOPS SHALL BE USED AT THE TOP FOR CLASS K COPPER SERVICES 2-INCHES AND SMALLER.

10. ALL SERVICE PIPES, SIZES 2-INCHES THROUGH 12-INCHES, SHALL BE PRESSURE CLASS 350 PSI, CEMENT-LINED DUTILE IRON PIPES WITH MECHANICAL JOINTS.

11. THE APPLICANT SHALL INSTALL THE METER INSIDE THE BUILDING. IF THE BUILDING LINE IS IN EXCESS OF 75FT. FROM THE MAIN, THE APPLICANT SHALL PLACE THE METER IN A PIT NEAR THE SIDEWALK OR STREET IN CLOSE PROXIMITY TO

12. FOR A REGULAR FIRE SUPPRESSION SYSTEM (COMBINED SERVICE LINE LARGER THAN 2"), A COMBINED REDUCED PRESSURE DETECTOR ASSEMBLY (AMES 5000 SS, AMES 5000 RPDA OR WATTS 909 RPDA\*) SHALL BE INSTALLED ON THE MAIN FIRE SERVICE LINE AND A REDUCED PRESSURE BACKFLOW PREVENTOR ON THE BYPASS (AMES 4000 SS OR WATTS 909\*). ON THE LIMITED FIRE SUPPRESSION SYSTEM (COMBINED SERVICE LINE 1.5" OR 2"), A FIRE LINE SETECTOR CHECK WITH A SINGLE CHECK VALVE (AMES 1000 DCV\*)SHALL BE INSTALLED ON THE MAIN FIRE LINE AND A REDUCED PRESSURE BACKFLOW PREVENTOR (AMES 4000 SS OR WATTS 909\*) SHALL BE INSTALLED DOWNSTREAM OF THE BYPASS. ALL REGULAR FIRE SUPPRESSION SYSTEMS MUST HAVE OS&Y VALVES, HOWEVER, LIMITED FIRE SUPPRESSION SYSTEMS MAY USE BALL VALVES (VICTAULIC SERIES 728 FIRELOCK\*) INSTEAD OF OS&Y VALVES. THE FIRE UNIT SHALL BE FURNISHED WITH A 5/8 INCH X 3/4 INCH METERED BYPASS. BYPASS METERS SHALL BE JERSEY CITY STANDARD SINGLE DISPLACEMENT SENSUS METERS WITH TOUCHPAD AND RADIIO READ CAPABILITES. THE SAME RADIO MXU UNIT SHALL BE USED FOR A COMBINED DOMESTIC AND

13. FOR DOMESTIC SERVICE, AN APPROVED REDUCED PRESSURE BACKFLOW PREVENTER (AMES 4000 SS OR WATTS 909\*) IS REQUIRED WHEN THE JCMUA DETERMINES THAT THERE IS A CROSS-COONECTION HAZARD AND THE FACILITY PRESENTS A THREAT TO THE CITY'S DISTRIBUTION SYSTEM WATER QUALITY IN ACCORDANCE WITH THE PLUMBING SUBCODE OF THE NEW JEREY STATE UNIFORM CONSTRUCTION CODE, NJAC 5:23-3.15 AND THE NEW JERSEY SAFE DRINKING WATER ACT NJAC 7:10-10 PHYSICAL CONNECTIONS AND CROSS CONNECTIONS CONTROL BY CONTAINMENT. SOME SERVICES WHICH REQUIRE SUCH DEVICES INCLUDE: A HOSPITAL, SCHOOL, CHEMICAL PLANT, FACTORY, AND FACILITY WITH SEWAGE EJECTORS.

14. IF A REDUCED PRESSURE BACKFLOW PREVENTER IS NOT REQUIRED ON THE DOMESTIC SERVICE, A CHECK VALVES SHOULD BE INSTALLED DOWNSTREAM OF THE TEST TEE.

15. ALL METERS SIZES 2 INCHES THROUGH 6 INCHES SHALL BE SINGLE COMPOUND METERS AND ALL METERS 8 INCHES AND LARGER SHALL BE DUPLEX COMPOUND MANIFOLD METERS.

16. ALL METERS SHALL BE ADEQUATELY RESTRAINED WITH METAL BRACKETS FASTENED TO THE FLOOR OR WALL OR OTHER APPROVED MEAS SUCH AS UNIFLANGES WHERE INTERNAL PIPES PRESSURE AND FLOW WARRANT SUCH RESTRAINTS. METERS. DETECTOR CHECKS, AND VALVES MAY BE SEATED ON CONCRETE BLOCK AND TAPERED SHIMS TO PROVIDE ADEQUATE SUPPORT. METERS SHALL BE INSTALLED APPROXIMATELY 36" ABOVE FLOOR GRADE.

17. ALL METER INSTALLATIONS IN METER PIT OR VAULT SHALL BE PRE-APPROVED BY JCMUA AND HAVE PROPER ACCESS OPENINGS FOR METER READING AND REPLACEMENT.

18. EACH COMPOUND METER SHALL HAVE STRAINER INSTALLED ON THE INLET SIDE IMMEDIATELY BEFORE THE METER. ALL STRAINERS MUST BE PURCHASED FROM JCMUA OR ITS AUTHORIZED AGENT.

19. ALL METERS 2" AND LARGER SHALL BE FURNISHED WITH SENSUS ECR/WP REMOTE TOUCH PAD MODULES AND RADIO MXU UNITS FOR BOTH TYPES OF READING CAPABILITIES.

20. REMOTE TOUCH PAD MODULE WIRE SHALL BE CONECTED TO THE METER REGISTER UTILIZING A GEL CAP FOR WATERTIGHT SEALING OF ALL TERMINAL CONNECTIONS. TOUCH PADS MAY BE WALL MOUNTED OR LID MOUNTED WHERE A METER PIT IS UTILIZED. TOUCH PADS ARE TO BE INSTALLED ON EXTERIOR BUILDING WALL FACING THE STREET AND LOCATED AS CLOSE AS POSSBILE TO STREET. THE RADIO MXU UNIT MUST BE INSTALLED WITH MOUNTING BRACKET AND LIKEWISE IS TO BE INSTALLED IN PROXIMITY TO STREET.

21. ALL INSTALLATIONS OF EQUIPMENT AND COMPONENTS SHALL BE PERFORMED IN ACCORDANCE WITH MANUFACTURER'S RECOMMENDATIONS.

22. ALL METERS INCLUDING TOUCH PAD MODULES, AND RADIO MXU UNITS SHALL BE PURCHASED THROUGH THE PERMIT CLERK AT JCMUA OFFICE. APPROVED PLANS MUST BE SUBMITTED TO THE PERMIT CLERK FOR ISSUANCE OF REQUIRED

23. AFTER OBTAINING THE REQUIRED PERMITS (STREET OPENING, TAP, AND METER) THE APPLICANT SHALL CALL UWJC AT (201) 239-1108 TO SCHEDULE THE TAP. THE EXCAVATION SHALL BE COMPLETED TWENTY-FOUR (24) HOURS PRIOR TO THE SCHEDULED TAP, AND VERIFIED BY JCMUA OR ITS AUTHORIZED AGENT BEFORE THE TAP WILL BE INSTALLED. EXCAVATION SHALL BE CONSTRUCTED IN ACCORDANCE WITH OSHA REQUIREMENTS FOR SHEETING AND SAFETY.

24. UPON COMPLETION OF TYHE INSTALLATION, THE APPLICANT SHALL SUBMIT THREE (3) SETS OF "AS BUILT" PLANS, TO THE JCMUA'S BUREAU OF WATER ENGINEERING. THE JCMUA WILL AUTHORIZE SUPPLY WATER UPON ACCEPTANCE OF THE "AS BUILT" DRAWINGS.

\*SPECIFIED MODEL OR APPROVED EQUAL.

REVISED 06/28/06

## JCMUA WATER DISTRIBUTION SYSTEM STANDARDS

- 1. WATER MAINS SHALL BE PSI CLASS 350, CEMENT LINED, DUCTILE IRON PIPE WITH MECHANICAL JOINTS AND SHALL BE IN CONFORMANCE WITH A.M.S.I. STANDARD A21.5-1976 (A.W.W.A. C151-76).
- 2. GATE VALVES SHALL BE IN CONFORMANCEWITH A.N.S.I./A.W.W.A. STANDARD C500-80 AND SHALL BE JERSEY CITY STANDARD VALVES, M&H METROPOLITAN MECHANICAL JOINT SHALL BE FURNISHED WITH A (2") SQUARE OPERATING NUT SHALL OPEN BY TURNING TO THE RIGHT. GATE VALVES (16") AND OVER SHALL BE FURNISHED WITH BY-PASS. VALVE SHALL BE 100% SOLID HEAT CURED EPOXY COATED HOLIDAY-FREE IN THE WATERWAY.
- 3. BUTTERFLY VALVES SHALL BE IN CONFORMANCE WITH A.N.S.I./A.W.W.A. STANDARD C504-80. BUTTERFLY VALVES SHALL BE CLASS 1508, MECHANICAL JOINT, WITH RUBBER SEAT MOUNTED ON THE DISC, SHALL BE FURNISHED WITH A (2") INCH SQUARE OPERATING NUT AND SHALL OPEN BY TURNING TO THE RIGHT. THE VALVE SHALL BE100% SOLID HEAT CURED EPOXY OATED HOLIDAY FREE IN THE WATERWAY. THE USE OF BUTTERFLY VALVES WILL NOT BE PERMITTED IN MAINS (16") AND UNDER.
- 4. VALVES BOXES SHALL BE JERSEY CITY "STANDARD" AS MANUFACTURED BY BINGHAM AND TAYLOR, OR APPROVED EQUAL. BOXES SHALL HAVE A MINIMUM OF 9 1/2" DIAMETER AND SHALL BE CAST IRON WITH A STANDARD COAL TAR FOUNDRY DIP WITH CAST IRON WATER DROP COVER AND THE WORK "WATER" CAST IN COVER. VALVE BOX COVER SHALL BE INSTALLED FLUSH WITH THE EXISTING GRADE ELEVATION.
- 5. CONCRETE FOR VALVE SEATS AND THRUST BLOCKS SHALL HAVE A MINIMUM 28 DAY STRENGTH OF 3000 PSI.
- 6. SELECT GRANULAR BACKFILL MATERIAL SHALL BE SOIL AGGREGATE TYPE I-6 (POROUS FILL, CLEAN SAND, GRAVEL OR STONE) OBTAINED FROM DRY SOURCES AND SHALL CONFORM TO TABLE 901-2, FOR TYPE I-6 IN ARTICLE 901.09 OF THE (NJDOT) NEW JERSEY DEPARTMENT OF TRANSPORTATION STANDARD SPECIFICATIONS. BACKFILL MATERIAL SHALL BE PLACED AND COMPACTED IN TWELVE (12) INCH LIFTS.
- 7. TIE RODS SHALL BE THREE QUATER (3/4) INCH DIAMETER THREADED STEEL BARS. RODS SHALL HAVE A MINIMUM YIELD STRESS OF 36,000 PSI.
- 8. COUPLINGS SHALL BE DRESSER STYLE NUMBER 153 FOR PIPE SIZES THROUGH (30") INCH DIAMETER. FOR LARGER DIAMETER PIPE, DRESSER STYLE NUMBER 38 STEEL COUPLINGS SHALL BE USED.
- 9. SHEETING, SHORING AND BRACING SHALL BE CLOSED VERTICAL SHEETING. TONGUE AND GROOVE WHICH IS BRACED TO PREVENT THE CAVE—IN OF TRENCHES. ALL LABOR EQUIPMENT, MATERIALS AND METHODS OF CONSTRUCTION SHALL BE TONGUE AND GROOVE WOODEN PLANKS AND TIMBER OR STEEL CONFORMING TO THE REQUIREMENTS OF THE UNITED STATES OCCUPATIONAL SAFETY AND HEALTH ADMINISTRATION TIMBER SHALL BE A MINIMUM OF 3" THICK. SHEETING SHALL BE LEFT IN PLACE. SHORING AND BRACING REMOVED.
- 10. BROKEN STONE FOUNDATION CUSHION SHALL BE PLACED IN THOSE AREAS WHERE THE DIRECTOR, DEPARTMENT OF ENGINEER FOR SIZE NUMBER 2,4,5, OR 6 AS SHOWN IN TABLE 901-1. STANDARD SIZES OF COURSE AGGREGATES OF THE NEW JERSEY DEPARTMENT OF TRANSPORTATION STANDARD SPECIFICATIONS.
- 11. FILTER CLOTH SHALL BE PLACED IN THOSE AREAS WHERE THE DIRECTOR, DEPARTMENT OF ENGINEERING HAS DEEMED TH SOIL CONDITIONS INFERIOR.
- 12. AFTER THE ENGINEER HAS INSPECTED THE COMPLETED INSTALLATION OF VALVES, AND WATER MAIN, AND BEFORE BACKFILLING THE EXCAVATIONS, THE CONTRACTOR SHALL BE PRESSURIZED TO 1.5X THE WORKING PRESSURE FOR A PERIOD OF 2 HOURS. PRESSURE SHALL NOT VARY MORE THAN 5 PSI. THE VALVED SECTION OF PIPE SHALL BE FILLED WITH WATER SLOWLY, AND THE TEST PRESSURE SHALL BE APPLIED BY MEANS OF A PUMP CONNECTED TO THE PIPE IN A MANNER SATISFACTORY TO THE ENGINEER. BEFORE APPLYING THE TEST PRESSURE, AIR SHALL BE EXPELLED AS THE LINE IS FILLED WITH WATER. IF THE JOINTS LEAK, REPAIRS OR REPLACEMENTS SHALL BE MADE. TESTING SHALL BE IN CONFORMANCE WITH A.W.W.A. STANDARD C600-77.
- 13. THE CONTRACTOR SHALL DISINFECT ALL WATER MAINS IN ACCORDANCE WITH A.W.W.A. STANDARD FOR "DISINFECTING WATER MAINS" DESIGNATION C-601. COMMERCIAL PRODUCTS SUCH AS "HTH", "PERCHLARON", AND "MAXOXHLOR" MAY BE USED IN THE CHLORINE DOSAGE SHALL INITIALLY PRODUCE 50 PPM RESIDUAL TO THE WATER AND MAINTAIN A MINIMUM RESIDUAL OF 25 PPM AFTER 24 HOURS. AFTER SATISFACTORY DISINFECTION OF THE RESIDUAL OF THE SYSTEM, WHICHEVER IS GREATER. AFTER FINAL FLUSHING AND BEFORE THE WATER MAIN IS PLACED IN SERVICE SAMPLES SHALL BE COLLECTED FROM EACH END OF THE MAIN AND TESTED FOR BACTERIOLOGIC QUALITY. IF THE INITIAL DISINFECTION FAILS TO PRODUCE SATISFACTORY SAMPLES, DISINFECTION SHALL BE REPEATED UNTIL SATISFACTORY SAMPLES HAVE BEEN OBTAINED.
- 14. AIR RELEASE VALVES SHALL BE INSTALLED AT THE HIGH POINTS OF THE WATER MAINS.
- 15. ALL WATER MAINS WILL BE AT LEAST 8" IN DIAMETER. TEN (10") AND 14" DIAMETER MAINS SHALL NOT BE USED.
- 16. THRUST BLOCKS AND TIE RODS SHALL BE INSTALLED AT ALL BENDS AND FITTINGS.
- 17. HYDRANTS SHALL BE 2 PIECE "JERSEY CITY STANDARD" HYDRANTS AS MANUFACTURED BY A.P. SMITH OR APPROVED EQUAL. HYDRANT SPACING SHALL BE A MAXIMUM 250 FEET MEASURED CENTER TO CENTER.
- 18. FOR EITHER NEW CONSTRUCTION OR RELOCATION OF THE FOLLOWING SHALL BE REQUIRED:
- HYDRANTS SHALL BE LOCATED NO CLOSER THAN 20 FEET FROM THE POINT OF TANGENCY OR CURVATURE AT INTERSECTIONS. B. ALL ONE PIECE OR HYDRANTS NOT MANUFACTURED BY A.P. SMITH THAT ARE TO BE RELOCATED SHALL BE REMOVED AND DELIVERED TO JERSEY CITY DIVISION OF WATER DISTRIBUTION. A NEW HYDRANT WILL BE SUPPLIED BY THE CITY FOR INSTALLATION. C. HYDRANTS SHALL BE NO CLOSER THAN TEN (10) FEET FROM THE EDGE OF A RESIDENTIAL DRIVEWAY OR (20) FEET FROM THE EDGE OF A COMMERCIAL DRIVEWAY. IN THE CASE WHERE DRIVEWAY. IN THE CASE WHERE DRIVEWAY OR (20) FEET FROM THE EDGE OF A COMMERCIAL DRIVEWAY. IN THE CASE WHERE DRIVEWAY.
- D. ALL SINGLE GATED HYDRANTS ON (16") OR LARGER MAINS SHALL REQUIRE A NEW VALVE AT THE BASE OF THE RELOCATED HYDRANT. E. NEW GATE VALVES AND BOXES ARE REQUIRED AT THE BASE OF RELOCATED HYDRANTS WHEN MORE THAN (10) FEET OF PIPE IS REQUIRED.
- 19. EXISTING WATER SERVICE LINES SHALL BE SHUT-OFF AND CAPPED AT THE MAIN PRIOR TO THE INSTALLATION OF NEW WATER SERVICES. PRIOR TO NEW SERVICE TAP THE JERSEY CITY WATER DEPARTMENT SHALL INSPECT AND CERTIFY THE ABANDONED SERVICES.
- 20. WATER MAINS TO ABANDON SHALL BE CUT AND PLUGGED WITH REQUIRED FITTINGS, RODS AND CONCRETE AS CLOSE TO THE EXISTING MAIN IN SERVICE AS POSSIBLE.
- 21. ALL VALVES SHALL BE OPERATED BY JERSEY CITY WATER DEPARTMENT PERSONNEL. THE CONTRACTOR SHALL NOT BE PERMITTED TO OPERATE ANY VALVES. THE CONTRACTOR SHALL NOTIFY THE ENGINEER, IN WRITING FIVE DAYS IN ADVANCE OF VALVE OPERATING REQUIREMENTS.
- 22. FAILURE TO COMPLY WITH THE ABOVE REQUIREMENTS WILL RESULT IN THE IMMEDIATE SHUT-DOWN OF THE PROJECT.



HAMPTON HILI

Jersey City, NJ 07304 201.401.0954. TEL mnaval2@comcast.net bob.a@hamptonhillnj.com m.kil@hamptonhillnj.com

SEAL:


MIN W. KIL Registered Architect: NJ LIC 21 AI 019B85300

THIS DOCUMENT IS THE EXCLUSIVE PROPERTY OF HAMPTON HILL ARCHITECTURE. THE DOCUMENT AND THE INFORMATION IT CONTAINS MAY NOT BE REPRODUCED OR USED FOR OTHER THAN THE SPECIFIC PROJECT FOR WHICH IT WAS PREPARED WITHOUT THE EXPLICIT CONSENT OF HAMPTON HILL ARCHITECTURE.

**PROPOSED NEW FOUR DWELLING** 

145 BERGEN AVENUE JERSEY CITY, **NEW JERSEY** 

BLOCK: 18402

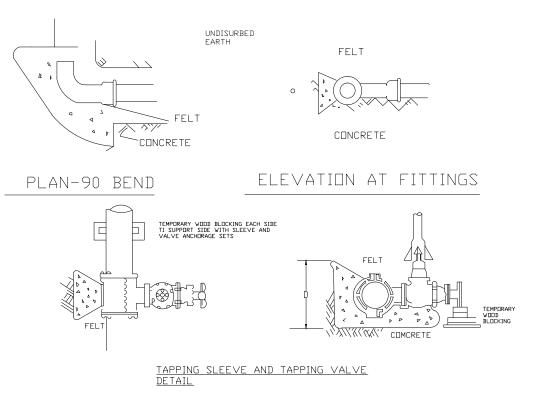

CONCRETE

V V A P P

PLAN-22 & BEND

CONCRETE

PLAN-45 BEND


PLAN-TEE

MIN 10'-0: PIPE SECTION

PLUG

10'-0" MIN

ELEVATION-PLUGGED PIPE

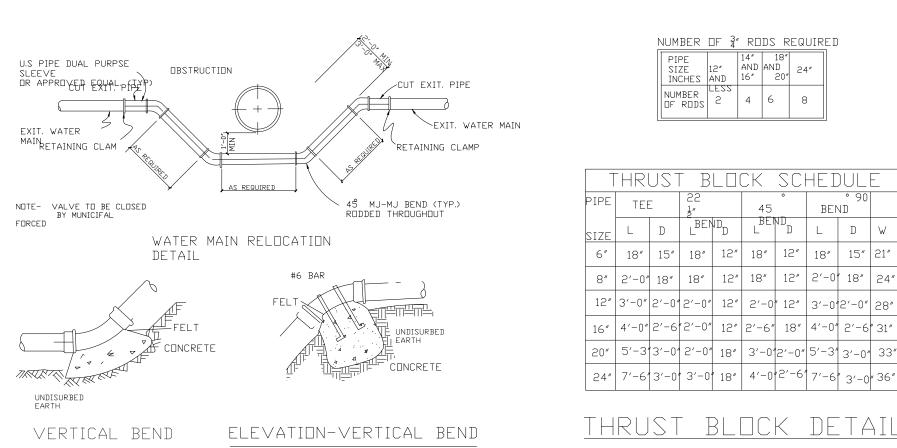

REVISIONS:

DRAWN BY: CHKD BY: ISSUE DATE: 07.13.2020 PROJECT NO: 19059

SHEET TITLE: TYPICAL WATER CONNECTION

NOTES AND SITE DETAILS

#### GENERAL PLANTING NOTES

- ALL PLANTS TO BE SELECTED AND SEALED IN THE FIELD BY THE CITY REPRESENTATIVE.
- 2. FINAL LOCATION OF ALL PLANTS TO BE DETERMINED IN THE FIELD BY THE CITY REPRESENTATIVE. CONTRACTOR SHALL INSTALL A PORTION OF THE LANDSCAPING CONSISTING OF NOT MORE THAN 5% OF THE TOTAL PLANTINGS, TO DEMONSTRATE PLANTING PRACTICES TO THE CITY REPRESENTATIVE, PRIOR TO INSTALLING THE REMAINDER OF THE PLANT MATERIAL.
- ALL PLANTS AND ENTIRE SHRUB BEDS TO RECEIVE 3" LAYER OF SHREDDED BARK MULCH.
- 5. TOPSOIL SHALL BE SANDY LOAM; FREE FROM SUBSOIL, STONES LARGER THAN 1", OR ANY UNDESIRABLE MATERIAL; CONTAIN 5%-12% ORGANIC MATTER, ph 6.0 TO 7.0, SEE BACK FILL REQUIREMENTS, JERSEY CITY FORESTRY STANDARDS. 6. TOPSOIL SHALL COMPLY WITH ANY AND ALL ENVIRONMENTAL AND CLEAN FILL REQUIREMENTS, TO
- THE SATISFACTION OF THE ENVIRONMENTAL CONSULTANT. 7. CUT AND REMOVE BURLAP FROM TOP 2/3 OF BALL AND REMOVE WIRE BASKET COMPLETELY. NYLON
- ROPE AND /OR NYLON BALLING MATERIAL IS NOT ACCEPTABLE. 8. LOCATE GUY WIRES SO THAT THEY WILL NOT PULL CROTCH APART.
- 9. UPON COMPLETION OF THE FIRST YEAR OF THE TWO (2) YEAR PLANT GUARANTEE PERIOD, THE CONTRACTOR IS RESPONSIBLE FOR ADJUSTING OR REMOVING ALL STAKES. THIS SHALL BE DONE IN CONSULTATION WITH THE CITY REPRESENTATIVE. ALL STAKES REMAINING SHALL THEN BECOME THE RESPONSIBILITY OF THE OWNER.
- 10. IF THERE IS A DISCREPANCY BETWEEN THE PLANT COUNT SHOWN IN THE PLANT LIST AND THE PLANTING GRAPHIC, THE GRAPHIC SHALL TAKE PRECEDENCE.
- 11. IF THE CONTRACTOR DETERMINES THE SUB-GRADE SOIL CONDITIONS ARE DELETERIOUS TO PLANT GROWTH OR WILL INHIBIT DRAINAGE, THE LANDSCAPE ARCHITECT SHALL BE NOTIFIED IMMEDIATELY AND PRIOR TO INSTALLATION OF PLANT MATERIAL.
- 12. PLANT PERENNIALS AND GROUNDCOVER IN 8' DEEP TOPSOIL BED CONSISTING OF % TOPSOIL AND % HUMUS. PLANT BULBS IN NATURALIZED DRIFTS
- 13. TOPSOIL AND SEED ALL AREAS DISTURBED AS A RESULT OF ANY AND ALL DISTURBANCES, CONSTRUCTION, OR STORAGE OF EQUIPMENT WHETHER SUCH AREAS ARE SHOWN ON THE PLANS OR
- 14. ALL EXISTING SOIL SHALL BE REMOVED AND BACK FILLED WITH NEW TOPSOIL MEETING PARKS AND
- FORESTRY SPECIFICATION. 15. ALL PLANT MATERIAL SHALL BE NURSERY GROWN AND SHALL CONFORM TO THE AMERICAN
- ASSOCIATION OF NURSERYMEN'S AMERICAN STANDARD FOR NURSERY STOCK.
- 16. ALL PLANT BEDS ARE TO BE SEPARATED FROM LAWN AREA WITH A 3" DEEP "V" TRENCH.
- 17. KEEP MULCH 1/2" BELOW TOP OF PAVEMENTS AND CURBS.
- 18. ALL LANDSCAPING SHALL BE IN A HEALTHY AND VIGOROUS GROWING CONDITION AT THE TIME OF INSTALLATION. NO PLANT SHALL REMAIN AT THE SITE FOR MORE THAN THREE (3) DAYS AFTER DELIVERY WITHOUT BEING PROPERLY HEALED IN. NO TREE WITH A DAMAGED CENTRAL LEADER SHALL RECEIVE FINAL ACCEPTANCE.
- 19. ALL NEWLY INSTALLED LANDSCAPING SHALL BE SET PLUMB IN THE PLANTING PIT AND BACKFILLED IN LIFTS NOT TO EXCEED EIGHT(8) INCHES. IN PLANTING BEDS BACKFILL SHALL CONSIST OF THREE(3) PARTS NATIVE TOPSOIL, THREE(3) PARTS SCREENED TOPSOIL AND THREE(3) PARTS PEAT. A MOISTURE ABSORBENT POLYMER SHALL BE INCLUDED IN THE AMENDED BACKFILL ON WELL AND EXCESSIVELY DRAINED SOILS AND ON EARTHEN BERMS TO ENSURE SOIL MOISTURE AVAILABILITY. ALL LANDSCAPE BEDS SHALL BE UNDERPLAYED WITH A SUITABLE WATER PERMEABLE WEED FABRIC AND SHALL RECEIVE A MINIMUM THREE (3) INCH APPLICATION OF SHREDDED HARD WOOD MULCH OR OTHER ACCEPTABLE MATERIAL, UNTREATED WOOD CHIPS SHALL NOT BE USED, PLANT MATERIAL ARRANGED IN GROUPINGS SHALL BE CONTAINED IN ONE(1) CONTINUOUS MULCHED BED TO REDUCE POSSIBLE PLANT DAMAGE CAUSED BY MAINTENANCE EQUIP. THE LANDSCAPE BED SHALL EXTEND TO THE BRANCH LIMITS OF THE NEWLY INSTALLED PLANTINGS.
- 20. PLANT MATERIAL CONSIDERED TO BE A FALL DIG HAZARD SHALL NOT BE DUG BETWEEN OCTOBER 1ST AND DECEMBER 1ST. FALL DIG HAZARD PLANTS MAY BE PLANTED DURING THIS TIME FRAME, PROVIDED THEY HAVE BEEN DUG PRIOR TO OCTOBER 1ST, OR ARE CONTAINER GROWN.
- 21. THE CLASSIFICATION OF A SPECIES AS A FALL DIG HAZARD SHALL NOT BE CONSIDERED A SUFFICIENT OR ACCEPTABLE REASON FOR SUBSTITUTION. THE CONTRACTOR SHALL BE RESPONSIBLE FOR COORDINATING THE PROCUREMENT OF PLANT MATERIAL AS REQUIRED TO MEET THE CONSTRUCTION SCHEDULE, AND FOR ENSURING THE SURVIVAL AND CONTINUED HEALTH OF THE PLANT MATERIAL, ONCE IT IS DELIVERED.

- 22. WATERING MUST TAKE PLACE THROUGHOUT THE 2 YEAR PERIOD, AT LEAST 20 GALLONS AT APPROXIMATELY TWO WEEK INTERVALS FROM MAY 15 TO OCTOBER 31. CONTRACTOR MAY NEED TO INCREASE OR REDUCE THE FREQUENCY OF WATERING BASED ON WEATHER CONDITIONS, RESULTING
- SOIL WATER CONTENT OR OTHER FACTORS. 23. EXISTING TREES TO REMAIN MAY BE PRUNED TO ACCOMMODATE CONSTRUCTION ACTIVITIES. CARE SHALL BE TAKEN TO AVOID NEGATIVELY IMPACTING THE HEALTH OR STRUCTURAL INTEGRITY OF THE TREE. PRUNING SHALL BE DONE UNDER THE DIRECTION OF A CERTIFIED NEW JERSEY TREE EXPERT.
- 24. NO SOIL DISTURBANCE SHALL OCCUR OUTSIDE THE LIMIT OF DISTURBANCE.
- 25. SHADE TREES SHALL BE LIMBED UP TO A HEIGHT OF 5'-0" 26. CONTRACTOR SHALL NOTIFY JERSEY CITY DIVISION OF PARKS AND FORESTRY 3 DAYS PRIOR TO BEGINNING PLANTING SHADE TREES.
- 27. ALL LANDSCAPING AREAS SHALL BE APPROPRIATELY PLANTED AND MAINTAINED WITH ANY DAMAGED, DISEASED OR DEAD MATERIAL REPLACED, ON AN ON-GOING BASIS.

#### LANDSCAPE MAINTENANCE NOTES:

- 1. FOR THE DURATION OF THE TWO (2) YEAR GUARANTEE PERIOD, THE CONTRACTOR SHALL MAINTAIN ALL PLANT MATERIAL, IN ACCORDANCE WITH THE LANDSCAPE SPECIFICATIONS AND TO THE SATISFACTION OF 8. MAINTENANCE TRACKING TAG SHALL BE ATTACHED TO STURDY THE CITY REPRESENTATIVE. ANY PLANT MATERIAL DETERMINED TO BE DEAD OR DYING AT THE CLOSE OF
- THE GUARANTEE PERIOD SHALL BE REPLACED AT THE EXPENSE OF THE CONTRACTOR. AT THE COMPLETION OF THE FIRST YEAR OF THE GUARANTEE PERIOD, THE CONTRACTOR SHALL REMOVE ALL STAKES AND GUY WIRES. THIS SHALL BE DONE IN CONSULTATION WITH THE CITY REPRESENTATIVE. ALL STAKES REQUIRED TO REMAIN IN PLACE PAST THE COMPLETION OF THE FIRST YEAR OF THE
- GUARANTEE PERIOD SHALL BECOME THE RESPONSIBILITY OF THE OWNER. FERTILIZE ALL TREES AND SHRUBS AT LEAST ONCE PER YEAR. MYCORRHIZAL FUNGI INNOCULANT SHALL
- BE APPLIED TO ALL TREES AND SHRUBS AT THE TIME OF PLANTING. 4. FERTILIZE ALL LAWN AREAS ONCE PER SEASON DURING THE SPRING, SUMMER, AND FALL. FERTILIZER SHALL BE A LOW PHOSPHORUS COMMERCIAL FERTILIZER, WITH A MINIMUM OF 7% NITROGEN BY WEIGHT, AS DESCRIBED IN THE LANDSCAPE SPECIFICATIONS.
- 5. PLANT MATERIAL SHALL BE INSPECTED FOR PEST DAMAGE AND INFESTATION AT REGULAR INTERVALS. APPLY PEST CONTROL MEASURES ACCORDING TO THE LIFE CYCLE OF THE PESTS. ALL PESTICIDES SHALL BE APPLIED BY A LICENSED PRACTITIONER.
- SEASONAL MAINTENANCE NECESSARY TO ENSURE HEALTHY AND VIGOROUS GROWTH OF PLANT MATERIAL AND TO MAINTAIN THE APPEARANCE OF THE LANDSCAPED AREAS SHALL BE PERFORMED AS
- NEEDED. PLANTING BEDS SHALL BE WEEDED AND EDGED AS NEEDED TO MAINTAIN A NEAT APPEARANCE AND TO PREVENT THE ESTABLISHMENT OF WEEDS.
- ALL MULCHED AREAS SHALL BE RAKED AND MULCH SHALL BE REPLENISHED AS NEEDED EACH SPRING. 9. PRUNING OF DEAD AND DAMAGED BRANCHES SHALL BE PERFORMED EACH FALL, AND AS NEEDED FOLLOWING DAMAGE TO PLANT MATERIAL
- 10. DEBRIS AND DEAD LEAVES SHALL BE REMOVED FROM PLANTING BEDS IN THE FALL AND EARLY SPRING.

#### TREE PLANTING NOTES:


- 1. GAS OR ELECTRIC LINES SHALL BE 2' MINIMUM FROM EDGE OF TREE PIT. OIL FILLED PIPES SHALL BE 4' MINIMUM FROM EDGE OF TREE PIT. WATER AND SEWER LINES SHALL BE 2' FROM TRUNK.
- 2. TREES SHALL NOT BE LOCATED IN FRONT OF DOORWAYS 3. MINIMUM RECOMMENDED DISTANCE FROM TREE TRUNK: 3.1. TO UTILITY POLES AND/OR LIGHTS SHALL BE 15'.
- 3.2. TO WATER MAIN OVER 20" DIA. SHALL BE 6'. 3.3. TO STREET SIGNS AND TRAFFIC SIGNS SHALL BE 51
- 3.4. TO CURB SHALL BE 7'.
- 3.5. TO FIRE HYDRANT SHALL BE 5'.
- 3.6. TO CURB OF NEAREST INTERSECTION SHALL BE 30'. 4. MINIMUM DISTANCE FROM EDGE OF TREE PIT TO NEAREST WALL
- OR FENCE SHALL BE 5'. 5. NO TREES SHALL BE INSTALLED BETWEEN UTILITY VAULTS AND
- 6. DO NOT PLANT NEW TREES UNDER OVERHEAD BRANCHES OF ADJACENT TREES.
- 7. TREE CROWN AND TRUNK SHALL BE FREE OF DEFECTS AND TRUE TO FORM.
- SCAFFOLD BRANCH.
- 9. NO PAVERS, 4 SIDED TREE GUARDS, OR OTHER MATERIALS SHALL BE PLACED WITHIN THE TREE BED.
- 10. CUT AND REMOVE BURLAP FROM TOP 2/3 OF ROOT BALL, REMOVE WIRE BASKET COMPLETELY.
- 11. FLOOD TREES WITH WATER WITHIN THE FIRST 24 HOURS OF 12. NSTALL <u>PHC TREE SAVER MYCORRHIZAL FUNGAL TRANSPLANT</u> INOCULANT FOR TREES AND SHRUBS. INSTALL ONE 3 OUNCE

PACKET PER CALIPER INCH OR PER 1 FOOT OF ROOTBALL DIA.

- 13. CONTRACTOR SHALL HAVE A GUARANTEE PERIOD OF 2 YEARS FOR EACH TREE PLANTED. 14. TOPSOIL SHALL COMPLY WITH THE FOLLOWING REQUIREMENTS:
- 14.1. NATURAL LOAM WITH THE ADDITION OF COMPOST OR HUMUS 14.2. ORGANIC MATTER CONTENT SHALL BE BETWEEN 5% - 12% 14.3. THE pH SHALL BE IN THE RANGE OF 6.0 TO 7.0 INCLUSIVE
  - JERSEY CITY FORESTER 14.4. SOIL TEXTURAL ANALYSIS: TOP SOIL SHALL CONSIST OF THE FOLLOWING PERCENTAGES OF SAND, SILT, AND CLAY. ANY SOIL THAT DOES NOT MEET THE REQUIREMENTS BELOW WILL

UNLESS OTHERWISE APPROVED OR SPECIFIED BY THE


- BE REJECTED AND REMOVED FROM THE SITE. ROCKS, STONE AND GRAVEL >2.0 mm <5% SAND (0.05-2.0 mm) 40 - 60% SILT (0.002 - 0.05mm) 20 - 50%
- CLAY (<0.002 mm) 20% MAXIMUM 14.5. WHEN TOPSOIL OTHERWISE COMPLIES WITH THE REQUIREMENTS OF THE SPECIFICATION BUT SHOWS A DEFICIENCY IN ORGANIC MATTER, COMPOST MAY BE INCORPORATED WHEN AND AS PERMITTED BY THE
- FORESTER. 15. ROOT BALL SIZE RELATIVE TO TREE HEIGHT SHALL BE WITHIN THE RANGES SET BY THE AMERICAN NURSERY STANDARDS

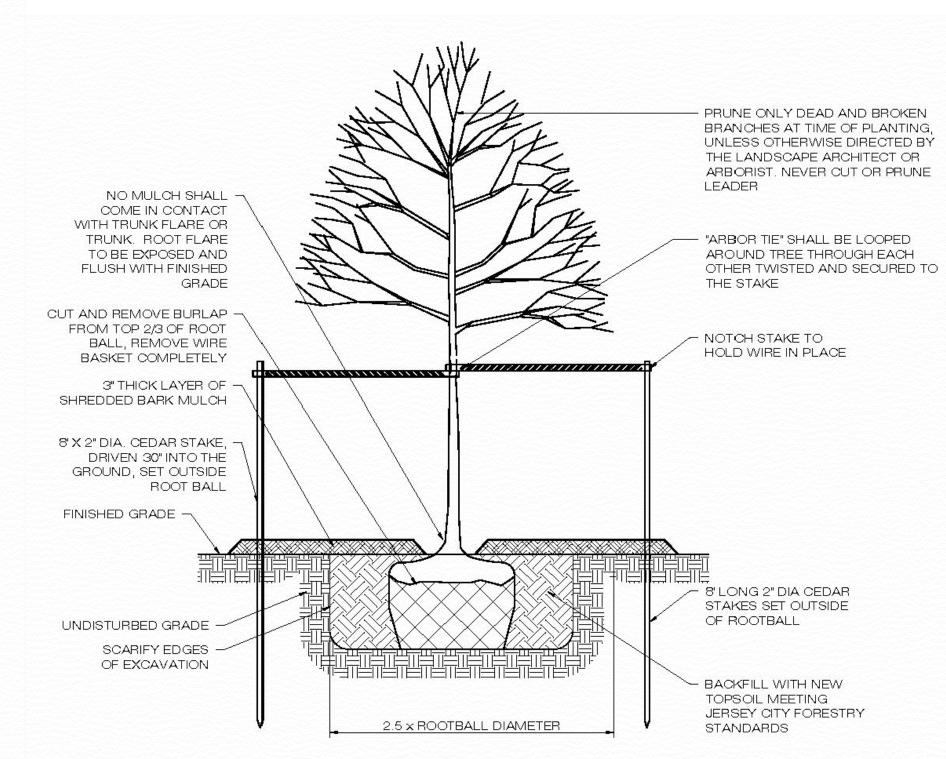


TYPICAL TREE PLANTING & STAKE DETAIL


#### 8' LONG 2" DIA CEDAR STAKES SET OUTSIDE OF ROOT BALL "ARBOR TIE" SHALL BE LOOPED AROUND TREE THROUGH EACH OTHER TWISTED AND SECURED TO THE STAKE 18" HT., 3-SIDED TREE GUARD, SEE JERSEY CITY FORESTRY STANDARDS APPENDIX E ROOT FLARE TO BE EXPOSED AND FLUSH WITH FINISHED GRADE GROUND COVER PLANTING WITH 3" SHREDDED BARK MULCH LAYER ADJACENT SIDEWALK CUT AND REMOVE BURLAP FROM TOP 2/3 OF ROOT BALL. REMOVE WIRE BASKET COMPLETELY BACKFILL WITH NEW TOPSOIL MEETING JERSEY CITY FORESTRY STANDARDS PLACE BALL ON 95% COMPACTED TOPSOIL

### SECTION A

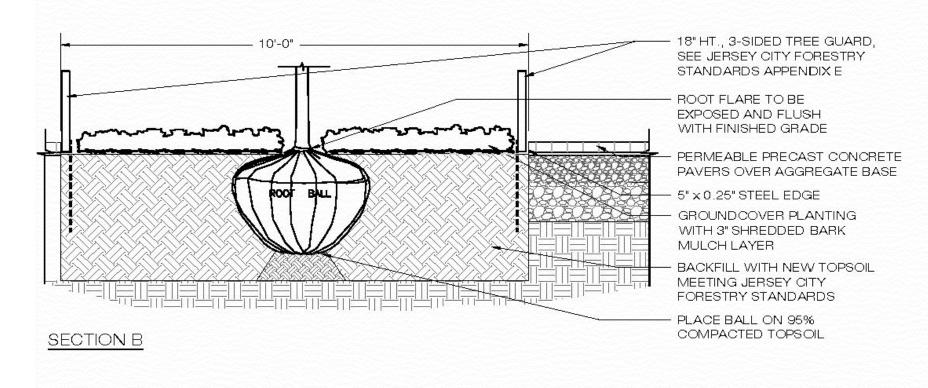

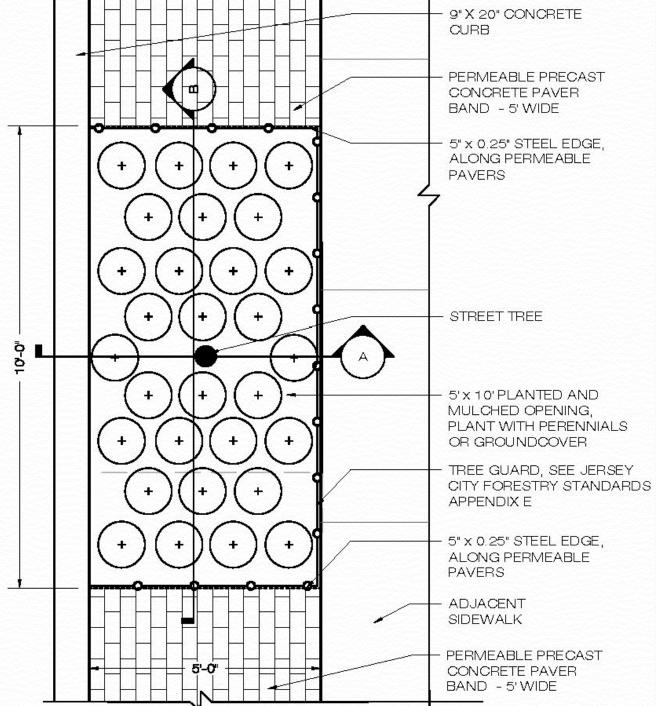

PLAN VIEW

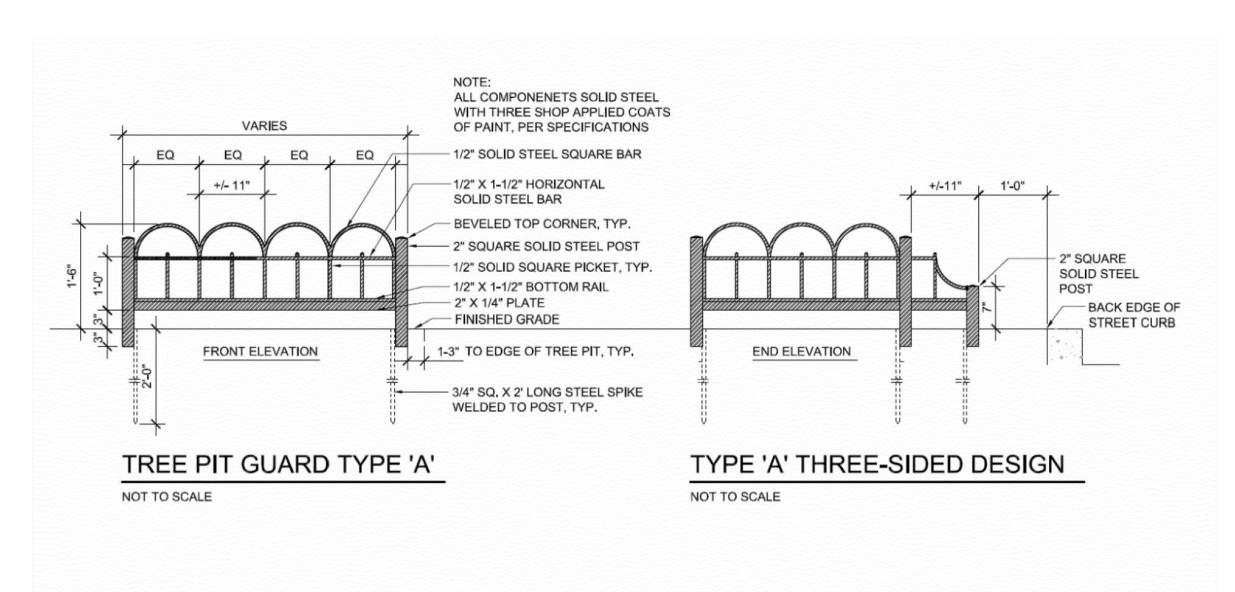


TYPICAL TYPE A TREE GUARD DETAILS

## HAMPTON HILI ARCHITECTURE

Jersey City, NJ 07304 201.401.0954. TEL mnaval2@comcast.net bob.a@hamptonhillnj.com

346 Virginia Avenue

m.kil@hamptonhillnj.com SEAL:

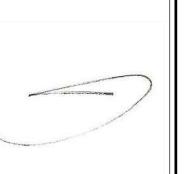

Registered Architect: NJ LIC 21 AI 019B85300

THIS DOCUMENT IS THE EXCLUSIVE PROPERTY OF HAMPTON HILL ARCHITECTURE. THE DOCUMENT AND THE INFORMATION IT CONTAINS MAY NOT BE REPRODUCED OR USED FOR OTHER THAN THE SPECIFIC PROJECT FOR WHICH IT WAS PREPARED WITHOUT THE EXPLICIT CONSENT OF HAMPTON HILL ARCHITECTURE.

**PROPOSED NEW FOUR DWELLING** 

145 BERGEN AVENUE JERSEY CITY, **NEW JERSEY** 

BLOCK: 18402 LOT:36

**REVISIONS:** 

DRAWN BY: CHKD BY: ISSUE DATE: 07.13.2020


19059


PROJECT NO: SHEET TITLE:


PROPOSED STREET TREE SITE DETAILS & NOTES


SHEET No.

TYPICAL STREET TREE PLANTING DETAIL- 5'X 10' OPEN TREE PIT

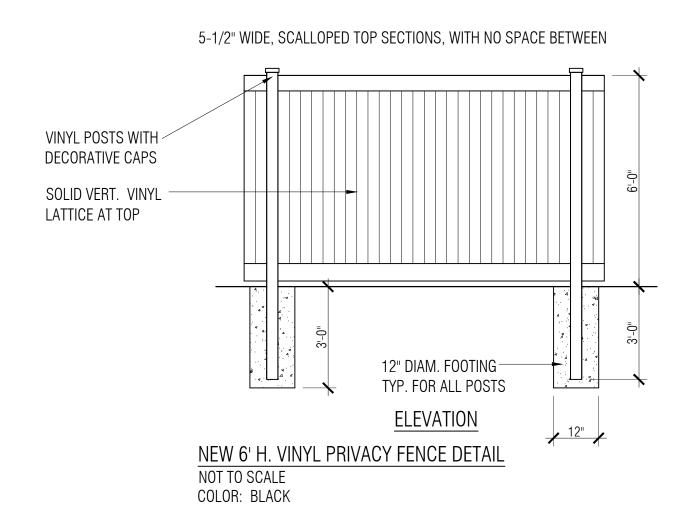

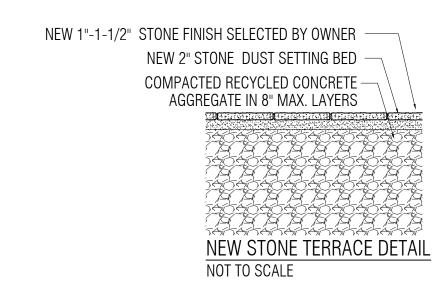

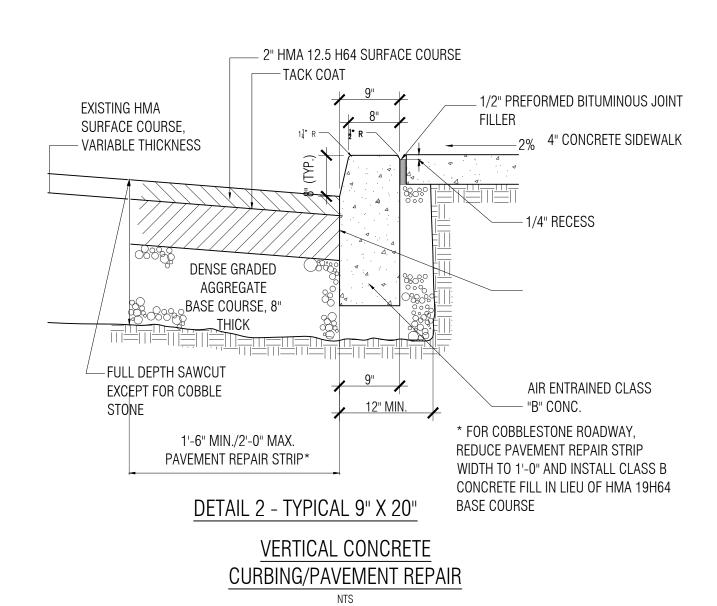


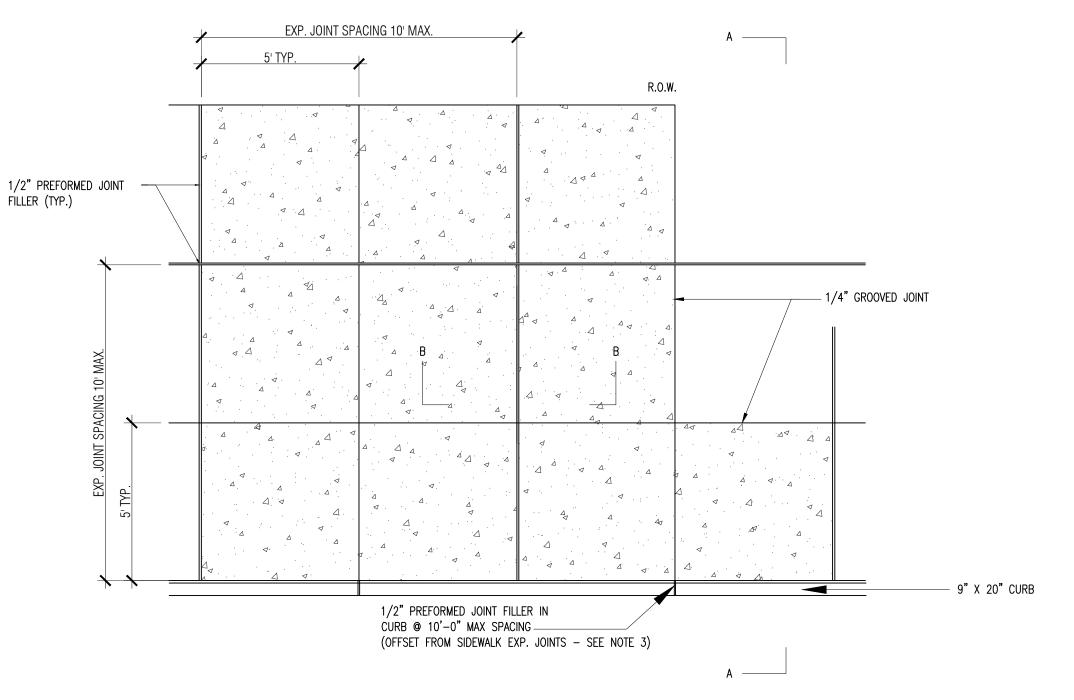

NOTES:

1. SUBBASE SHALL BE FIRM AND APPROVED BY THE ENGINEER OR HIS REPRESENTATIVE PRIOR TO PAVING.

2. ALL CONSTRUCTION METHODS AND MATERIALS SHALL CONFORM TO NJ DOT 2001 STANDARD, SPECIFICATIONS AND INSPECTIONS.

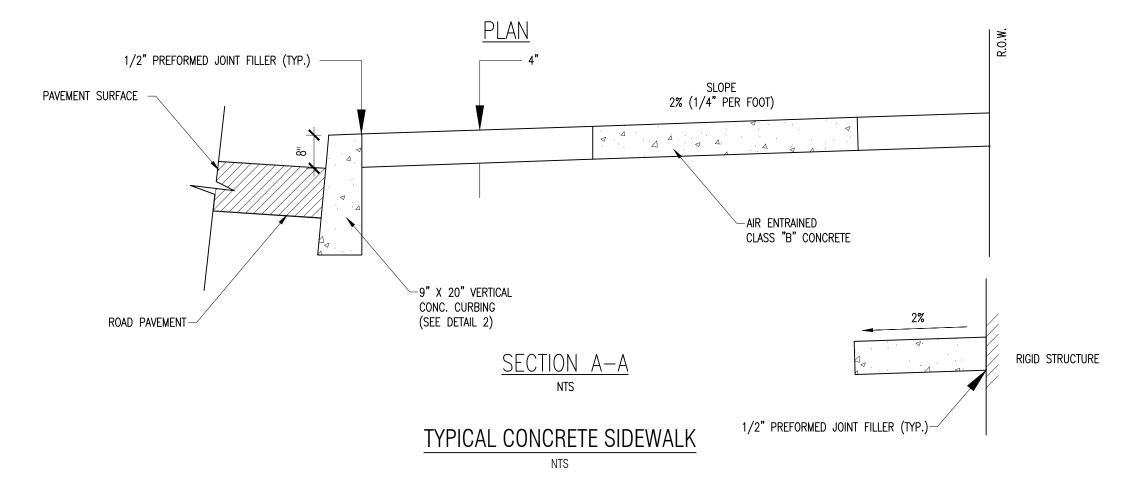

HAMPTON HILL ARCHITECTURE

346 Virginia Avenue Jersey City, NJ 07304 201.401.0954. TEL

SEAL:

mnaval2@comcast.net bob.a@hamptonhillnj.com m.kil@hamptonhillnj.com

MIN W. KIL Registered Architect: NJ LIC 21 AI 019B85300

THIS DOCUMENT IS THE EXCLUSIVE PROPERTY OF HAMPTON HILL ARCHITECTURE. THE DOCUMENT AND THE INFORMATION IT CONTAINS MAY NOT BE REPRODUCED OR USED FOR OTHER THAN THE SPECIFIC PROJECT FOR WHICH IT WAS PREPARED WITHOUT THE EXPLICIT CONSENT OF HAMPTON HILL ARCHITECTURE.

PROPOSED
4 STORY
NEW FOUR
FAMILY
DWELLING

ADDRESS: 145 BERGEN AVENUE JERSEY CITY, NEW JERSEY

BLOCK: 18402 LOT:36

REVISIONS:


DRAWN BY: MK
CHKD BY: MK
ISSUE DATE: 07.13.2020
PROJECT NO: 19059


SHEET TITLE:


PROPOSED
SITE DETAILS & NOTES


SHEET No.

C-4

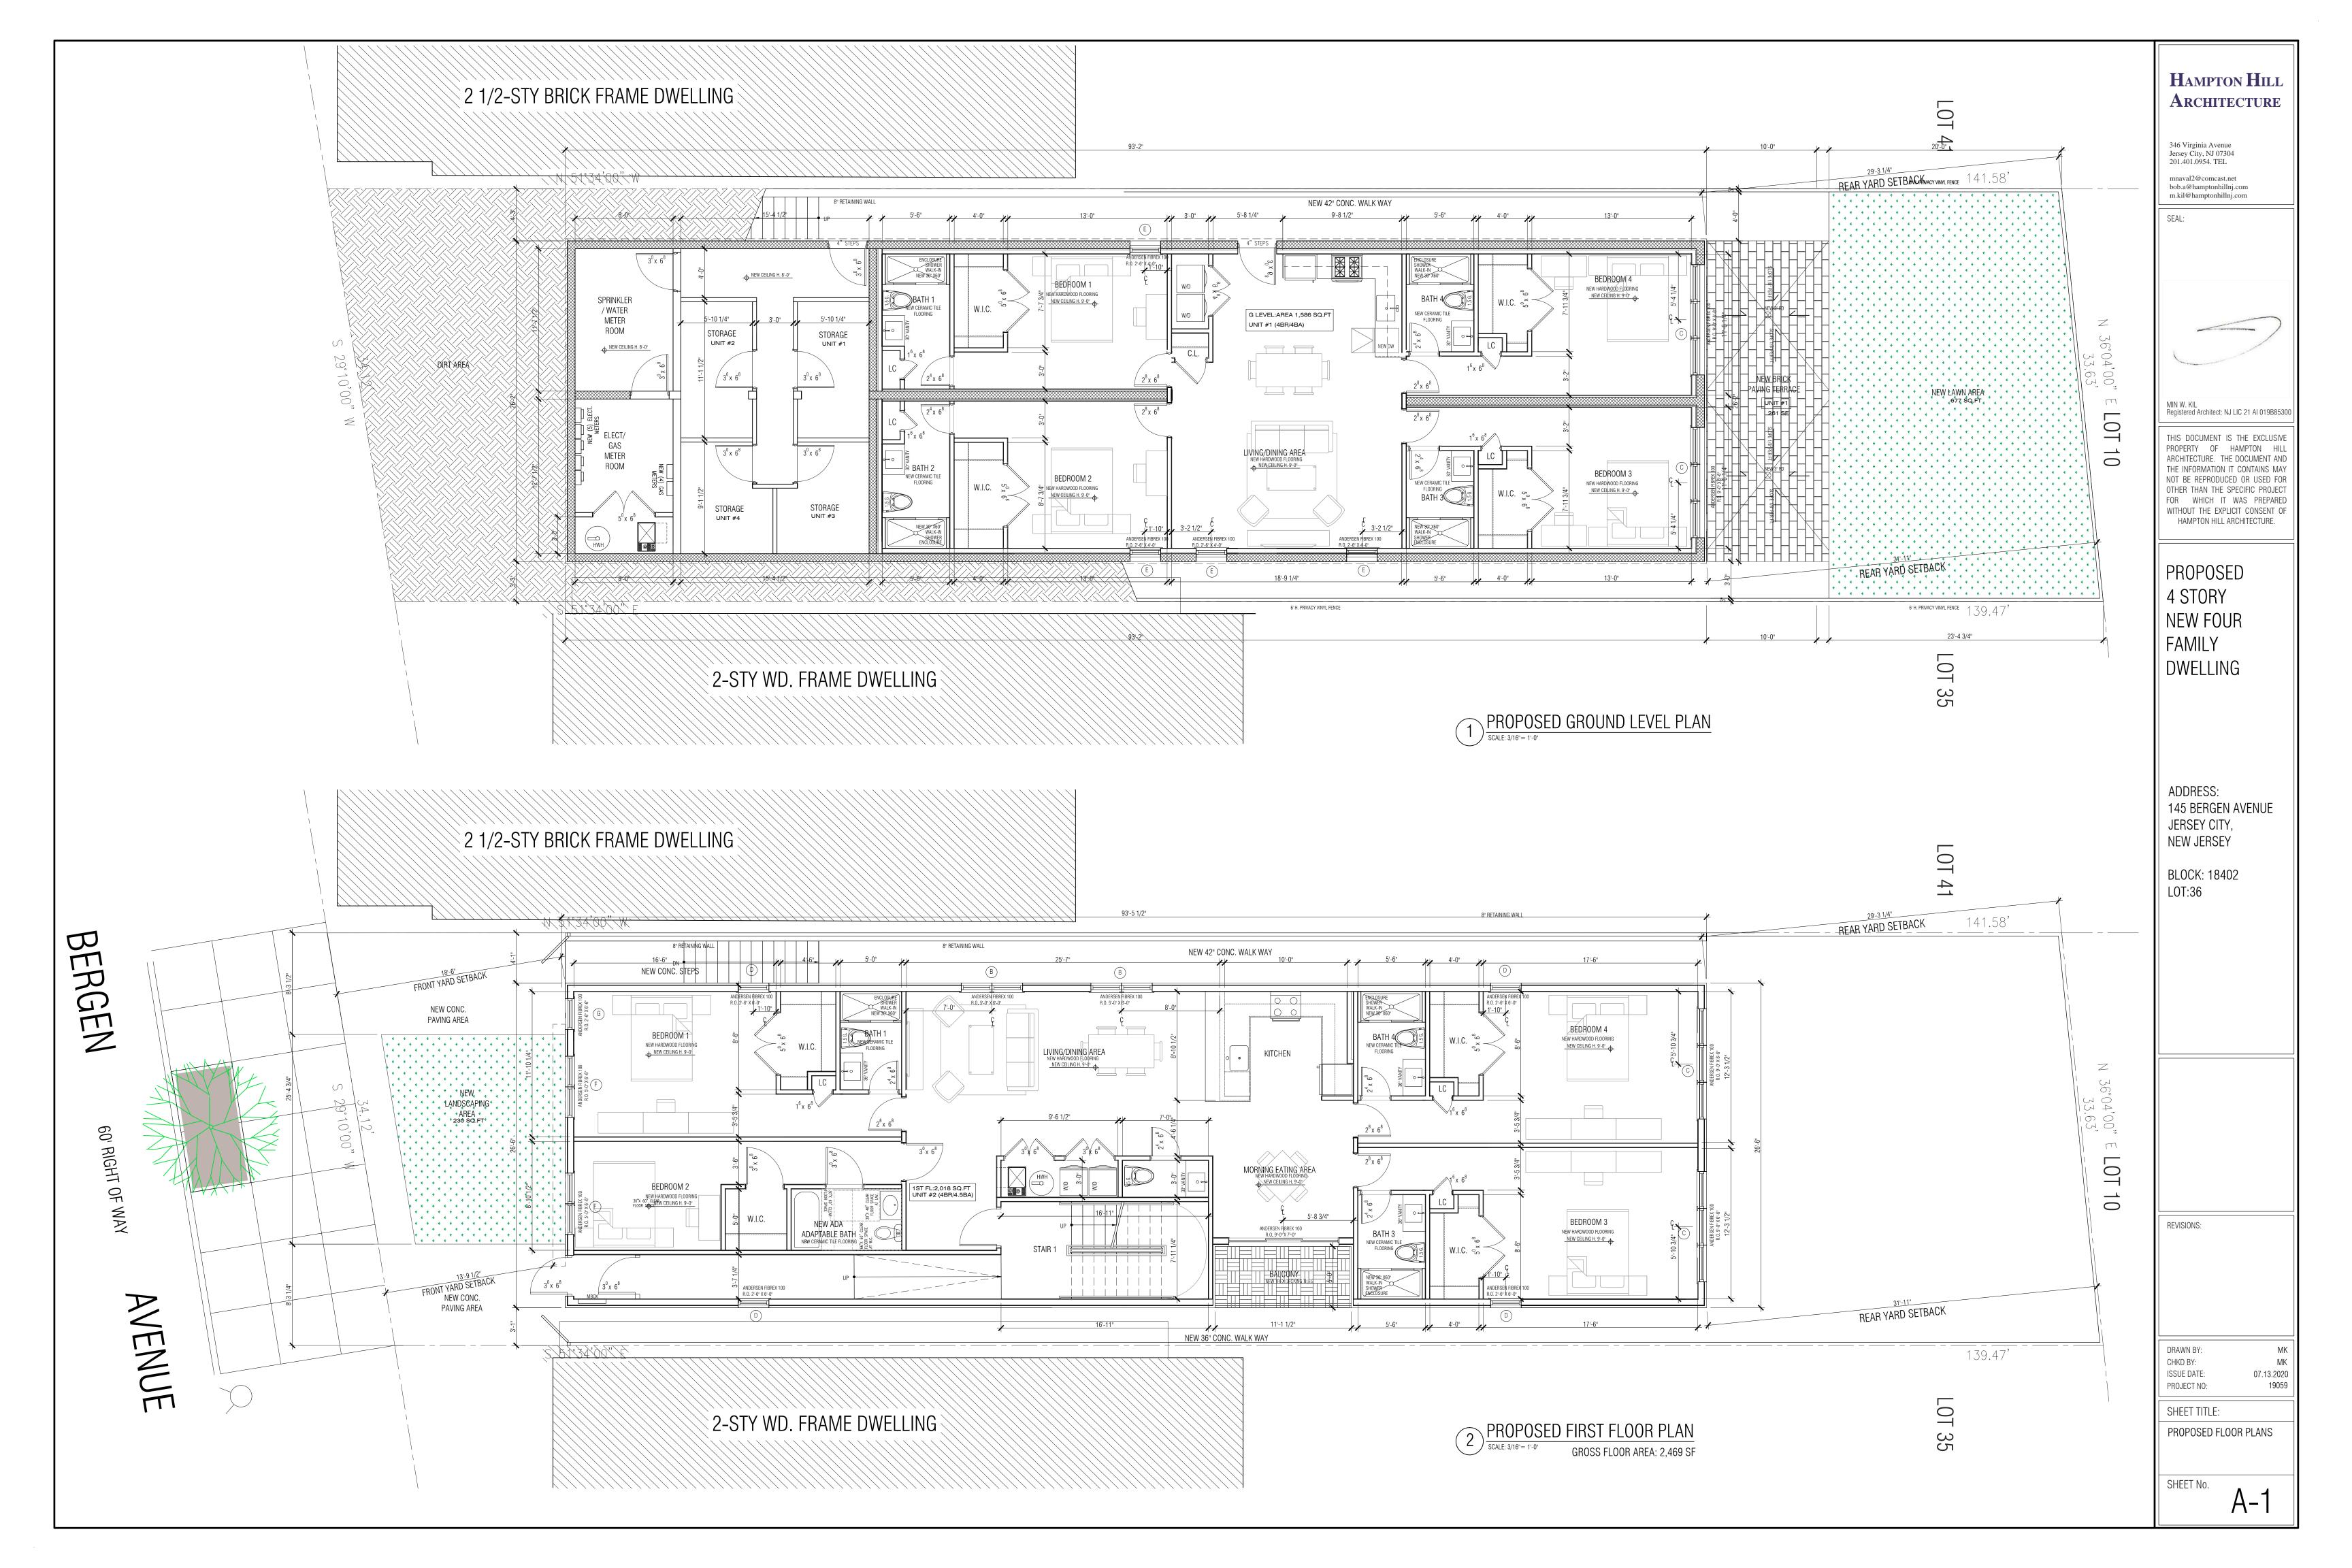

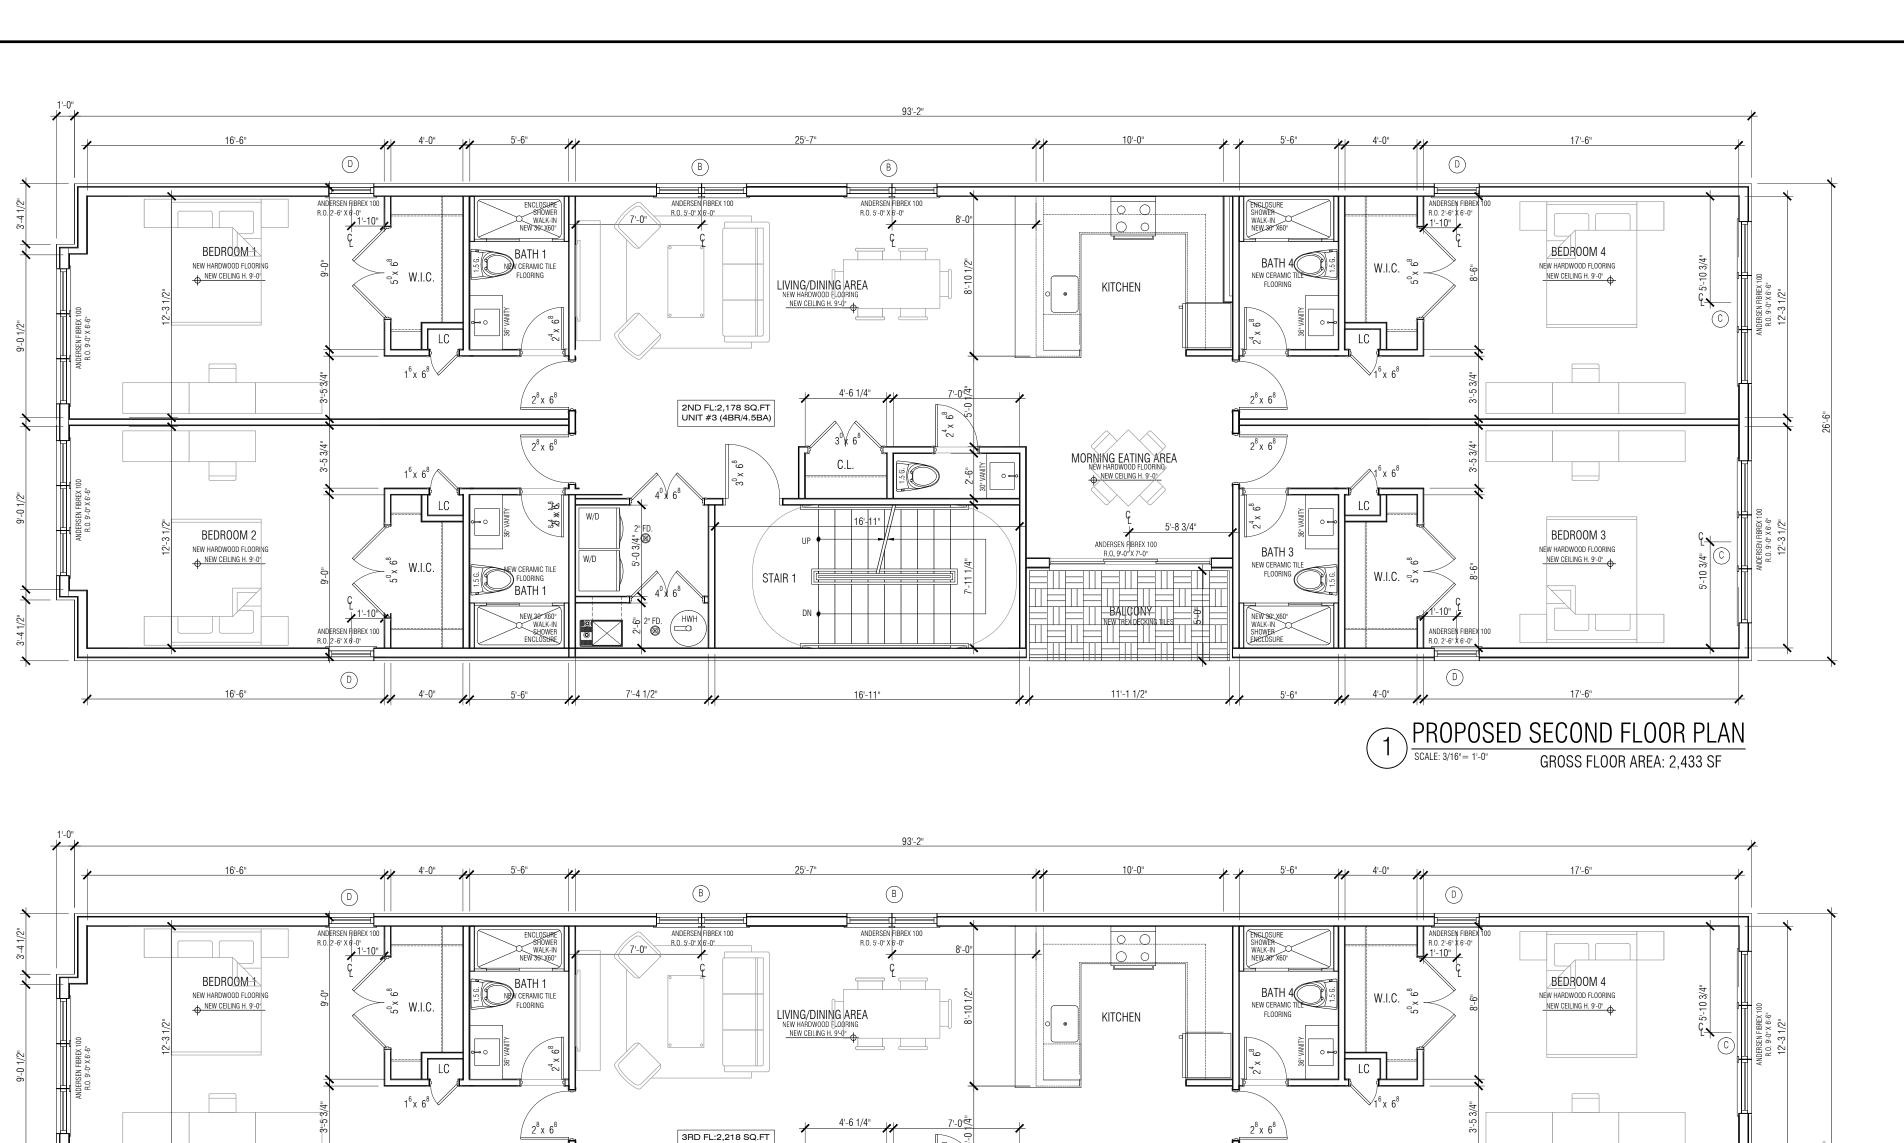

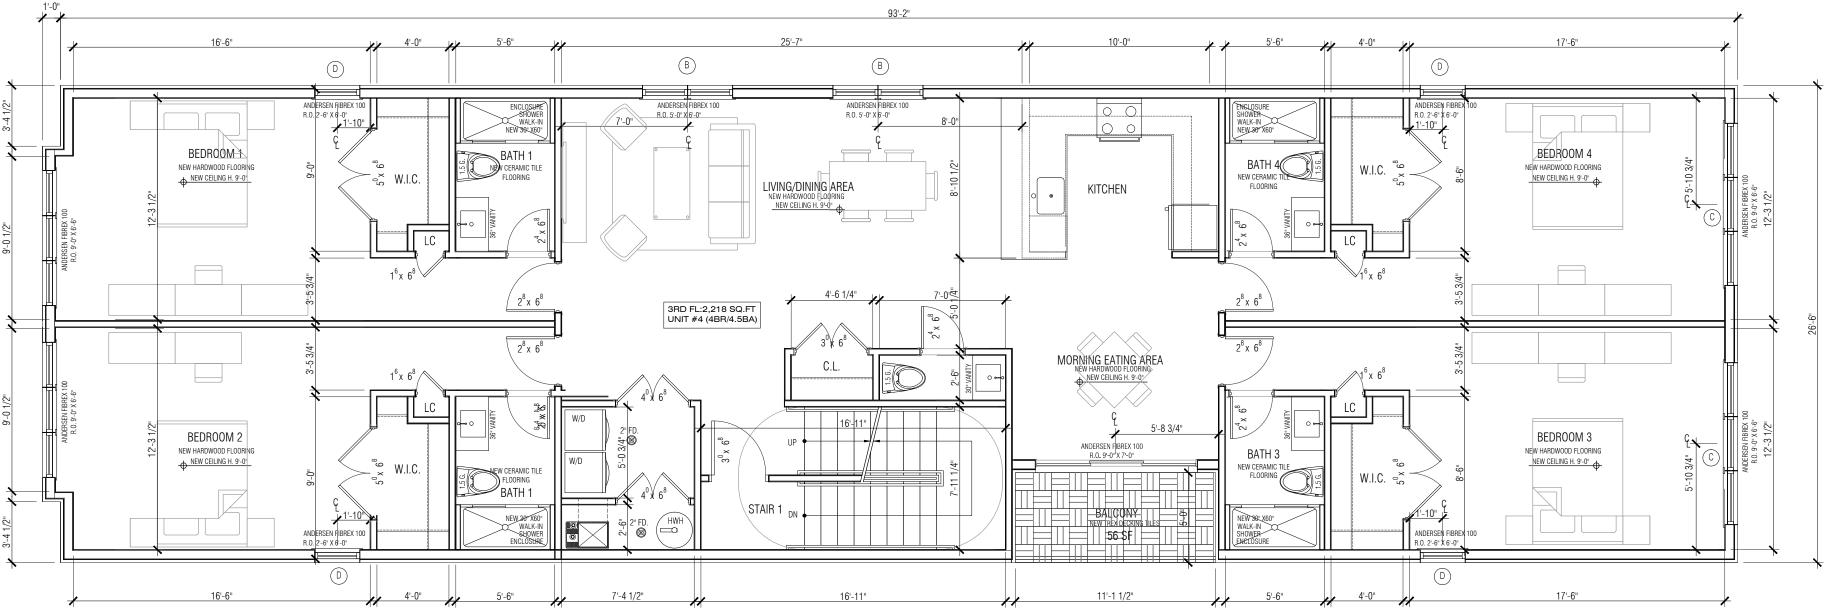

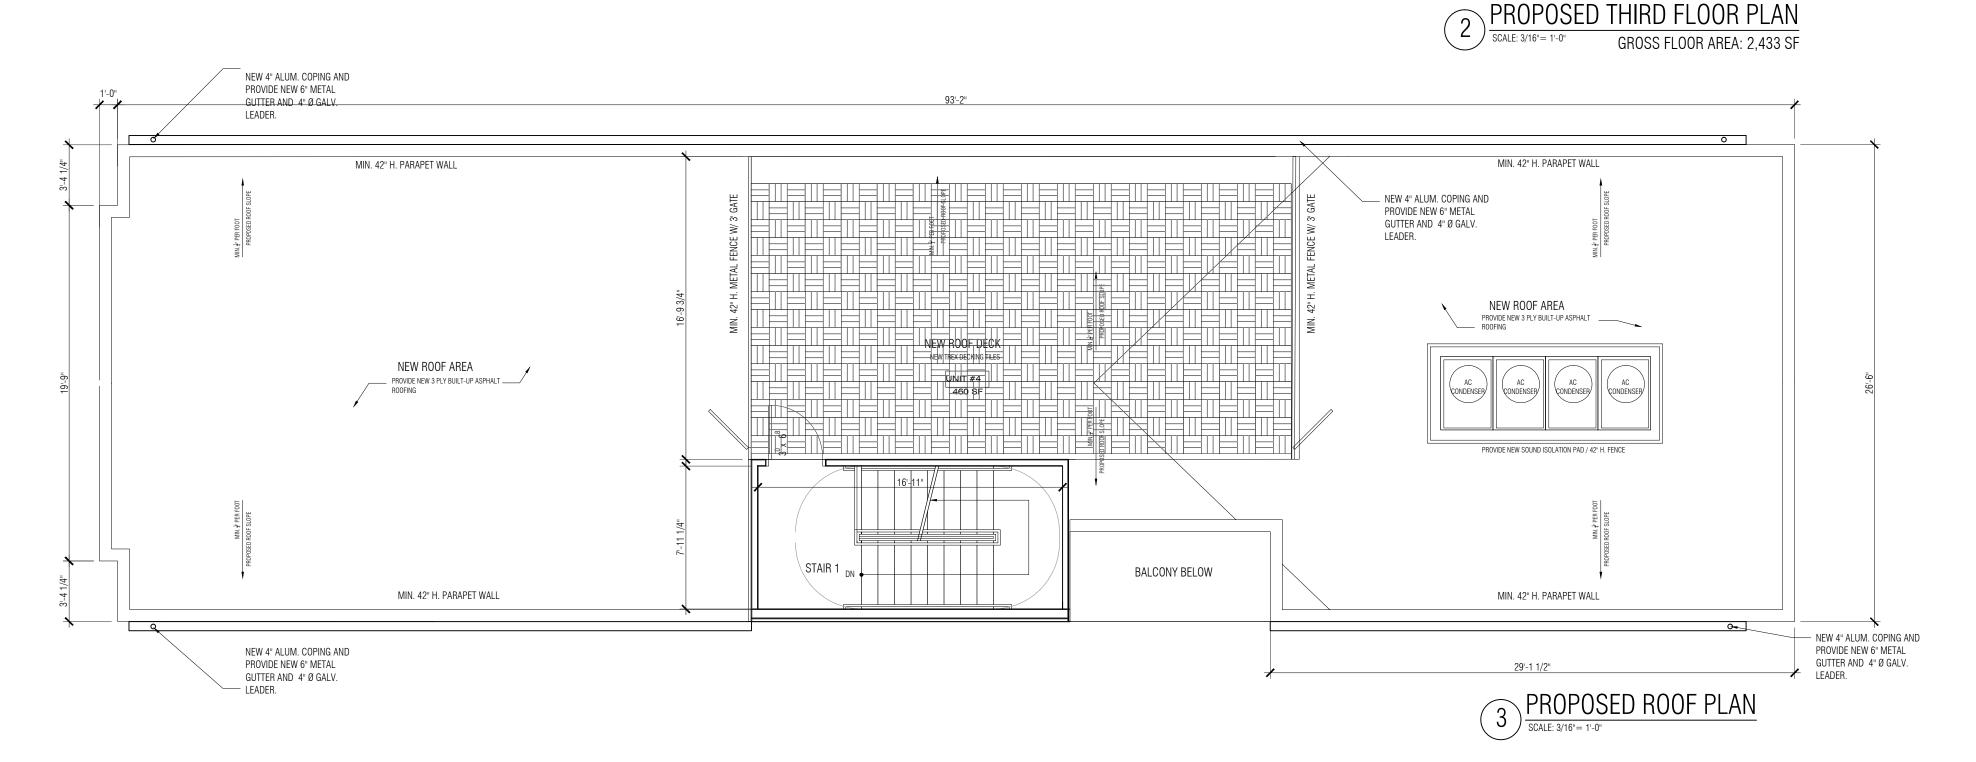

### HAMPTON HILL ARCHITECTURE

346 Virginia Avenue Jersey City, NJ 07304 201.401.0954. TEL mnaval2@comcast.net bob.a@hamptonhillnj.com m.kil@hamptonhillnj.com

SEAL:



MIN W. KIL Registered Architect: NJ LIC 21 AI 019B85300

THIS DOCUMENT IS THE EXCLUSIVE PROPERTY OF HAMPTON HILL ARCHITECTURE. THE DOCUMENT AND THE INFORMATION IT CONTAINS MAY NOT BE REPRODUCED OR USED FOR OTHER THAN THE SPECIFIC PROJECT FOR WHICH IT WAS PREPARED WITHOUT THE EXPLICIT CONSENT OF HAMPTON HILL ARCHITECTURE.

PROPOSED 4 STORY NEW FOUR FAMILY DWELLING

ADDRESS: 145 BERGEN AVENUE JERSEY CITY, NEW JERSEY

BLOCK: 18402 LOT:36

**REVISIONS:** 

DRAWN BY: CHKD BY: ISSUE DATE: 07.13.2020 19059 PROJECT NO:

SHEET TITLE: PROPOSED FLOOR PLANS

SHEET No.

#### HAMPTON HILL ARCHITECTURE 346 Virginia Avenue Jersey City, NJ 07304 201.401.0954. TEL mnaval2@comcast.net bob.a@hamptonhillnj.com m.kil@hamptonhillnj.com SEAL: MIN W. KIL Registered Architect: NJ LIC 21 AI 019B85300 THIS DOCUMENT IS THE EXCLUSIVE PROPERTY OF HAMPTON HILL ARCHITECTURE. THE DOCUMENT AND THE INFORMATION IT CONTAINS MAY NOT BE REPRODUCED OR USED FOR OTHER THAN THE SPECIFIC PROJECT FOR WHICH IT WAS PREPARED WITHOUT THE EXPLICIT CONSENT OF HAMPTON HILL ARCHITECTURE. PROPOSED 4 STORY NEW FOUR FAMILY DWELLING - 4" EXPOSURE ALUMINUM COPING (BLACK) - 4" EXPOSURE ALUMINUM COPING: BLACK STAIR BULKHEAD AREA: CERTAINTEED DOUBLE 5" TOP OF STAIR ROOF BULKHEAD TOP OF STAIR ROOF BULKHEAD NEW STAIR BULKHEAD (NOT VISIBLE FROM THE SOLID VERTICAL VINYL LAP SIDING, TYP. / COLOR: STREET)-CERTAINTEED DOUBLE 5" SOLID VINYL LAP SIDING, TYP. / COLOR: GRAY ADDRESS: 145 BERGEN AVENUE 4'-1" \_\_4" EXPOSURE ALUMINUM COPING: CHARCOAL GRAY JERSEY CITY, — 4" EXPOSURE ALUMINUM COPING: CHARCOAL GRAY TOP OF PARAPET NEW JERSEY TOP OF PARAPET \_\_ 4" EXPOSURE ALUMINUM COPING: LIGHT GRAY 12" OVERHANG: NEW HARDI REVEAL NEW CERTAINTEED DOUBLE 5" SOLID PANEL SYSTEM: COLOR: LIGHT WARM BLOCK: 18402 VINYL LAP SIDING, TYP. / COLOR: DARK TOP OF ROOF DECK TOP OF ROOF DECK LOT:36 – 8" H. BRICK SOLDIER COURSE NEW ANDERSEN FIBREX COMPOSITE MATERIAL FRAMED NEW 4" BRICK VENEERS CASEMENT + FIXED UNIT 100 SERIES OR EQ, TYP. W/ CONCAVE TOOLED MORTAR JOINTS (METAL FINISHES: BLACK) (BROWN-RED) — NEW ANDERSEN FIBREX COMPOSITE MATERIAL FRAMED R.O.: 9'-0" WIDE x 6'-6" HEIGHT CASEMENT + FIXED UNIT 100 SERIES OR EQ, TYP. (METAL FINISHES: BLACK) R.O.: 7'-6" WIDE x 6'-6" HEIGHT THIRD FL. THIRD FL. 8" H. BRICK SOLDIER COURSE NEW ANDERSEN FIBREX COMPOSITE MATERIAL FRAMED CASEMENT + FIXED UNIT 100 SERIES OR EQ, TYP. (METAL FINISHES: BLACK) R.O.: 9'-0" WIDE x 6'-6" HEIGHT —— NEW ANDERSEN FIBREX COMPOSITE MATERIAL FRAMED CASEMENT + FIXED UNIT 100 SERIES OR EQ, TYP. (METAL FINISHES: BLACK) R.O.: 7'-6" WIDE x 6'-6" HEIGHT SECOND FL. 12" OVERHANG: NEW HARDI REVEAL PANEL SECOND FL. - NEW CERTAINTEED DOUBLE 5" SOLID SYSTEM: COLOR: LIGHT WARM GRAY VINYL LAP SIDING, TYP. / COLOR: GRAY —— NEW CEILING MOUNTED LIGHTING - SEE THE NEW ANDERSEN FIBREX COMPOSITE MATERIAL FRAMED CASEMENT + FIXED UNIT 100 SERIES OR EQ, TYP. SITE LIGHTING PLAN FOR DETAILS TYP. (METAL FINISHES: BLACK) NEW CEILING MOUNTED -R.O.: 9'-0" WIDE x 6'-6" HEIGHT LIGHTING - SEE THE - NEW ANDERSEN FIBREX COMPOSITE MATERIAL FRAMED SITE LIGHTING PLAN − NEW 42" H. PRE-FINISHED ALUMINUM RAILING AND POSTS ON NEW 12" H. BALC NY REVISIONS: CASEMENT 100 SERIES OR EQ, TYP. FOR DETAILS TYP. W/ HARDI PANEL FINISHES (DARK GRAY) (METAL FINISHES: BLACK) NEW 6' H. VINYL FENCE -R.O.: 2'-6" WIDE x 6'-6" HEIGHT & 4' WIDE GATE- BLACK NEW 3' W. X 8' H. STEEL ENTRY DOOR & TRIMS W/ GLASS PANEL. FIRST FL. FIRST FL. — NEW CEMENT PARGING (GRAY) (COLOR: DARK GRAY) NEW ANDERSEN FIBREX COMPOSITE MATERIAL FRAMED CASEMENT + FIXED UNIT 100 SERIES OR EQ, TYP. (METAL FINISHES: BLACK) AVG. GRADE PLANE AVG. GRADE PLANE R.O.: 9'-0" WIDE x 6'-6" HEIGHT 4" CASTSTONE SILL — DRAWN BY: CHKD BY: ISSUE DATE: 07.13.2020 GROUND LEVEL GROUND LEVEL PROJECT NO: 19059 G. LEVEL RESINDETIAL G. LEVEL RESINDETIAL SHEET TITLE: PROPOSED ELEVATIONS PROPOSED REAR ELEVATION SCALE: 3/16"= 1'-0" PROPOSED REAR ELEVATION SHEET No.

#### — 4" EXPOSURE ALUMINUM COPING: BLACK 47'-5 1/4" NEW STAIR BULKHEAD (NOT VISIBLE FROM THE STREET)-CERTAINTEED DOUBLE 5" SOLID VINYL LAP TOP OF STAIR ROOF BULKHEAD SIDING, TYP. / COLOR: GRAY — 42" H. SOLID PARAPET WALL W/ 12" H. METAL WRAPPED 4" EXPOSURE ALUMINUM COPING: — DRAIN OPENING LIGHT GRAY - 4" Alum. Coping and provide 6" metal gutter and 4" $\emptyset$ - 4" EXPOSURE ALUMINUM COPING: CHARCOAL GRAY 12" OVERHANG: NEW HARDI REVEAL ----GALV. LEADER. TOP OF PARAPET PANEL SYSTEM: COLOR: LIGHT WARM TOP OF ROOF DECK CERTAINTEED DOUBLE 5" SOLID VINYL LAP SIDING, TYP. / COLOR: DARK GRAY ANDERSEN FIBREX COMPOSITE MATERIAL FRAMED CASEMENT 100 SERIES OR EQ, TYP. ANDERSEN FIBREX COMPOSITE — MATERIAL FRAMED CASEMENT 100 (METAL FINISHES: BLACK) SERIES OR EQ, TYP. (METAL FINISHES: BLACK) R.O.: 2'-6" WIDE x 6'-0" HEIGHT R.O.: 2'-6" WIDE x 6'-0" HEIGHT - ANDERSEN FIBREX FRAME 9' W. X 8' H. DOUBLE SLIDING DOORS (BLACK) NEW 42" H. PRE-FINISHED ALUMINUM RAILING AND POSTS ON NEW 12" H. BALCONY THIRD FL. W/ HARDI PANEL FINISHES (DARK GRAY) - ANDERSEN FIBREX COMPOSITE MATERIAL FRAMED ANDERSEN FIBREX COMPOSITE -CASEMENT 100 SERIES OR EQ, TYP. MATERIAL FRAMED CASEMENT 100 (METAL FINISHES: BLACK) SERIES OR EQ, TYP. R.O.: 2'-6" WIDE x 6'-0" HEIGHT (METAL FINISHES: BLACK) - ANDERSEN FIBREX FRAME 9' W. X 8' H. R.O.: 2'-6" WIDE x 6'-0" HEIGHT DOUBLE SLIDING DOORS (BLACK) NEW 42" H. PRE-FINISHED ALUMINUM RAILING AND POSTS ON NEW 12" H. BALCONY SECOND FL. W/ HARDI PANEL FINISHES (DARK GRAY) ANDERSEN FIBREX COMPOSITE — MATERIAL FRAMED CASEMENT 100 SERIES OR EQ, TYP. (METAL FINISHES: BLACK) R.O.: 2'-6" WIDE x 6'-0" HEIGHT — NEW CEMENT PARGING (GRAY) —ANDERSEN FIBREX COMPOSITE MATERIAL FRAMED AVG. GRADE PLANE R.O.: 2'-6" WIDE x 4'-0" HEIGHT GROUND LEVEL G. LEVEL RESINDETIAL

# PROPOSED RIGHT SIDE ELEVATION

## HAMPTON HILL ARCHITECTURE

346 Virginia Avenue Jersey City, NJ 07304 201.401.0954. TEL

mnaval2@comcast.net bob.a@hamptonhillnj.com m.kil@hamptonhillnj.com

SEAL:



MIN W. KIL Registered Architect: NJ LIC 21 AI 019B85300

THIS DOCUMENT IS THE EXCLUSIVE PROPERTY OF HAMPTON HILL ARCHITECTURE. THE DOCUMENT AND THE INFORMATION IT CONTAINS MAY NOT BE REPRODUCED OR USED FOR OTHER THAN THE SPECIFIC PROJECT FOR WHICH IT WAS PREPARED WITHOUT THE EXPLICIT CONSENT OF HAMPTON HILL ARCHITECTURE.

PROPOSED 4 STORY NEW FOUR FAMILY DWELLING

ADDRESS: 145 BERGEN AVENUE JERSEY CITY, NEW JERSEY

BLOCK: 18402 LOT:36

**REVISIONS:** 

DRAWN BY: CHKD BY: ISSUE DATE: 07.13.2020 PROJECT NO:

SHEET TITLE: PROPOSED ELEVATION

SHEET No.

19059

#### 4" EXPOSURE ALUMINUM COPING: BLACK —— NEW STAIR BULKHEAD (NOT VISIBLE FROM THE -STREET)-CERTAINTEED DOUBLE 5" SOLID VINYL LAP TOP OF STAIR ROOF BULKHEAD SIDING, TYP. / COLOR: GRAY 42" H. SOLID PARAPET WALL W/ 12" H. METAL WRAPPED —— - 4" EXPOSURE ALUMINUM COPING DRAIN OPENING LIGHT GRAY 4" ALUM. COPING AND PROVIDE 6" METAL GUTTER AND 4" Ø 4" EXPOSURE ALUMINUM COPING: CHARCOAL GRAY — GALV. LEADER. - 12" OVERHANG: NEW HARDI REVEAL PANEL SYSTEM: COLOR: LIGHT WARM TOP OF PARAPET TOP OF ROOF DECK CERTAINTEED DOUBLE 5" SOLID VINYL LAP SIDING, TYP. / \_ COLOR: DARK GRAY ANDERSEN FIBREX COMPOSITE MATERIAL FRAMED -- ANDERSEN FIBREX COMPOSITE CASEMENT 100 SERIES OR EQ, TYP. MATERIAL FRAMED CASEMENT 100 (METAL FINISHES: BLACK) SERIES OR EQ, TYP R.O.: 5'-0" WIDE x 6'-0" HEIGHT (METAL FINISHES: BLACK) R.O.: 2'-6" WIDE x 6'-0" HEIGHT ANDERSEN FIBREX COMPOSITE MATERIAL FRAMED -CASEMENT 100 SERIES OR EQ, TYP. (METAL FINISHES: BLACK) R.O.: 2'-6" WIDE x 6'-0" HEIGHT THIRD FL. - ANDERSEN FIBREX COMPOSITE ANDERSEN FIBREX COMPOSITE MATERIAL FRAMED -MATERIAL FRAMED CASEMENT 100 CASEMENT 100 SERIES OR EQ, TYP. SERIES OR EQ, TYP (METAL FINISHES: BLACK) (METAL FINISHES: BLACK) R.O.: 2'-6" WIDE x 6'-0" HEIGHT R.O.: 5'-0" WIDE x 6'-0" HEIGHT ANDERSEN FIBREX COMPOSITE MATERIAL FRAMED CASEMENT 100 SERIES OR EQ, TYP. (METAL FINISHES: BLACK) SECOND FL. R.O.: 2'-6" WIDE x 6'-0" HEIGHT PTD- 36" H. METAL RAILING SYSTEM (HORIZONTAL TOP RAIL, BOTTOM RAIL, SQUARE BALUSTERS) & 2"X2" METAL TUBE POSTS EMBEDDED ON NEW ANDERSEN FIBREX COMPOSITE MATERIAL FRAMED -CONC. STAIRS (BLACK) CASEMENT 100 SERIES OR EQ, TYP. (METAL FINISHES: BLACK) R.O.: 5'-0" WIDE x 6'-0" HEIGHT ANDERSEN FIBREX COMPOSITE MATERIAL FRAMED -CASEMENT 100 SERIES OR EQ, TYP. (METAL FINISHES: BLACK) FIRST FL. R.O.: 2'-6" WIDE x 6'-0" HEIGHT NEW CEMENT PARGING (GRAY) -ANDERSEN FIBREX COMPOSITE MATERIAL FRAMED — \_\_\_\_ CASEMENT 100 SERIES OR EQ. TYP. \_\_\_\_ \_ \_ \_ \_ \_ \_ \_ \_ \_ \_ \_ \_ \_ \_ \_ \_ (METAL FINISHES: BLACK) R.O.: 5'-0" WIDE x 4'-0" HEIGHT NEW 3' W. X 8' H. STEEL ENTRY DOOR & TRIMS W/ GLASS PANEL. (COLOR: DARK GRAY) GROUND LEVEL NEW 3' W. X 7' H. INSUL. STEEL DOOR (COLOR: DARK GRAY) PROPOSED LEFT SIDE ELEVATION SCALE: 3/16"= 1'-0"

HAMPTON HILL ARCHITECTURE

346 Virginia Avenue Jersey City, NJ 07304 201.401.0954. TEL

mnaval2@comcast.net bob.a@hamptonhillnj.com m.kil@hamptonhillnj.com

SEAL:

MIN W. KIL Registered Architect: NJ LIC 21 AI 019B85300

THIS DOCUMENT IS THE EXCLUSIVE PROPERTY OF HAMPTON HILL ARCHITECTURE. THE DOCUMENT AND THE INFORMATION IT CONTAINS MAY NOT BE REPRODUCED OR USED FOR OTHER THAN THE SPECIFIC PROJECT FOR WHICH IT WAS PREPARED WITHOUT THE EXPLICIT CONSENT OF HAMPTON HILL ARCHITECTURE.

PROPOSED 4 STORY NEW FOUR FAMILY DWELLING

ADDRESS: 145 BERGEN AVENUE JERSEY CITY, NEW JERSEY

BLOCK: 18402 LOT:36


REVISIONS:

DRAWN BY: MK
CHKD BY: MK
ISSUE DATE: 07.13.2020
PROJECT NO: 19059

SHEET TITLE:
PROPOSED ELEVATION

SHEET No.

A-5

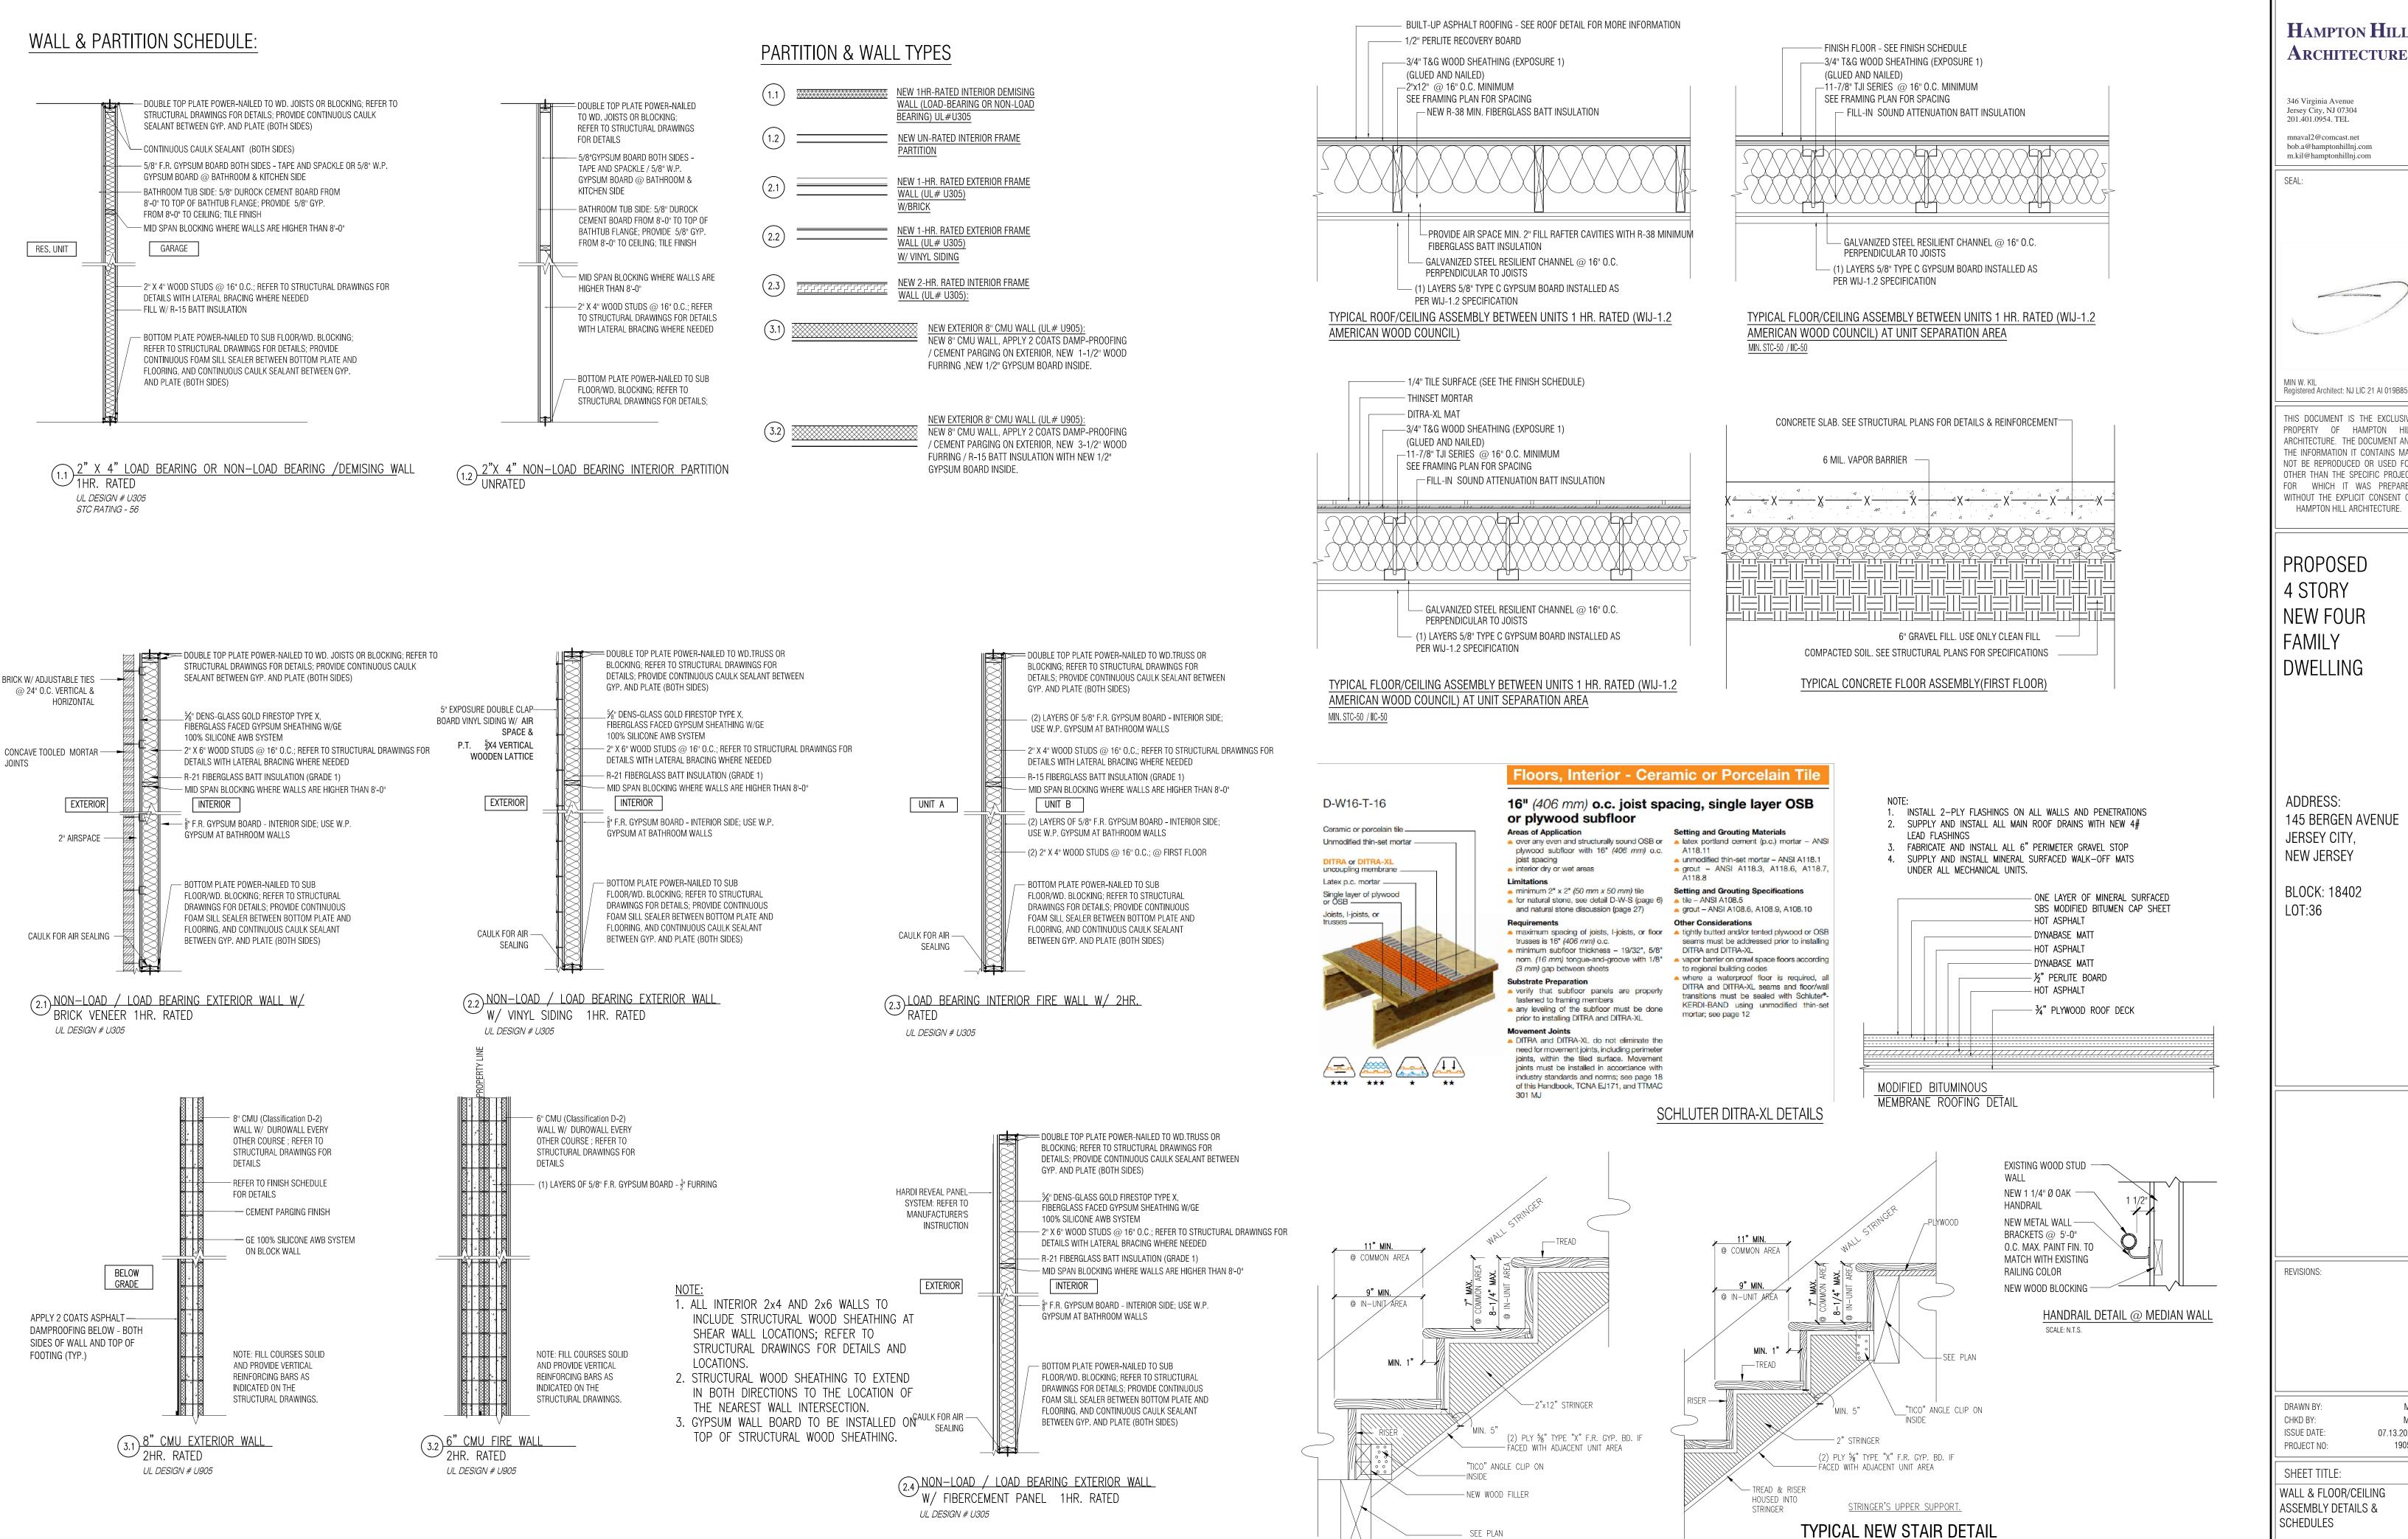

STRINGER'S LOWER SUPPORT

NOT TO SCALE

HAMPTON HILL

346 Virginia Avenue Jersey City, NJ 07304 201.401.0954. TEL mnaval2@comcast.net

bob.a@hamptonhillnj.com m.kil@hamptonhillnj.com

Registered Architect: NJ LIC 21 AI 019B85300

THIS DOCUMENT IS THE EXCLUSIVE PROPERTY OF HAMPTON HILL ARCHITECTURE. THE DOCUMENT AND THE INFORMATION IT CONTAINS MAY NOT BE REPRODUCED OR USED FOR OTHER THAN THE SPECIFIC PROJECT FOR WHICH IT WAS PREPARED WITHOUT THE EXPLICIT CONSENT OF HAMPTON HILL ARCHITECTURE.

**PROPOSED NEW FOUR DWELLING** 

145 BERGEN AVENUE JERSEY CITY,

BLOCK: 18402

07.13.2020

19059 WALL & FLOOR/CEILING

SHEET No. H-0

