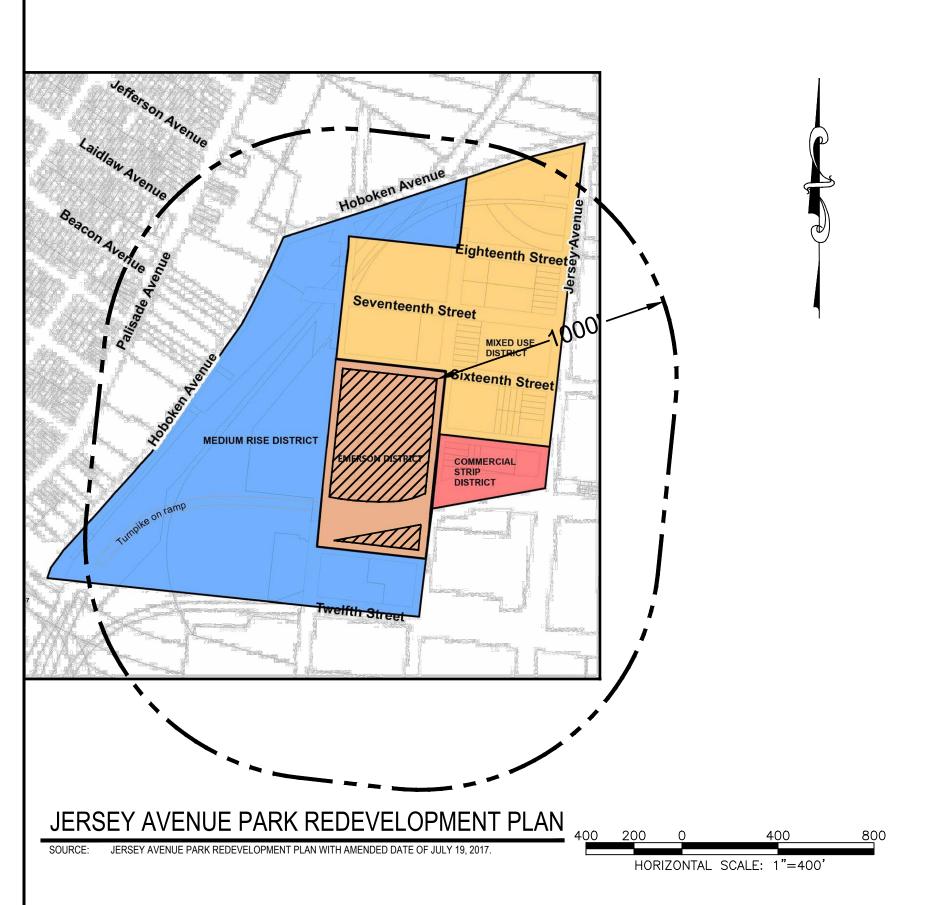
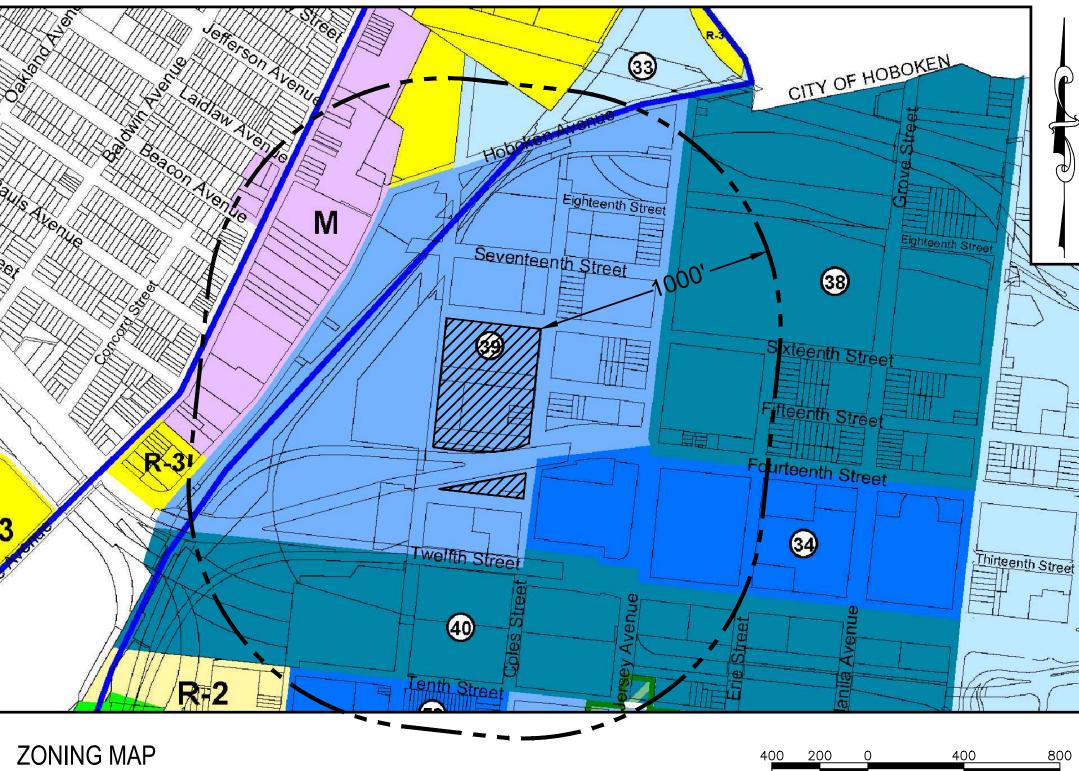


PHASE II & III SITE PLAN

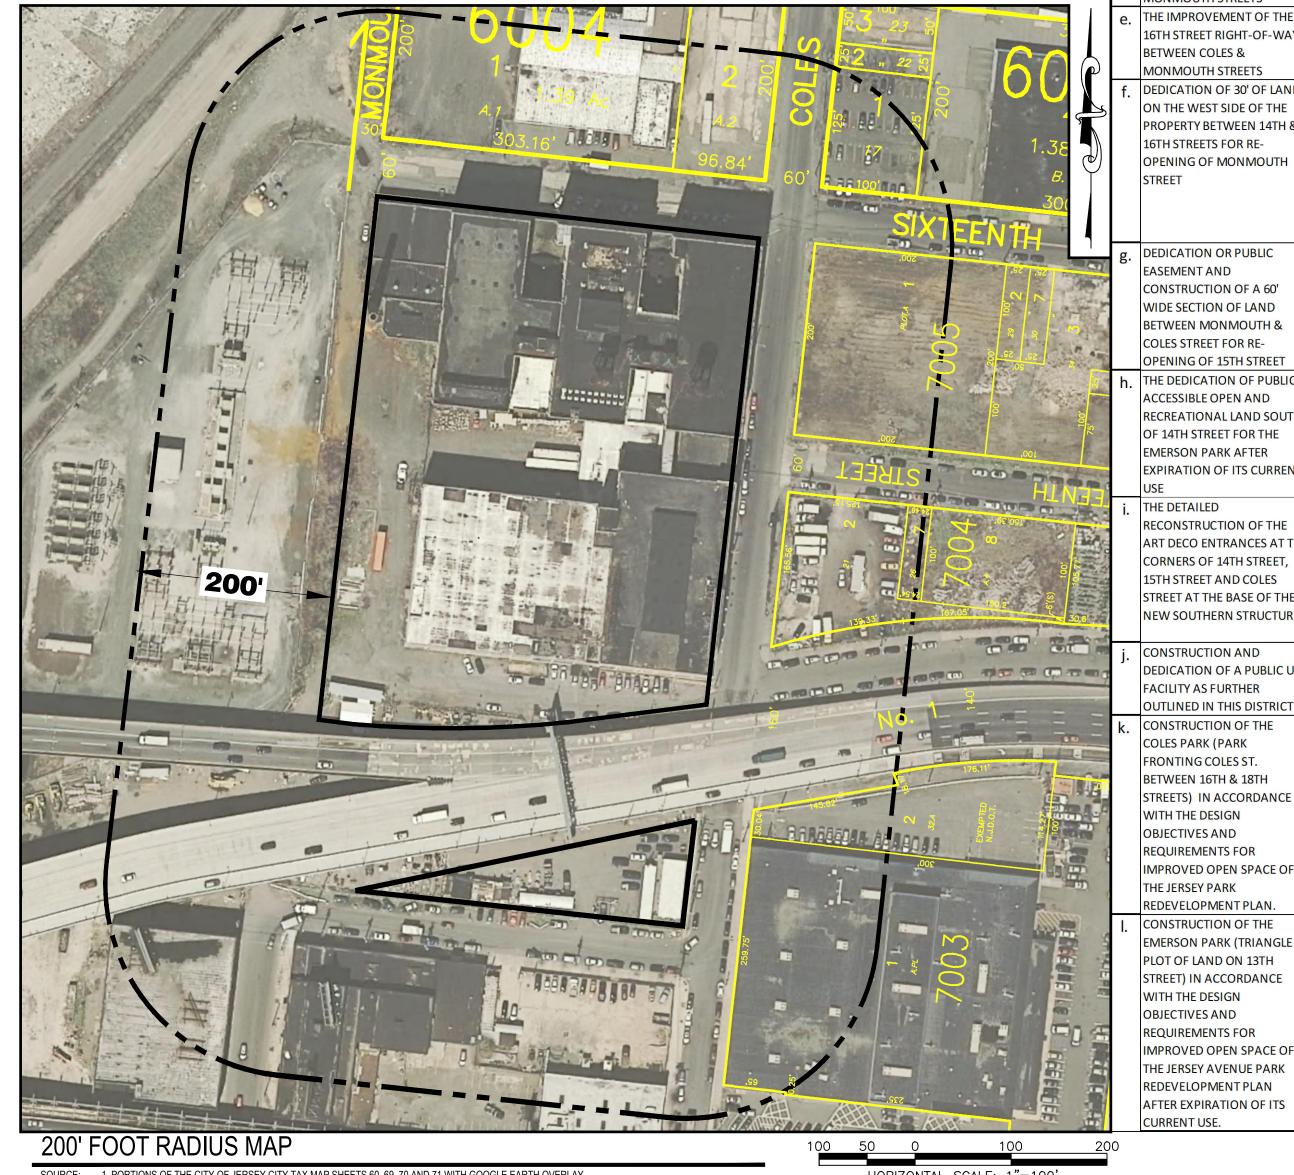
EMERSON BUILDING COMPLEX

SITE PLAN - CIVIL DRAWING SET BLOCK 6903, LOTS 2.01 & 3.04 CITY OF JERSEY CITY, COUNTY OF HUDSON, NEW JERSEY





SOURCE: JERSEY CITY ZONING MAP WITH AMENDED DATE OF AUGUST 25, 2010.



SOURCE: 1. PORTIONS OF THE CITY OF JERSEY CITY TAX MAP SHEETS 60, 69, 70 AND 71 WITH GOOGLE EARTH OVERLAY HORIZONTAL SCALE: 1"=100 PROJECT CONTACTS

WATER SUPPLY SUEZ WATER

MICHAEL HLAVATY

233 COLES STREET

(201) 239-1108

FRANK GRANT

(973) 344-4218

(201) 725-4189

(201) 725-2463

600 WILSON AVENUE

ENGINEER URBAN ARCHITECTURE, LLC

300 COLES STREET, SUITE 2

ARCHITECT URBAN ARCHITECTURE, LLC

300 COLES STREET, SUITE 2

185 HUDSON STREET, SUITE 2510

CLIENT
PHASE II: EMERSON LEASING CO. II LLC PHASE IV: EMERSON LEASING CO. IV LLC

300 COLES STREET, SUITE 2

JERSEY CITY, NJ 07310

TEL: (201) 656-0314

JERSEY CITY, NJ 07310

RONALD RUSSELL, R.A.

ATTORNEY GEORGE L GARCIA

JERSEY CITY, NJ 07311

300 COLES STREET, SUITE 2

300 COLES STREET, SUITE 2

PHASE III: EMERSON LEASING CO. III LLC

JERSEY CITY, NJ 07310

JERSEY CITY, NJ 07310

TEL: (201) 656-0314

TEL: (201) 656-0314

CONNELL FOLEY

HARBORSIDE 5

(201) 521-1000

JERSEY CITY, NJ 07310

JEFFREY REEVES, P.E.

NEWARK, NJ 07105

JERSEY CITY, NJ 07310

SEWAGE TREATMENT
PASSAIC VALLEY SEWERAGE COMMISSION

GENERAL NOTES

- 1. SUBJECT PROPERTY FOR EMERSON BUILDING COMPLEX WAS KNOWN AS LOTS 1, 2 & 3 IN BLOCK 6903,
- 2. FILED SUBDIVISION OF PROPERTY THAT CREATED LOTS 1.01, 1.02, 2.01, 3.01, 3.02, 3.03, 3.04 & 4 IN BLOCK 6903. SUBDIVISION FILED ON JULY 10, 2019 WITH RECEIPT NO. 1514807.
- 3. EXISTING STATCO USE: <u>WAREHOUSE</u>
 PROPOSED EMERSON BUILDING COMPLEX USE: <u>MIXED-USE DEVELOPMENT</u>

BASED ON THE MUNICIPAL TAX MAP SHEET NUMBERS 69.

PERFORMANCE STANDARDS (COMMUNITY BENEFITS) (D.2.a-I)

PROVIDED WITH FINAL

DRAWINGS FOR PHASE III

SIDE OF MONMOUTH STREET A

PART OF THIS SITE'S MAJOR

WEST SIDE OF MONMOUTH

CONSTRUCTION ONGOING PROPERTY WILL BE CONVEYE

DETAILED DRAWINGS WILL BI PROVIDED AFTER EXPIRATION

CONSTRUCTION OF NEW

OF 13TH STREET IN PHASE I

CORNER OF 14TH & COLES STREET SHOWN ON THE

LOCATED ON 1ST & 2ND FLOOR

F. PROVIDED WITH 40 ON-SITE

ALONG 14TH STREET, +- 23,900

CONSTRUCTION ONGOING. PROPERTY WILL BE DEDICATED

PARKING SPACES

& CONVEYED AFTER CONSTRUCTION IS ACCEPTED

BY CITY OF JERSEY CITY.

DETAILED DRAWINGS WILL BE PROVIDED IN ACCORDANCE

WITH THE REDEVELOPMENT

PHASE I & II AS SHOW ON BOTH ENTRANCES ARE

18TH STREET

PHASE II - A

16TH STREET

6 STORIES

PHASE I

13TH STREET

PHASE I

BUILDING

14TH STREET

IN ACCORDANCE WITH THE

STORIES

PHASE

26 STORIES

PHASE II - B

REUSE OF THE ORIGINAL

CONSTRUCTION OF A 60'

DEDICATION OF A PUBLIC USE CONSTUCTION

COLES PARK (PARK FRONTING COLES ST.

WITH THE DESIGN

- 4. SUBJECT PROPERTY LIES ENTIRELY WITHIN THE JERSEY AVENUE PARK REDEVELOPMENT PLAN

COLES STREET ASSOCIATES, LLC 125 PARK AVENUE NEW YORK, NY 10017 TEL: (212) 372-2400

- 6. EXISTING BOUNDARY, TOPOGRAPHIC, AND UTILITY SURVEY DATA SOURCE: "ALTA / ACSM LAND TITLE SURVEY", PREPARED BY DRESDNER ROBIN FOR EMERSON LOFTS, LAST REVISION 11/06/18
- DEPICTED INFORMATION REGARDING EXISTING SITE TOPOGRAPHIC FEATURES, UTILITY SERVICES AND SUBSURFACE CONDITIONS ARE BASED ON INFORMATION FURNISHED BY OTHERS OR INTERPRETATION OF FEATURES READILY OBSERVABLE AT THE TIME OF URBAN ARCHITECTURE LLC SERVICE. UNLESS SPECIFICALLY NOTED, NO DETAILED OR INTRUSIVE INVESTIGATIONS OF UTILITY OR SUBSURFACE FEATURES HAVE BEEN UNDERTAKEN TO CONFIRM DEPICTED FEATURES AND URBAN ARCHITECTURE LLC ACCEPTS NO RESPONSIBILITY FOR THE ACCURACY OF INFORMATION PROVIDED BY OTHERS.
- MODIFICATIONS TO THESE DOCUMENTS, COPYING OF THESE DOCUMENTS, OR USE OF THESE DOCUMENTS FOR ANY PURPOSE OTHER THAN THEIR INTENDED USE IS PROHIBITED WITHOUT THE WRITTEN PERMISSION OF URBAN ARCHITECTURE LLC.
- THESE DOCUMENTS SHALL NOT BE USED FOR CONSTRUCTION PURPOSES PRIOR TO BEING "ISSUED FOR CONSTRUCTION" AND/OR PRIOR TO URBAN ARCHITECTURE LLC COMPLETING A PRE-CONSTRUCTION PLAN REVIEW.
- 10. FOR ZONING TABLE SEE ARCHITECTURAL PLANS; SHEET G-001.
- 11. THE ENTIRE SUBJECT PREMISES LIES WITHIN AN AREA SUBJECT TO THE 1% ANNUAL CHANCE FLOOD DESIGNATED AS ZONE AE (DESIGN FLOOD ELEVATION = 11 FT.), AS SHOWN ON A MAP ENTITLED, "FIRM, FLOOD INSURANCE RATE MAP, HUDSON COUNTY, NEW JERSEY (ALL JURISDICTIONS), PANEL 106 OF 118, COMMUNITY: JERSEY CITY, CITY OF, NUMBER: 340223, PANEL: 0106, SUFFIX: E, MAP NUMBER: 34017C0106E, PRELIMINARY DATE: JANUARY 30, 2015". ELEVATIONS ON THIS MAP ARE REFERENCED TO THE NORTH AMERICAN VERTICAL DATUM OF 1988 (NAVD 88).
- 12. ALL OR A PORTION OF THIS SITE LIES IN A FLOOD HAZARD AREA. CERTAIN ACTIVITIES IN FLOOD HAZARD AREAS ARE REGULATED BY THE NEW JERSEY DEPARTMENT OF ENVIRONMENTAL PROTECTION AND SOME ACTIVITIES MAY BE PROHIBITED ON THIS SITE OR MAY FIRST REQUIRE A PERMIT. CONTACT THE DIVISION OF LAND USE REGULATION AT (609) 292-0060 FOR MORE INFORMATION PRIOR TO ANY CONSTRUCTION ONSITE.

LIST OF DRAWINGS

NEIGHBORHOOD PHASING

SITI	E / CIVI	L / LANDSCAPE
1	G-005	CIVIL COVER SHEET
2	G-006	LEGEND AND GENERAL NOTES
3	C-15	REMOVALS PLAN 1
4	C-16	REMOVALS PLAN 2
5	C-17	EXISTING CONDITIONS PLAN 1
6	C-18	EXISTING CONDITIONS PLAN 2
7	C-19	OVERALL ROADWAY ALIGNMENT PLAN
8	C-20	SITE PLAN 1
9	C-21	SITE PLAN 2
10	C-25	TYPICAL ROADWAY SECTIONS 1
11	C-26	TYPICAL ROADWAY SECTIONS 2
12	C-30	GRADING & DRAINAGE PLAN 1
13	C-31	GRADING & DRAINAGE PLAN 2
14	C-32	INTERSECTION DETAIL PLANS
15	C-35	ROADWAY PROFILES 1
16	C-36	ROADWAY PROFILES 2
17	C-40	UTILITY PLAN 1
18	C-41	UTILITY PLAN 2
19	C-46	UTILITY PROFILES 1
20	C-47	UTILITY PROFILES 2
21	C-48	SANITARY LATERAL PROFILES
22	C-49	SANITARY LATERAL PROFILES 2
23	C-50	SOIL EROSION & SEDIMENT CONTROL PLAN 1
24	C-51	SOIL EROSION & SEDIMENT CONTROL PLAN 2
25	C-52	SOIL EROSION & SEDIMENT CONTROL DETAILS AND NOTES
26	C-60	LANDSCAPE AND LIGHTING PLAN 1
27	C-61	LANDSCAPE AND LIGHTING PLAN 2
28	C-65	LIGHTING DETAILS
29	C-90	CURB & SIDEWALK DESIGN DETAILS
30	C-91	LANDSCAPE & SITE FURNISHINGS DETAILS
31	C-92	BIO-PLANTER BUMPOUT DETAILS
32	C-93	SANITARY SEWER DETAILS
33	C-94	WATER SYSTEM DETAILS
34	C-95	STORM SEWER DETAILS
35	C-97	FLOOD MITIGATION PLANS
36	C-98	FLOOD CONTROL DETAILS

STREE	TAD	DRESS DE	SIGNATIONS
Building	Phase	Lot/Block	Address
Α	I	3.01/6903	315 15TH STREET
В	II	2.01/6903	325 15TH STREET
С	III	3.04/6903	316 15TH STREET
D	IV	3.03/6903	326 15TH STREET

PHASE 1 - SAD


PHASE II - A

PHASE II - B SITE WORK

-UPDATED LIMITS OF

PHASE IV SITE WORK

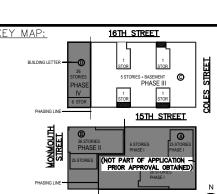CERTIFICATIONS CITY OF JERSEY CITY APPROVED BY THE PLANNING BOARD OF THE CITY OF JERSEY CITY AT A MEETING HELD ON THE___DAY OF______20___. SECRETARY DATE DATE



HORIZONTAL SCALE: 1"=400'

AS SHOWN

JDR

PRINCIPAL PLANNER

1JACKSON SQUARE

(201) 547-5010

CITY ENGINEER

(201) 547-4412

DIVISION OF PLANNING

JERSEY CITY, NJ 07305

13-15 LINDEN AVENUE EAST

MASSIEL FERRARA, PP, AICP, DIRECTOR

MEADOWVIEW COMPLEX - BLDG 1, FLOOR 2

ELECTRIC AND GAS UTILITY CARRIER
PUBLIC SERVICE ELECTRIC & GAS Co. (PSE&G)

JERSEY CITY, NJ 07305

595 COUNTY AVENUE

SECAUCUS, NJ 07302

(201) 217-5137

TYLER TORRACO

(201) 330-6438

ROOM #40P3

(973) 925-1489

KEVIN DAVIS

(201) 526-9978

325 COUNTY AVENUE

SECAUCUS, NJ 07094

ADRIAN C. DESROE

LIVINGSTON, NJ, 07039

CABLE AND BROADBAND

COMCAST OF JERSEY CITY

2121 KENNEDY BOULEVARD

WATER AND SEWER UTILITY AUTH.

JERSEY CITY MUNICIPAL UTILITIES AUTHORITY

JERSEY CITY, NJ 07305

RICH HAYTAS - SEWER

RAJIV PRAKASH - WATER

13-15 LINDEN AVE EAST

JERSEY CITY, NJ 07305

(201) 432-1150

VERIZON COMMUNICATIONS

290 W. MOUNT PLEASANT AVENUE,

300 Coles Street, Suite 2 | Jersey City, New Jersey 07310 | T 201.656.0314

UPDATED UTILITY LAYOUT REVISED STORM PIPE MATERIALS PER AVAILABILITY 06.30 EMERSON PHASE III - RED LINE UPDATED PHASE II PER ARCHATECTS UPDATED GROUND FLOOR BUILDING LAYOUT REVISED BUMPOUT WIDTH AT 15TH STREET EMERSON PHASE II - BUILDING PERMIT SUBMISSION 07.1 ADDED CONCRETE ADA RAMPS EMERSON COMPLEX - LIGHTING PLAN UPDATE UPDATED LIGHTING PHASE III - GAS & TELECOM LATERAL UPDATE PH III - BUILDING PERMIT PHASE III - REDLINE UPDATE PH II CRANE - UPDATE PHASE III - REDLINE UPDATE REVISED 14TH STREET PHASE II - ENTRANCE STAIR ELEVATION UPDATE REVISED 14TH ST SOUTH CURB PER AS-BUILT COND. 01.2

EMERSON LOFTS BLOCK 6903, LOTS 3.04 **255-259 COLES STREET, JEFFREY D. REEVES** JERSEY CITY, HUDSON COUNTY, NJ PROFESSIONAL ENGINEER
N.J. LICENSE NUMBER 24GEO4036700

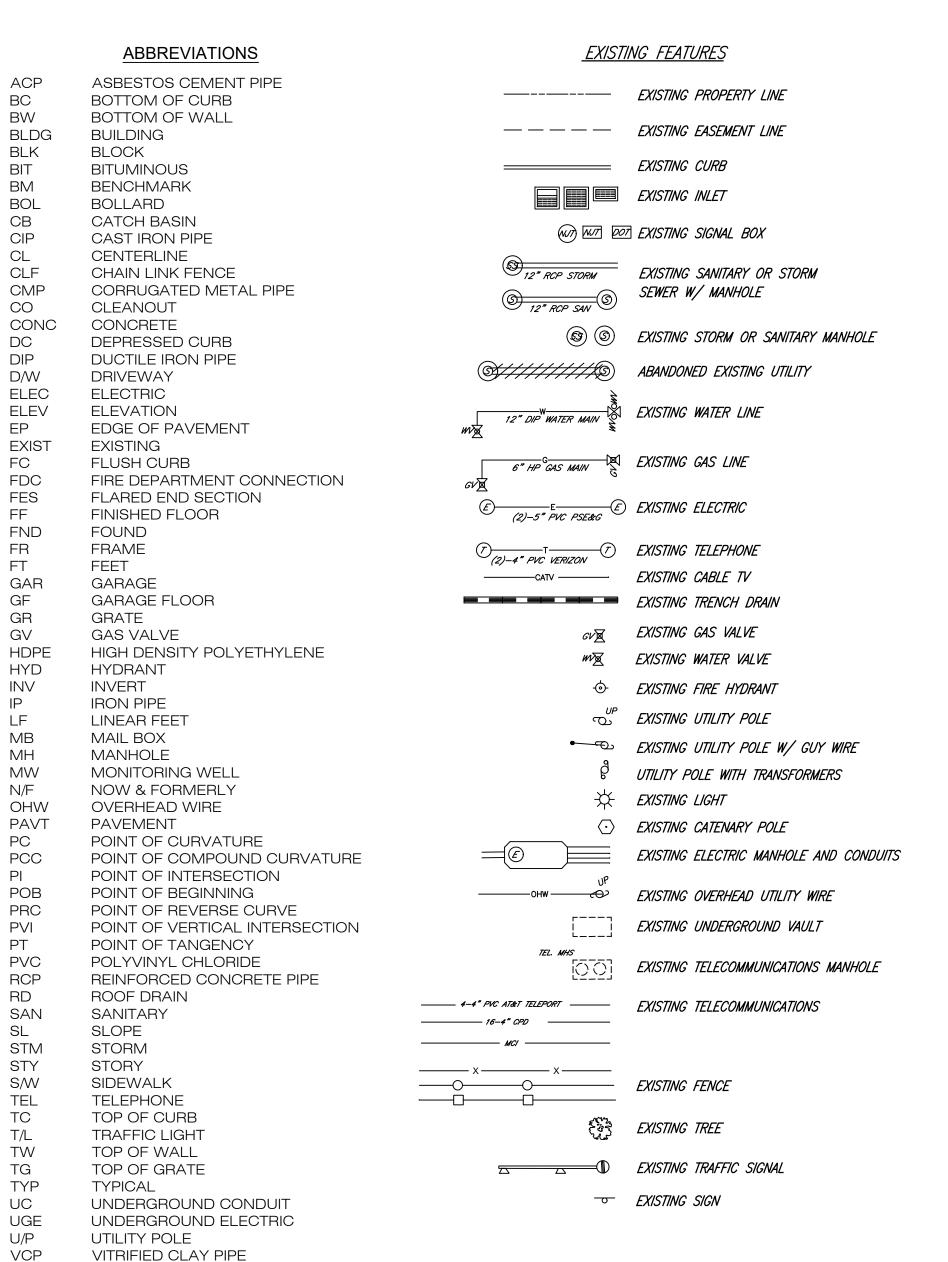
MAJOR SUBDIVISION

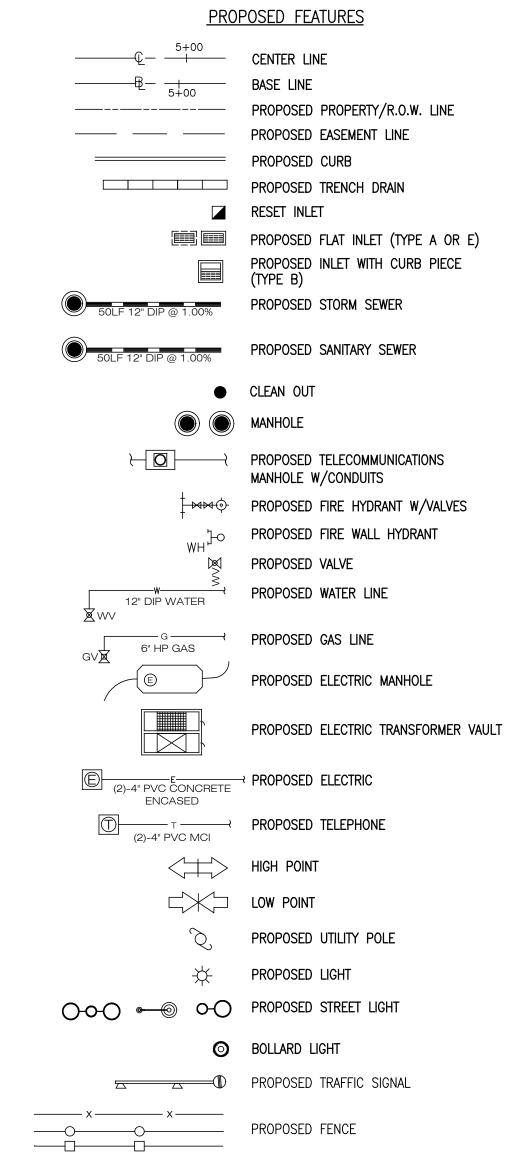
ALTA SURVEY

CIVIL COVER SHEET

Certificate of Authorization # 24GA28287900

Reeves Date: 10:49:58-05'00'





PROPOSED SIGN

JERSEY CITY DIVISION OF ENGINEERING NOTES

- 1. JERSEY CITY DIVISION OF ENGINEERING OFFICE TO BE NOTIFIED AT LEAST 72 HOURS PRIOR TO COMMENCEMENT OF CONSTRUCTION WORK.
- 2. TOWARD THE END OF CONSTRUCTION, JERSEY CITY DIVISION OF ENGINEERING RESERVES THE RIGHT TO INSPECT THE PROJECT AND IMPOSE ADDITIONAL IMPROVEMENTS TO ANY DAMAGED AREAS WITHIN THE CITY RIGHT OF WAY.
- 3. UPON COMPLETION OF THE CONSTRUCTION, AS BUILT DOCUMENTS MUST BE SUBMITTED TO JERSEY CITY DIVISION OF ENGINEERING AND JCMUA SHOWING ALL IMPROVEMENTS BOTH ABOVE AND UNDERGROUND FOR THE PROJECT.
- 4. ALL IMPROVEMENTS MUST COMPLY WITH THE REQUIREMENTS OF THE CITY OF JERSEY CITY, DIVISION OF ENGINEERING CONSTRUCTION GUIDELINES FOR STREET OPENINGS WITHIN THE PUBLIC RIGHT OF WAY.
- 5. A SITE LOGISTICS PLAN AND CONSTRUCTION STAGING PLAN SHALL BE SUBMITTED TO THE JERSEY CITY BUILDING DEPARTMENT AND DIVISION OF ENGINEERING PRIOR TO CONSTRUCTION. PLANS TO INCLUDE BUT NOT BE LIMITED TO; COMMENCEMENT DATES, PEDESTRIAN PROTECTION METHODS LOCATION OF PARKING, TRAILERS, VEHICLE LOADING AND UNLOADING, ETC.
- 6. ALL REMOVED MATERIAL AND DEBRIS AND ALL ITEMS REMOVED FROM THE PROPERTY AND PUBLIC AREAS ADJACENT (EXCEPT AS NOTED), SHALL BE DISPOSED OUTSIDE THE CITY LIMITS OF JERSEY CITY IN ACCORDANCE WITH THE RULES AND REGULATIONS OF THE CITY'S ENVIRONMENTAL COMMISSION AND IN ACCORDANCE WITH THE RULES AND REGULATIONS OF NJDEP

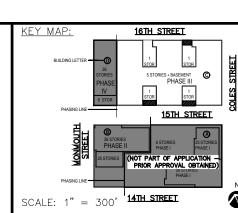
MAP REFERENCES:

- 1. BASE MAP INFORMATION SHOWN BASED ON DRAWING TITLED "BOUNDARY & TOPOGRAPHIC SURVEY" PREPARED BY DRESDNER ROBIN, DATED JUNE 3, 2016,LAST REVISED JUNE 27, 2016.
- 2. ELEVATIONS ARE REFERENCED TO THE NORTH AMERICAN VERTICAL DATUM OF 1988 (NAVD88) BASED ON DRAWING TITLED "BOUNDARY & TOPOGRAPHIC SURVEY" PREPARED BY DRESDNER ROBIN DATED JUNE 3, 2016, LAST REVISED JUNE 27, 2016.
- 3. CITY OF JERSEY CITY TAX ASSESSMENT MAP SHEET NO. 69.
- 4. SURVEY BASE MAP SUPPLEMENTED WITH INFORMATION OBTAINED FROM UTILITY COMPANIES AND THROUGH URBAN FIELD OBSERVATIONS.
- 5. "MAJOR SUBDIVISION, 614 MONMOUTH STREET, 255-259 COLES STREET, LOTS 1, 2 AND 3, BLOCK 6903, CITY OF JERSEY CITY, HUDSON COUNTY, NEW JERSEY" PREPARED BY DRESDNER ROBIN, DATED MARCH 26, 2018, REVISED THROUGH SEPTEMBER 26, 2018. MAP FILED WITH THE HUDSON COUNTY REGISTER OF DEEDS ON JULY 10, 2019; MAP RECEIPT NO. 1514807.
- 6. THE ENTIRE SUBJECT PREMISES LIES WITHIN AN AREA SUBJECT TO THE 1% ANNUAL CHANCE FLOOD DESIGNATED AS ZONE AE (DESIGN FLOOD ELEVATION = 11 FT.), AS SHOWN ON A MAP ENTITLED, "FIRM, FLOOD INSURANCE RATE MAP, HUDSON COUNTY, NEW JERSEY (ALL JURISDICTIONS), PANEL 106 OF 118, COMMUNITY: JERSEY CITY, CITY OF, NUMBER: 340223. PANEL: 0106. SUFFIX: E. MAP NUMBER: 34017C0106E. PRELIMINARY DATE: JANUARY 30, 2015". ELEVATIONS ON THIS MAP ARE REFERENCED TO THE NORTH AMERICAN VERTICAL DATUM OF 1988 (NAVD
- 7. ALL OR A PORTION OF THIS SITE LIES IN A FLOOD HAZARD AREA. CERTAIN ACTIVITIES IN FLOOD HAZARD AREAS ARE REGULATED BY THE NEW JERSEY DEPARTMENT OF ENVIRONMENTAL PROTECTION AND SOME ACTIVITIES MAY BE PROHIBITED ON THIS SITE OR MAY FIRST REQUIRE A PERMIT. CONTACT THE DIVISION OF LAND USE REGULATION AT (609) 292-0060 FOR MORE INFORMATION PRIOR TO ANY CONSTRUCTION ONSITE.



GENERAL NOTES

- 1. URBAN ARCHITECTURE ACCEPTS NO RESPONSIBILITY FOR THE MODIFICATION, COPYING OR USE OF THESE DOCUMENTS BY ANY PARTY. THESE DOCUMENTS ARE ONLY INTENDED FOR USE BY THE CLIENT TO WHICH WE ARE CONTRACTED FOR OUR SERVICES.
- 2. THE USE OF THIS PLAN, OR SET OF PLANS, MAY BE DEFICIENT ON ITS OWN TO PROPERLY COMPLETE THE IMPROVEMENTS SHOWN HEREIN THIS PLAN MAY BE PART OF A MORE COMPREHENSIVE SET OF PLANS AND MAY ONLY PARTIALLY REPRESENT THE INTENDED IMPROVEMENTS OR WORK. EACH INDIVIDUAL PLAN CONTAINS RELEVANT INFORMATION FOR A SPECIFIC PURPOSE, BUT INTENDED TO BE USED IN CONJUNCTION WITH THE REMAINDER OF THE PLAN SET. FURTHERMORE, THE ENTIRE PLAN SET MAY REQUIRE ADDITIONAL INFORMATION REPRESENTED IN DESIGN DOCUMENTS BY OTHERS (I.E. ARCHITECTURAL PLANS, ROADWAY PLANS, STRUCTURAL PLANS, GEOTECHNICAL REPORTS, ETC.) IN ORDER TO PROPERLY PERFORM
- 3. THESE DOCUMENTS ARE PREPARED FOR THE PURPOSES OF REVIEW BY VARIOUS REGULATORY AGENCIES AND ARE NOT REPRESENTED AS SUITABLE FOR ANY OTHER PURPOSE. INFORMATION SHOWN HEREIN GENERALLY DEPICTS A PROJECT LOCATION, PROPERTY LIMIT, USE, SCOPE AND NATURE OF IMPROVEMENTS. PLAN DIMENSIONS ARE FURNISHED SOLELY IN SUPPORT OF THE FOREGOING DEFINITION AND ARE NOT REPRESENTED AS BEING SUITABLE FOR ANY OTHER USE.
- EXISTING TOPOGRAPHIC FEATURES, UTILITIES AND SUBSURFACE CONDITIONS SHOWN HEREIN ARE BASED ON SURVEY INFORMATION OR INFRASTRUCTURE RECORDS FURNISHED BY OTHERS OR AN INTERPRETATION OF FEATURES READILY OBSERVABLE AT THE TIME OF URBAN ARCHITECTURE'S SERVICE. UNLESS SPECIFICALLY NOTED, NO DETAILED OR INTRUSIVE INVESTIGATIONS OF UTILITY OR SUBSURFACE FEATURES HAVE BEEN UNDERTAKEN TO CONFIRM DEPICTED FEATURES. URBAN ARCHITECTURE ACCEPTS NO RESPONSIBILITY FOR THE ACCURACY OF INFORMATION PROVIDED BY OTHERS.
- 5. FOUR DAYS PRIOR TO COMMENCING WORK, PURSUANT TO NEW JERSEY'S UNDERGROUND FACILITY PROTECTION ACT (N.J.S.A. 48:2-73), THE CONTRACTOR MUST CONTACT THE NEW JERSEY ONE CALL SYSTEM AT (800) 272-1000 OR 811 FOR A MARKOUT OF ALL PUBLIC UTILITY LINES ON AND ADJACENT TO THE WORKSITE. AS REQUIRED BY THE REGULATIONS AT N.J.A.C. 14:2, THE CONTRACTOR MUST ALLOW FOR THE REQUIRED WAITING PERIOD TO EXPIRE PRIOR TO EXCAVATION IN ORDER TO ENSURE THAT ALL PUBLIC UTILITY LINES ARE MARKED. PRIVATE UTILITY LINES MAY EXIST WITHIN THE WORK AREA AND MAY OR MAY NOT BE MARKED. CARE SHOULD BE TAKEN TO AVOID DAMAGING ALL UTILITY LINES (MARKED AND UNMARKED) DURING EXCAVATION WORK.
- 6. UTILITY AND OTHER CONSTRUCTION NOTES, WHERE SHOWN ON THE DOCUMENTS, ARE PROVIDED AS REQUESTED BY REGULATORY REVIEW AGENCIES AND/OR QUASI-GOVERNING AGENCIES SUCH AS UTILITY PROVIDERS.
- 7. EXISTING INFORMATION SHOWN HEREIN SHALL BE VERIFIED BY THE CONTRACTOR PRIOR TO COMMENCING CONSTRUCTION, CONSTRUCTION LAYOUT OR ORDERING MATERIALS. THE ENTITY RESPONSIBLE FOR CONSTRUCTION LAYOUT SHALL VERIFY HORIZONTAL AND VERTICAL LOCATION OF INFORMATION SHOWN WITHIN THESE DOCUMENTS UTILIZING AN INDEPENDENT VERIFICATION AND IMMEDIATELY REPORT ANY DEVIATIONS TO URBAN ARCHITECTURE PRIOR TO CONSTRUCTION.
- 8. THE IMPLEMENTATION OF ALL APPLICABLE WORKSITE SAFETY REGULATIONS, INCLUDING THOSE REQUIRED BY THE UNITED STATES OCCUPATIONAL SAFETY AND HEALTH ADMINISTRATION (OSHA) AND ALL STATE AND LOCAL AUTHORITIES HAVING JURISDICTION, ARE THE SOLE RESPONSIBILITY OF THE CONTRACTOR. OSHA WORKSITE SAFETY REGULATIONS ARE PUBLISHED AT 29 CFR 1926 WITHIN VARIOUS SUBPARTS RELATIVE TO SPECIFIC TYPES OF WORK. URBAN ARCHITECTURE TAKES NO RESPONSIBILITY FOR WORKSITE SAFETY PROVISIONS RELATIVE TO THE ONSITE WORK FORCE.
- 9. THE CONTRACTOR SHALL COMPLY WITH APPLICABLE STATE, FEDERAL AND LOCAL CODED AND SHALL OBTAIN ALL NECESSARY LICENSES AND PERMITS.
- 10. ALL REMOVALS SHALL BE SHOWN ON THE DRAWINGS AND/OR AS DIRECTED BY THE ENGINEER AND OWNER, TO THE SATISFACTION OF THE ENGINEER AND OWNER
- 11. THE CONTRACTOR SHALL EXERCISE CARE DURING THE REMOVAL OPERATIONS TO PROTECT EXISTING FACILITIES TO REMAIN INCLUDING: PAVEMENTS, CURBS, UTILITIES, STRUCTURES, TREES, ETC. ANY FACILITIES THAT ARE TO REMAIN THAT ARE DAMAGED SHALL BE THE RESPONSIBILITY OF THE CONTRACTOR AND SHALL BE RESTORED AT THE CONTRACTORS EXPENSE.
- 12. ALL PAVED WALKWAYS AND ROADS MUST BE KEPT CLEAN AND FREE OF DEBRIS FOR THE DURATION OF THE CONTRACT.
- 13. EXISTING CURB AND PAVEMENTS TO BE REMOVED SHALL BE SAW CUT AS REQUIRED TO A STRAIGHT LINE SECTION AS TO PROVIDE A CLEAN SMOOTH AND EVEN TRANSITION OF NEW CURBS AND PAVEMENTS WITH NO TRIP HAZARDS.
- 14. ALL WORK TO BE DONE OUTSIDE OF THE CONSTRUCTION FENCE IS TO BE PROTECTED AT ALL TIMES. CONTRACTOR IS RESPONSIBLE FOR THE PROTECTION OF ALL WORK AREAS AND EXISTING TREES ADJACENT TO WORK AREAS
- 15. ALL WORK TO BE DONE IN ACCORDANCE WITH: A. CERTIFIED SOIL EROSION AND SEDIMENT CONTROL PLAN B. CITY OF JERSEY CITY STANDARDS
- 16. ALL ABANDONED SUBSURFACE UTILITIES ENCOUNTERED OR MARKED FOR ABANDONMENT ARE TO BE FILLED AND SEALED AS PER JERSEY CITY STANDARDS.
- 17. SHOULD FIELD CONDITIONS VARY FROM THE DRAWINGS, CONTRACTOR SHALL NOTIFY THE OWNER AND ENGINEER PRIOR TO REMOVAL.
- 18. ALL SIGNAGE THAT IS TO BE REMOVED SHALL BE PHOTOGRAPHED, CATALOGUED AND SUBMITTED TO THE ENGINEER PRIOR TO REMOVAL.
- 19. ALL TRAFFIC CONTROL SIGNALS, JUNCTION BOXES, VALVE COVERS, CLEANOUTS, MANHOLES, ELECTRIC TRANSFORMER GRATES, AND MANHOLES, HANDHOLES, ECT. THAT REQUIRE RESETTING DUE TO REGRADING OF THE R.O.W. ARE THE RESPONSIBILITY OF THE CONTRACTOR. IT IS THE CONTRACTORS RESPONSIBILITY TO CONTACT THE APPROPRIATE UTILITY COMPANY IN ADVANCE PRIOR TO RESETTING.
- 20. CONTRACTOR SHALL KEEP A COPY OF THE APPROVED SOIL EROSION CONTROL DRAWINGS AND PERMIT ON SITE AT ALL TIMES IN ACCORDANCE WITH HEP-SESC REQUIREMENTS. ALL FINES AS A RESULT OF FAILURE TO COMPLY WITH THE PERMIT SHALL BE THE RESPONSIBILITY OF THE CONTRACTOR.



AS SHOWN

JDR

WATER VALVE

300 Coles Street, Suite 2 | Jersey City, New Jersey 07310 | T 201.656.0314 Certificate of Authorization # 24GA28287900

UPDATED UTILITY LAYOUT REVISED STORM PIPE MATERIALS PER AVAILABILITY EMERSON PHASE III - RED LINE UPDATED PHASE II PER ARCHATECTS UPDATED GROUND FLOOR BUILDING LAYOUT REVISED BUMPOUT WIDTH AT 15TH STREE EMERSON PHASE II - BUILDING PERMIT SUBMISSION ADDED CONCRETE ADA RAMP EMERSON COMPLEX - LIGHTING PLAN UPDATE UPDATED LIGHTING PHASE III - GAS & TELECOM LATERAL UPDATE PH III - BUILDING PERMIT PHASE III - REDLINE UPDAT PH II CRANE - UPDATE PHASE III - REDLINE UPDATE REVISED 14TH STREET PROFESSIONAL ENGINEER
N.J. LICENSE NUMBER 24GEO4036700 PHASE II - ENTRANCE STAIR ELEVATION UPDATE REVISED 14TH ST SOUTH CURB PER AS-BUILT COND. 01.

PHASE III **BLOCK 6903**, LOTS 3.04 **255-259 COLES STREET,** JERSEY CITY, HUDSON COUNTY, NJ

JEFFREY D. REEVES

EMERSON LOFTS LEGEND AND GENERAL NOTES

> Reeves Date: 2023.11.28 10:50:16-05'00'

5.48LOCK 6004 PROPOSED LOT 1.02 REMOVALS NOTES: ALL AREAS OUTSIDE THE LIMITS OF CONSTRUCTION THAT ARE DAMAGED BY THE CONTRACTOR SHALL BE RESTORED TO THEIR ORIGINAL CONDITION TO THE SATISFACTION OF THE ENGINEER AND OWNER. EXISTING FACADE TO - EXISTING SIDEWALK AND - WINDOW WELL BE REMOVED (TYP.) CURB TO BE REMOVED ALL WORK MUST BE PERFORMED IN SUCH A MANNER TO PROTECT AND PREVENT DAMAGE TO SURROUNDING PROPERTY, TO MAINTAIN A SAFE WORK ENVIRONMENT, AND TO ENABLE WORK AND BUSINESSES AT THE SITE TO PROCEED WITH MINIMAL AND 3. THE CONTRACTOR SHALL CEASE WORK IMMEDIATELY IF AN ADJACENT STRUCTURE APPEARS TO BE IN DANGER OF DAMAGE AND WILL TAKE NECESSARY ACTION TO SOHO LOFTS STABILIZE THE SITUATION. - EXISTING BUILDING · MULTI STORY BUILDING TO BE RENOVATED 4. THE CONTRACTOR SHALL EXERCISE CARE DURING REMOVAL OPERATIONS TO BLOCK 7005 LOT 1.01 BE THE RESPONSIBILITY OF THE CONTRACTOR AND SHALL BE RESTORED AT THE BLOCK 6903 LOT 3 - EXISTING ASPHALT TO BE REMOVED AND 6. THE CONTRACTOR SHALL MAINTAIN ACTIVE UTILITIES, REQUIRED FOR SERVICE, AND STOCKPILED FOR REUSE AS FILL (TYP.) EXISTING SIDEWALK AND -CURB TO BE REMOVED — EXISTING FACADE TO — BE REMOVED (TYP.) COUNTY AND OTHER JURISDICTIONS FOR MARK-OUT OF ALL UTILITIES. ALL · EXISTING FIRE HYDRANT & VALVE TO BE REMOVED PART OF THE WORK SHALL BE DONE IN CONFORMANCE WITH WRITTEN APPROVAL, EXISTING WATER SERVICE -EXISTING CONCRETE AND FIRE LINE TO BE MODIFIED AND WITH THE REQUIREMENTS OF THE MUNICIPALITY OR UTILITY COMPANY. STEPS TO BE REMOVED (SEE MECHANICAL DRAWINGS) — PORTION OF EXISTING 12" WATER 3. THE LOCATION AND DEPTH OF ALL SUBSURFACE UTILITIES SHOWN ARE APPROXIMATE EXISTING SEWER LATERAL MAIN TO BE REMOVED AND ARE BASED ON OBVIOUS ABOVE GROUND PHYSICAL UTILITY APPURTENANCES. O BE REMOVED CONFLICT PRIOR TO CONSTRUCTION. ANY DISCREPANCIES BETWEEN FIELD VERIFIED UTILITIES AND THOSE SHOWN ON THE DRAWING SHALL BE REPORTED TO THE ABANGONES WATER MANO ENGINEER AND OWNER. 9. THE CONTRACTOR SHALL OBTAIN ALL NECESSARY PERMITS, PAY ALL NECESSARY FEES, ETC. AS REQUIRED TO PERFORM THE WORK. E REMOVED 10. THE CONTRACTOR SHALL COMPLY WITH ALL APPLICABLE CODES AND REGULATIONS GOVERNING THE WORK. THE CONTRACTOR SHALL COORDINATE REMOVALS WITH APPLICABLE AGENCIES AND UTILITY COMPANIES. 11. EXISTING CURB AND PAVEMENTS TO BE REMOVED SHALL BE SAWCUT AS REQUIRED IN A STRAIGHT LINE TO PROVIDE A CLEAN SMOOTH AND EVEN TRANSITION FOR NEW CURBS AND PAVEMENTS WITH NO TRIP HAZARDS. 12. ALL REMOVED MATERIAL/ITEMS, AND DEBRIS FROM THE PROJECT, SHALL BE DISPOSED OUTSIDE THE CITY LIMITS OF JERSEY CITY IN ACCORDANCE WITH THE RULES AND REGULATIONS OF JERSEY CITY'S ENVIRONMENTAL COMMISSION AND IN ACCORDANCE WITH THE REGULATIONS AND LAWS OF THE NJDEP OR AS SHOWN ON THE APPROVED × 8.56 13. ALL PAVED WALKWAYS AND ROADS MUST BE KEPT CLEAN AND FREE OF DEBRIS FOR THE DURATION OF THE PROJECT BLOCK 7004 LOT 2 14. ALL TRAFFIC CONTROL SIGNALS, JUNCTION BOXES, VALVE COVERS, CLEANOUTS MANHOLES, ELECTRIC TRANSFORMER GRATES AND MANHOLES, HANDHOLES, ETC. CONCRETE PAD, AND THAT REQUIRE RESETTING DUE TO DEGRADING OF THE R.O.W. ARE THE INV=6.18 IN (NW) INV=2.58 IN (S) INV=3.94 IN (E) INV=2.52 OUT STEPS TO BE REMOVED EXISTING BUILDING RESPONSIBILITY OF THE CONTRACTOR. IT IS THE CONTRACTORS RESPONSIBILITY TO BMOCK 7004 TO BE REMOVED CONTACT THE APPROPRIATE UTILITY COMPANY IN ADVANCE PRIOR TO RESETTING. 15. CONTRACTORS SHALL KEEP A COPY OF THE APPROVED SOIL EROSION CONTROL DRAWINGS AND PERMIT ON SITE AT ALL TIMES IN ACCORDANCE WITH HEP-SESC REQUIREMENTS. ALL FINES AS RESULT OF FAILURE TO COMPLY WITH THE PERMIT SHALL BE THE RESPONSIBILITY OF THE CONTRACTOR. MANHOLE -RIM=7.89 INV=3.25 IN (S) INV=3.83 IN (E) INV=3.25 OUT EXISTING ASPHALT TO BE REMOVED AND PSE&G NOTES: STOCKPILED FOR REUSE AS FILL 1. ALL GAS LINES TO BE CUT/CAPPED BY PSE&G. MANHOLE— RIM=8.05 INV=4.45 IN (N) INV=3.85 IN (S) DOOR SILL INV=4.46 IN (SE) INV=3.85 OUT 2. UTILITY POLES, WIRES, ETC. SHALL BE CUT, CAPPED ABANDONED, OR REMOVED BY EXISTING CONCRETE PAD EXISTING SEWER LATERAL 3. CONTRACTOR IS RESPONSIBLE FOR COORDINATING AND SCHEDULING REMOVALS TO BE REMOVED TO BE REMOVED WITH PSE&G. *PLEASE NOTE THAT THE SCHEDULING REMOVALS AND/OR RELOCATIONS RAMP TO U.S. ROUTE No. 1 BY PSE&G MAY INCLUDE LONG LEAD TIMES AND IT IS THE CONTRACTORS EXISTING COMBINED RESPONSIBILITY TO NOTIFY AND SCHEDULE THE WORK IN ADVANCE SO AS TO NOT EXISTING UTILITY POLES TO BE REMOVED (TYP.) SEWER TO BE REMOVED EXISTING CONCRETE SIDEWAL 4. CONTRACTOR SHALL BE RESPONSIBLE FOR OBTAINING ALL REQUIRED INSPECTIONS TO BE REMOVED **GENERAL NOTES:** AND/OR SIGN-OFFS. 5. CONTRACTOR SHALL CONTACT PSE&G DEMOLITION DIVISION AT (908) 709-6861 FOR INSPECTION OF THE ITEMS TO BE REMOVED PRIOR TO CONSTRUCTION. THE 1. EXISTING CONDITIONS AS OF SITE PLAN SUBMISSION, OCTOBER CONTRACTOR SHALL BE RESPONSIBLE FOR COORDINATION WITH THE PSE&G UNTIL EXISTING METAL COVER TO BE INVESTIGATED THE NECESSARY APPROVALS ARE PRODUCED. ADEQUATE NOTICE & TIME SHALL BE AND REMOVED GIVEN TO WORK ASSOCIATED WITH PSE&G AS IT MAY AFFECT THE OVERALL 2. EXISTING LOTS AND BLOCKS SHOWN ARE PRIOR TO EMERSON CONSTRUCTION SCHEDULE. LOFTS MAJOR SUBDIVISION DATED SEPTEMBER 23, 2018. **LEGEND** — — — - SAWCUT LINE - REMOVE EXISTING PIPE / UTILITY - BUILDING / STRUCTURE TO BE REMOVED INV=1.46 IN (NW) INV=1.39 OUT BLOCK 7003 - REMOVE EXISTING SIDEWALK, ASPHALT - REMOVE ITEM --- REMOVE ITEMŚ ALONG - ITEM TO BE PROTECTED MONMOUTH STREET AS NEEDED MATCH LINESTA. 3+50 (SEE DRAWING NO. C-16) **EMERSON LOFTS** UPDATED UTILITY LAYOUT REVISED STORM PIPE MATERIALS PER AVAILABILITY 06.30 UPDATED PHASE II PER ARCHATECTS EMERSON PHASE III - RED LINE PHASE III REMOVALS PLAN 1 UPDATED GROUND FLOOR BUILDING LAYOUT HORIZONTAL SCALE: 1"=30'-0" EMERSON PHASE II - BUILDING PERMIT SUBMISSION BLOCK 6903, EMERSON COMPLEX - LIGHTING PLAN UPDATE UPDATED LIGHTING

300 Coles Street, Suite 2 | Jersey City, New Jersey 07310 | T 201.656.0314 Certificate of Authorization # 24GA28287900

4LE: 1" = 300" 14TH STREET

LOTS 3.04

255-259 COLES STREET,

JERSEY CITY, HUDSON COUNTY, NJ

By Jeffre Reeves Date:

2023.11.28 10:51:21-05'00'

JEFFREY D. REEVES
PROFESSIONAL ENGINEER
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6 PH III - BUILDING PERMIT

PH II CRANE - UPDATE


08.29.23 29 REVISED 14TH ST SOUTH CURB PER AS-BUILT COND. 01.28

28 REVISED 14TH STREET

PHASE III - GAS & TELECOM LATERAL UPDATE

PHASE II - ENTRANCE STAIR ELEVATION UPDATE

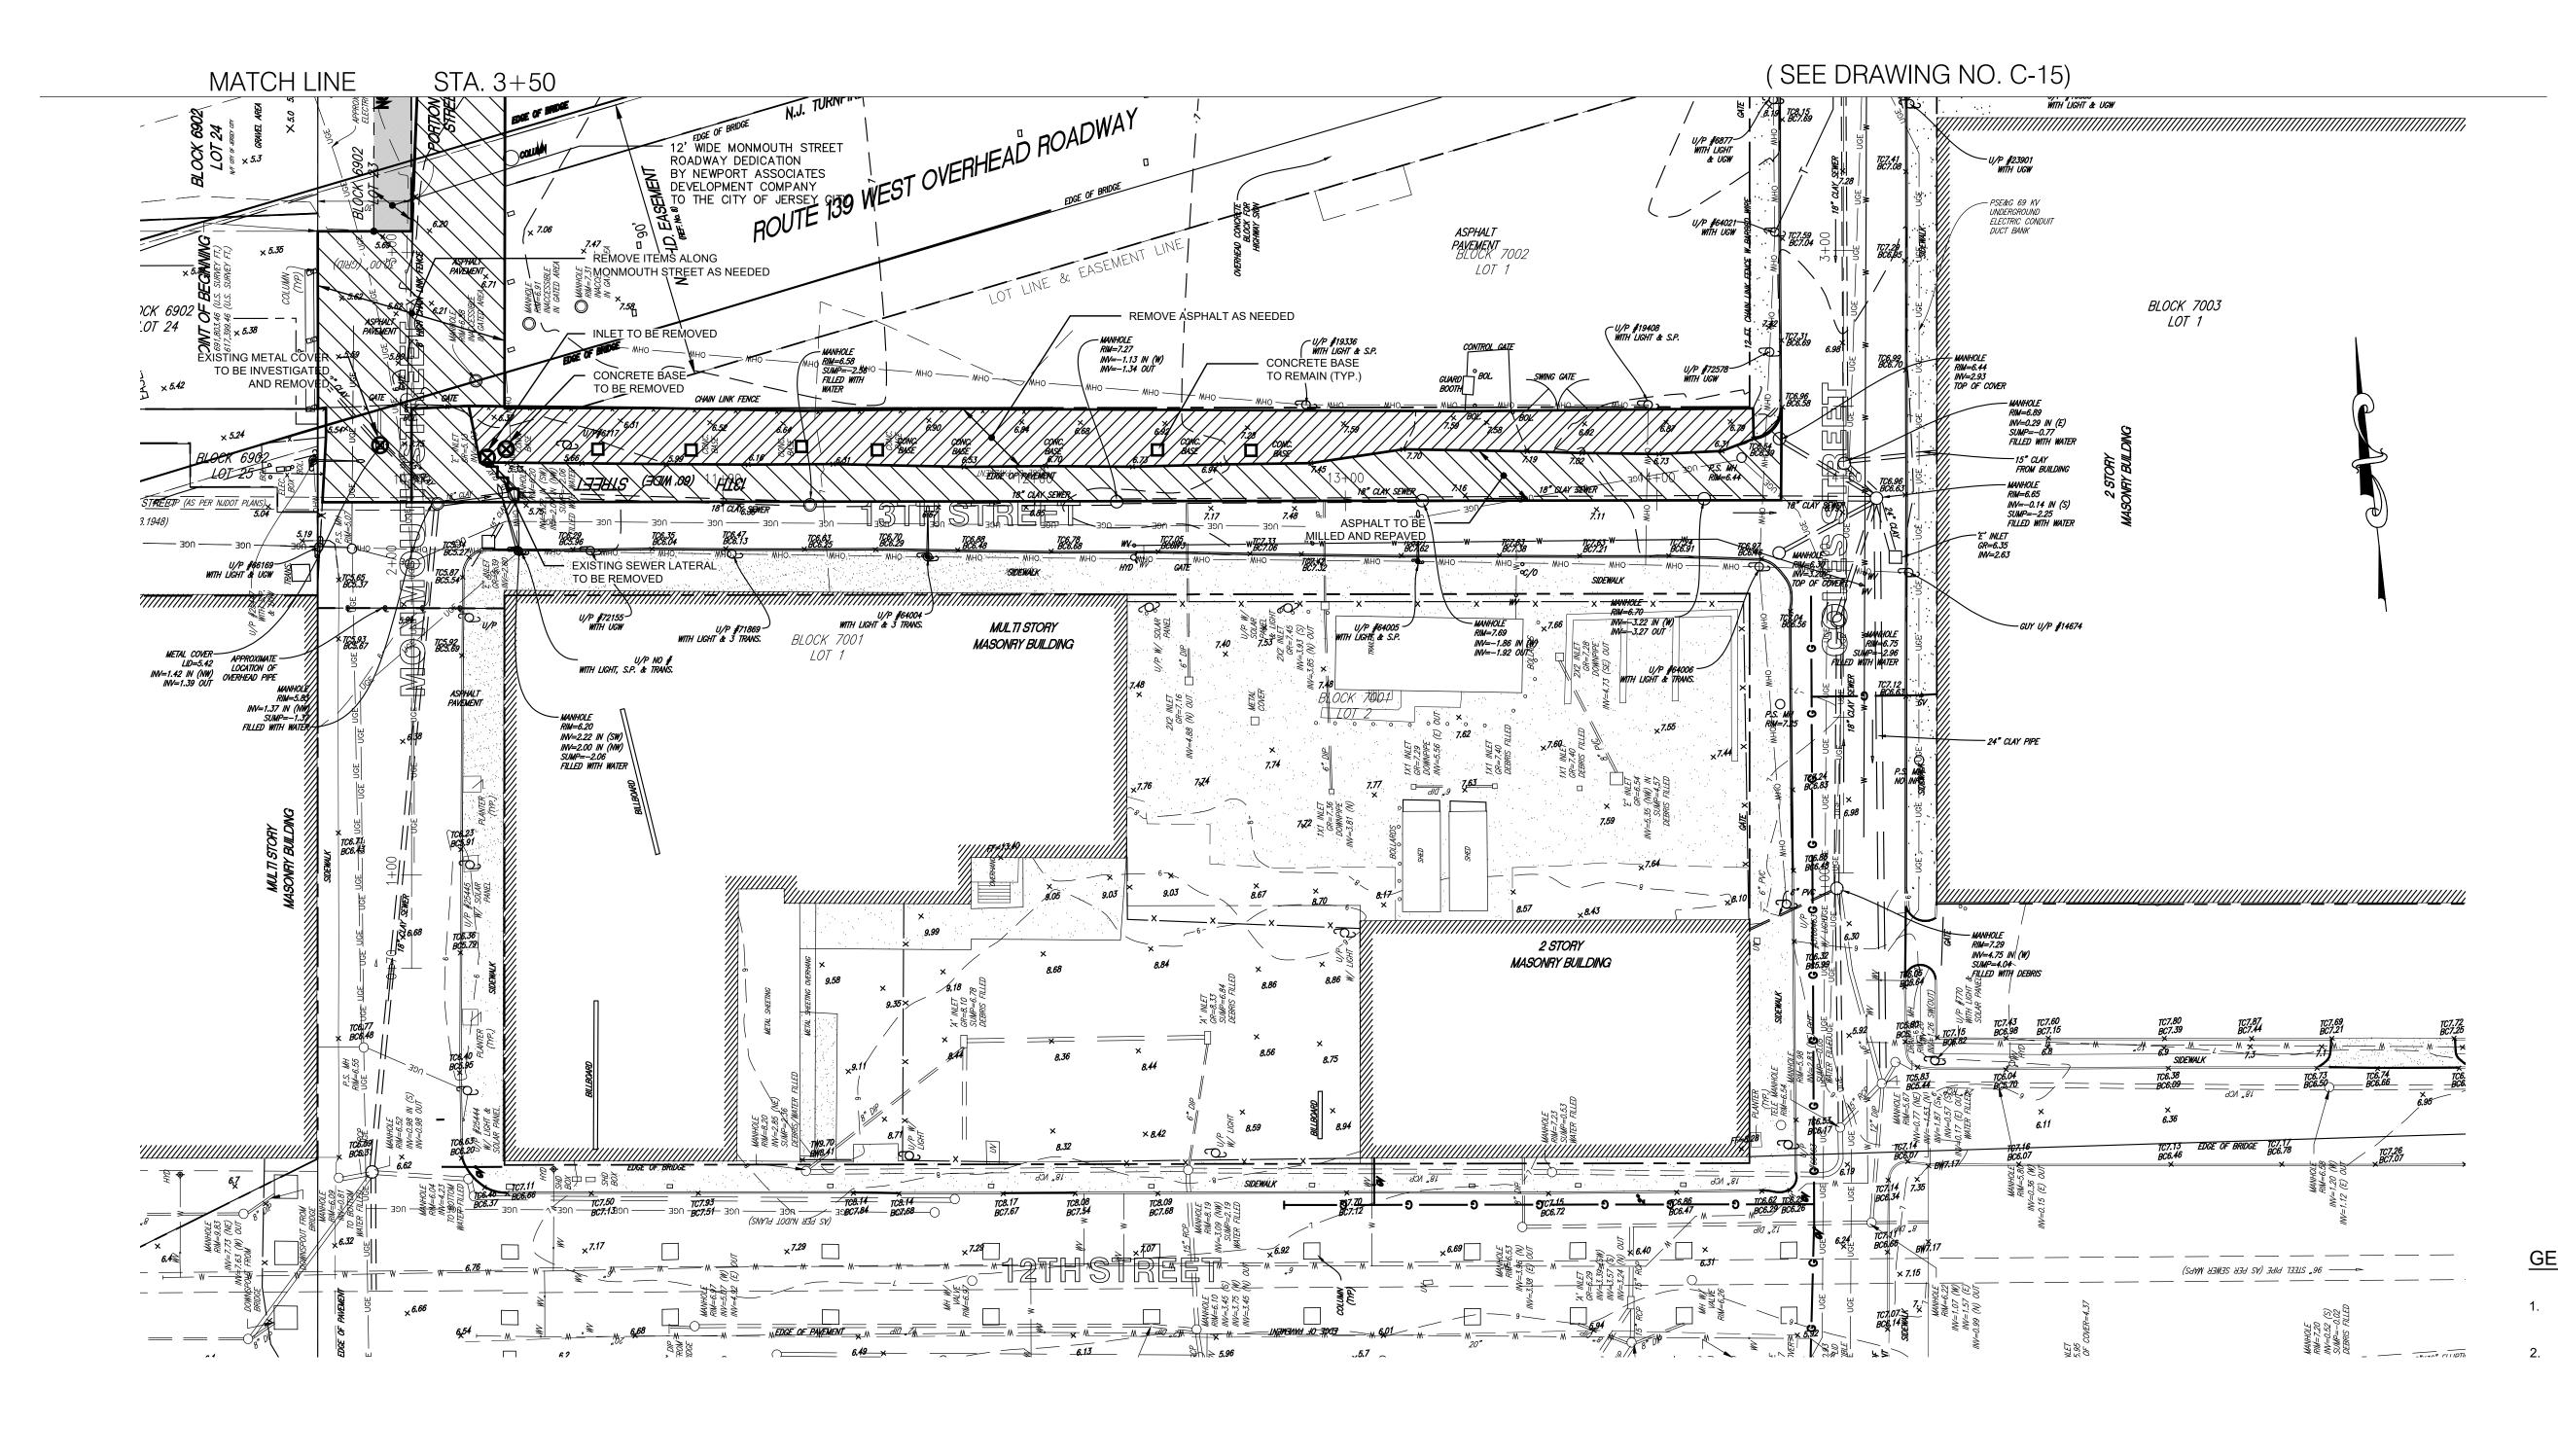PHASE III - REDLINE UPDATE



GENERAL NOTES:

- 1. EXISTING CONDITIONS AS OF SITE PLAN SUBMISSION, OCTOBER 31, 2018.
- 2. EXISTING LOTS AND BLOCKS SHOWN ARE PRIOR TO EMERSON LOFTS MAJOR SUBDIVISION DATED SEPTEMBER 23, 2018.

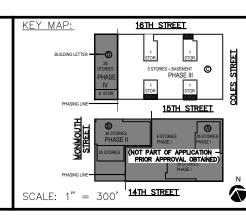
LEGEND

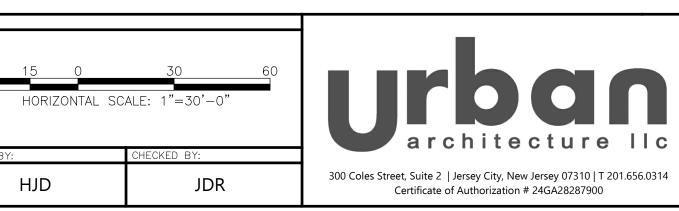
— — — - SAWCUT LINE - REMOVE EXISTING PIPE / UTILITY

- BUILDING / STRUCTURE TO BE REMOVED - REMOVE EXISTING SIDEWALK, ASPHALT, CONCRETE, ETC.

- REMOVE ITEM

- ITEM TO BE PROTECTED







DATE	NO.	DESCRIPTIONS	DATE	NO.	DESCRIPTIONS	DATE	
	31	UPDATED UTILITY LAYOUT	03.14.22	21	REVISED STORM PIPE MATERIALS PER AVAILABILITY	06.30.21	
	32	EMERSON PHASE III - RED LINE	04.26.22	22	UPDATED PHASE II PER ARCHATECTS	08.12.21	
	33	UPDATED GROUND FLOOR BUILDING LAYOUT	05.14.22	23	REVISED BUMPOUT WIDTH AT 15TH STREET	08.26.21	
	34	EMERSON PHASE II - BUILDING PERMIT SUBMISSION	07.12.22	24	ADDED CONCRETE ADA RAMPS	09.13.21	
	35	EMERSON COMPLEX - LIGHTING PLAN UPDATE	12.05.22	25	UPDATED LIGHTING	11.03.21	
	36	PHASE III - GAS & TELECOM LATERAL UPDATE	03.13.23	26	PH III - BUILDING PERMIT	11.18.21	
	37	PHASE III - REDLINE UPDATE	04.26.23	27	PH II CRANE - UPDATE	01.04.22	
	38	PHASE III - REDLINE UPDATE	07.17.23	28	REVISED 14TH STREET	01.05.22	JEFFREY D. REEVES
	39	PHASE II - ENTRANCE STAIR ELEVATION UPDATE	08.29.23	29	REVISED 14TH ST SOUTH CURB PER AS-BUILT COND.	01.28.22	PROFESSIONAL ENGINEER N.J. LICENSE NUMBER 24GEO4036700
	40	PHASE III - SITE PLAN AMENDMENT SUBMISSION	09.18.23	30	REVISED PH II GRADES	01.28.22	All rights reserved. The Drawings/Design are the Intellectual property of Urban Architecture LLC. They not be copied, altered or used without express written consent by Urban Architecture LLC.

EMERSON LOFTS PHASE III BLOCK 6903, LOTS 3.04 255-259 COLES STREET,

REMOVALS PLAN 2

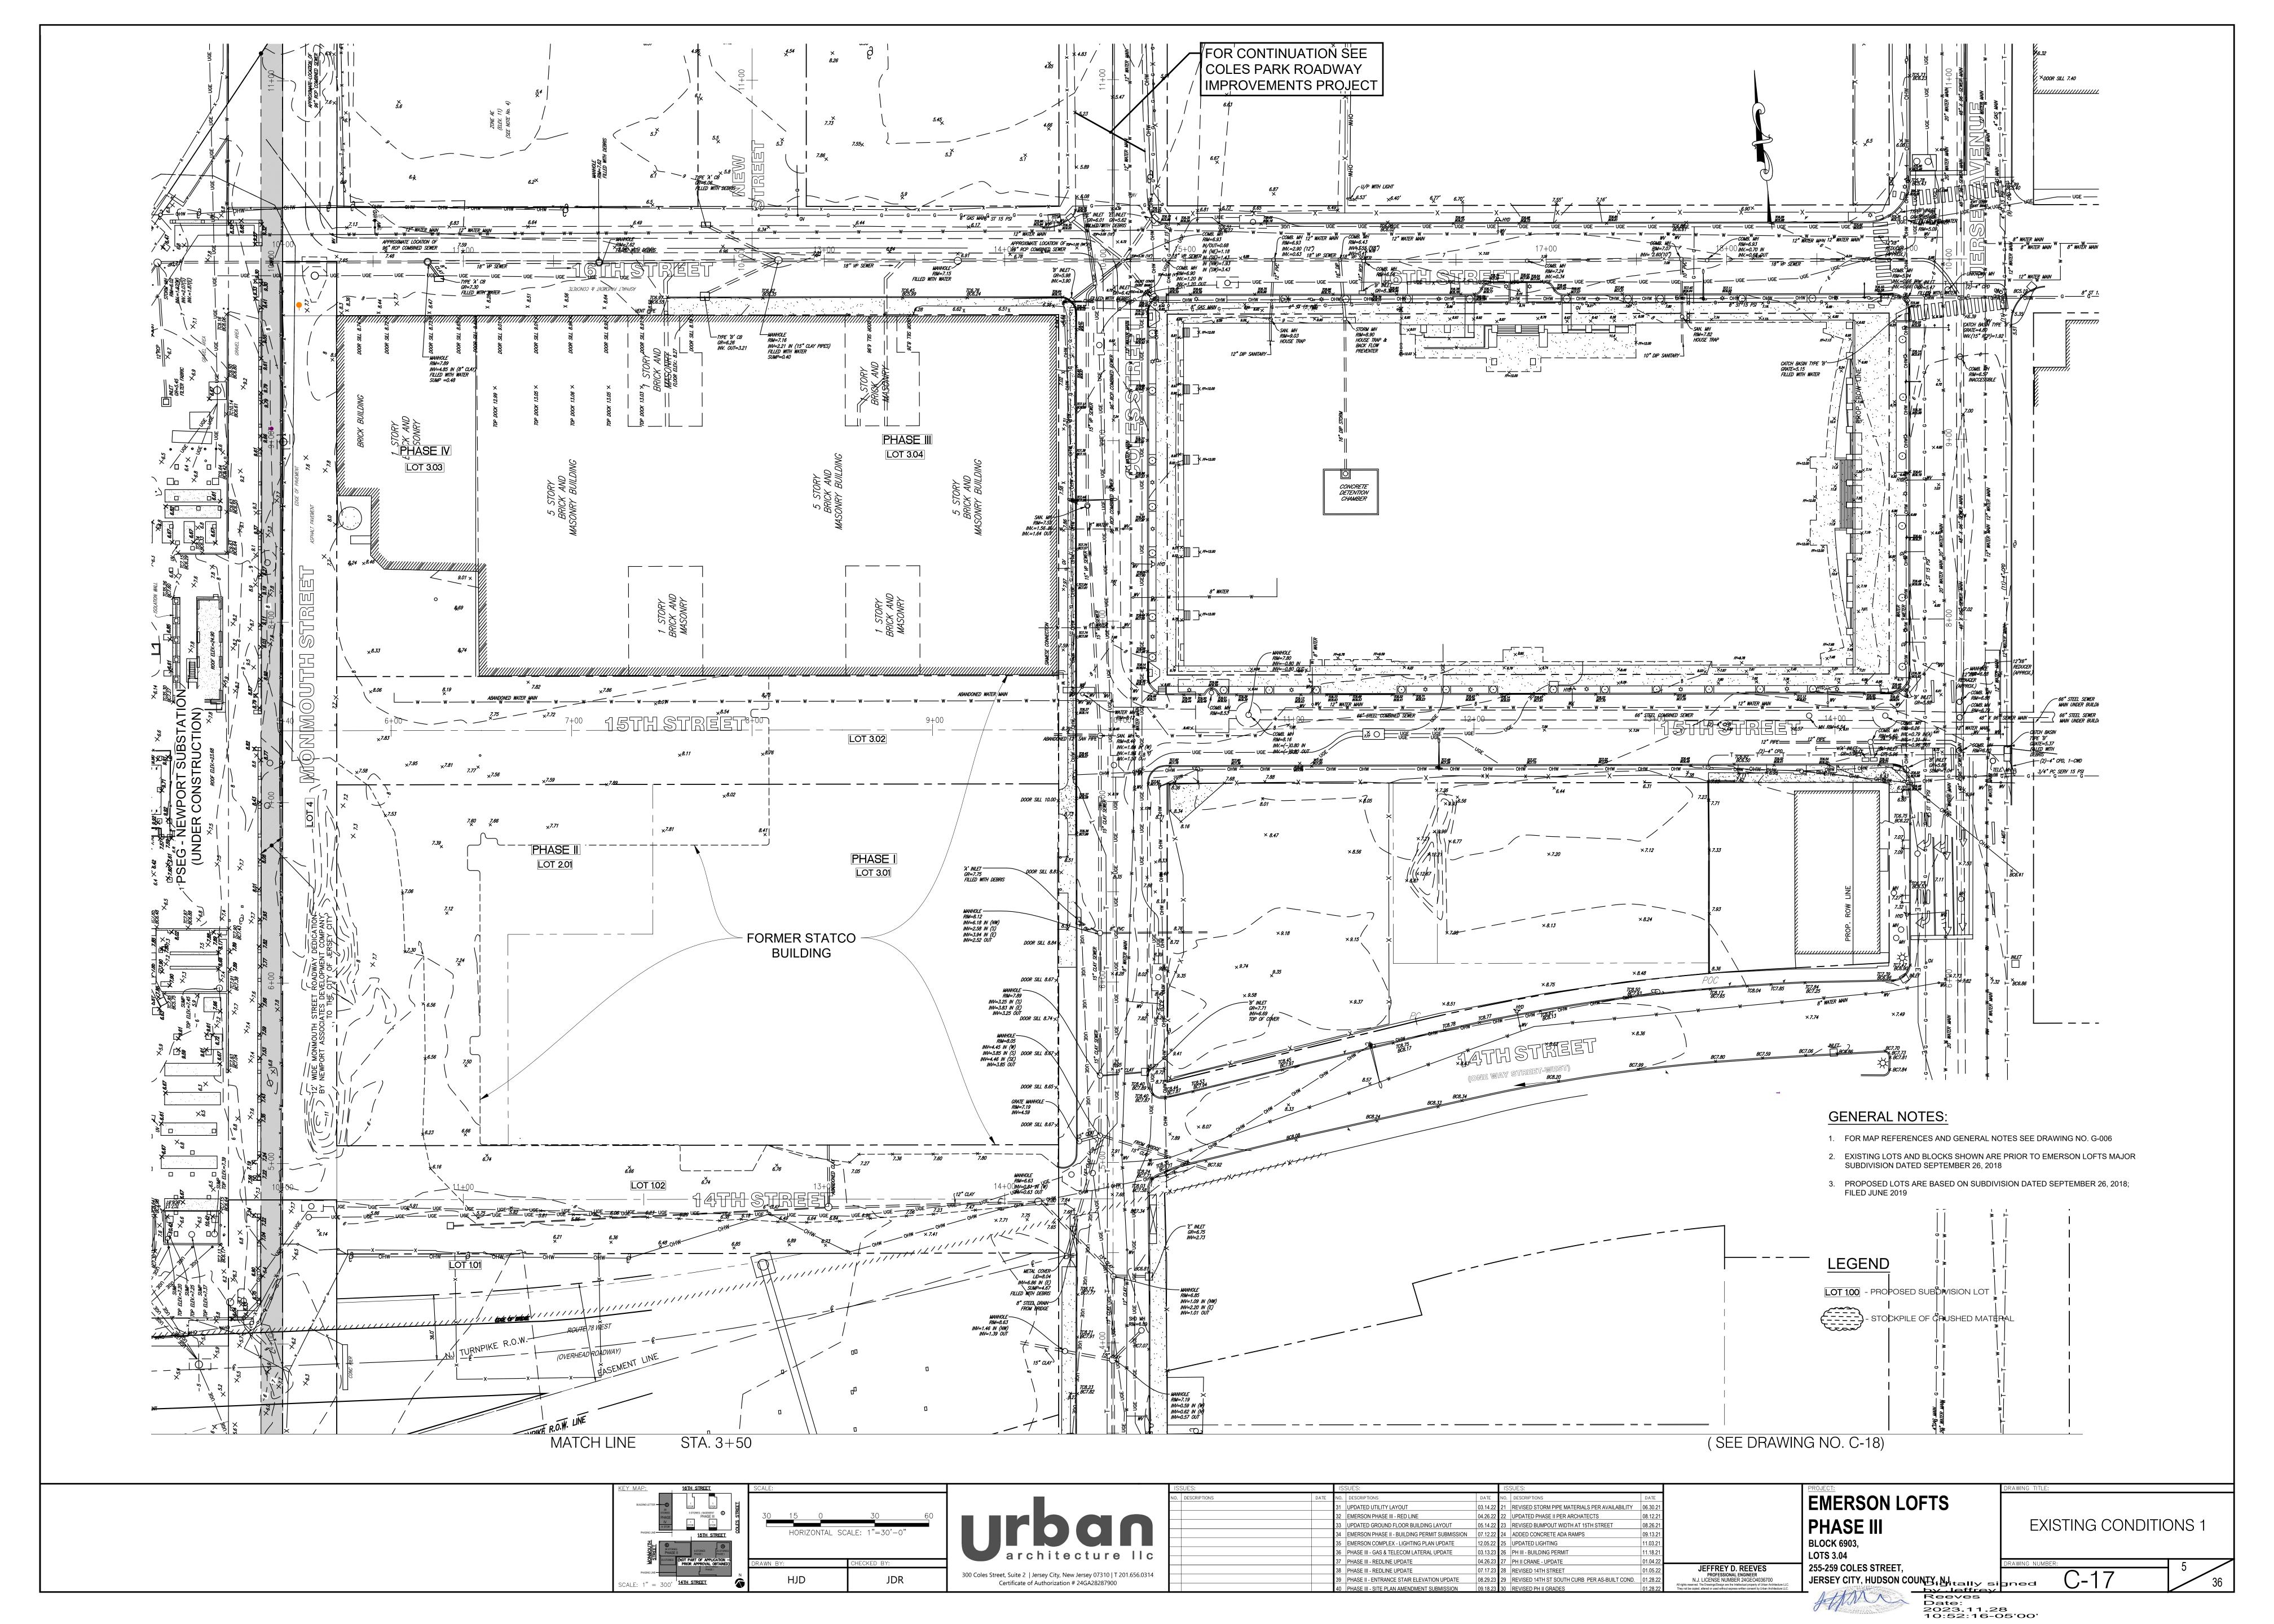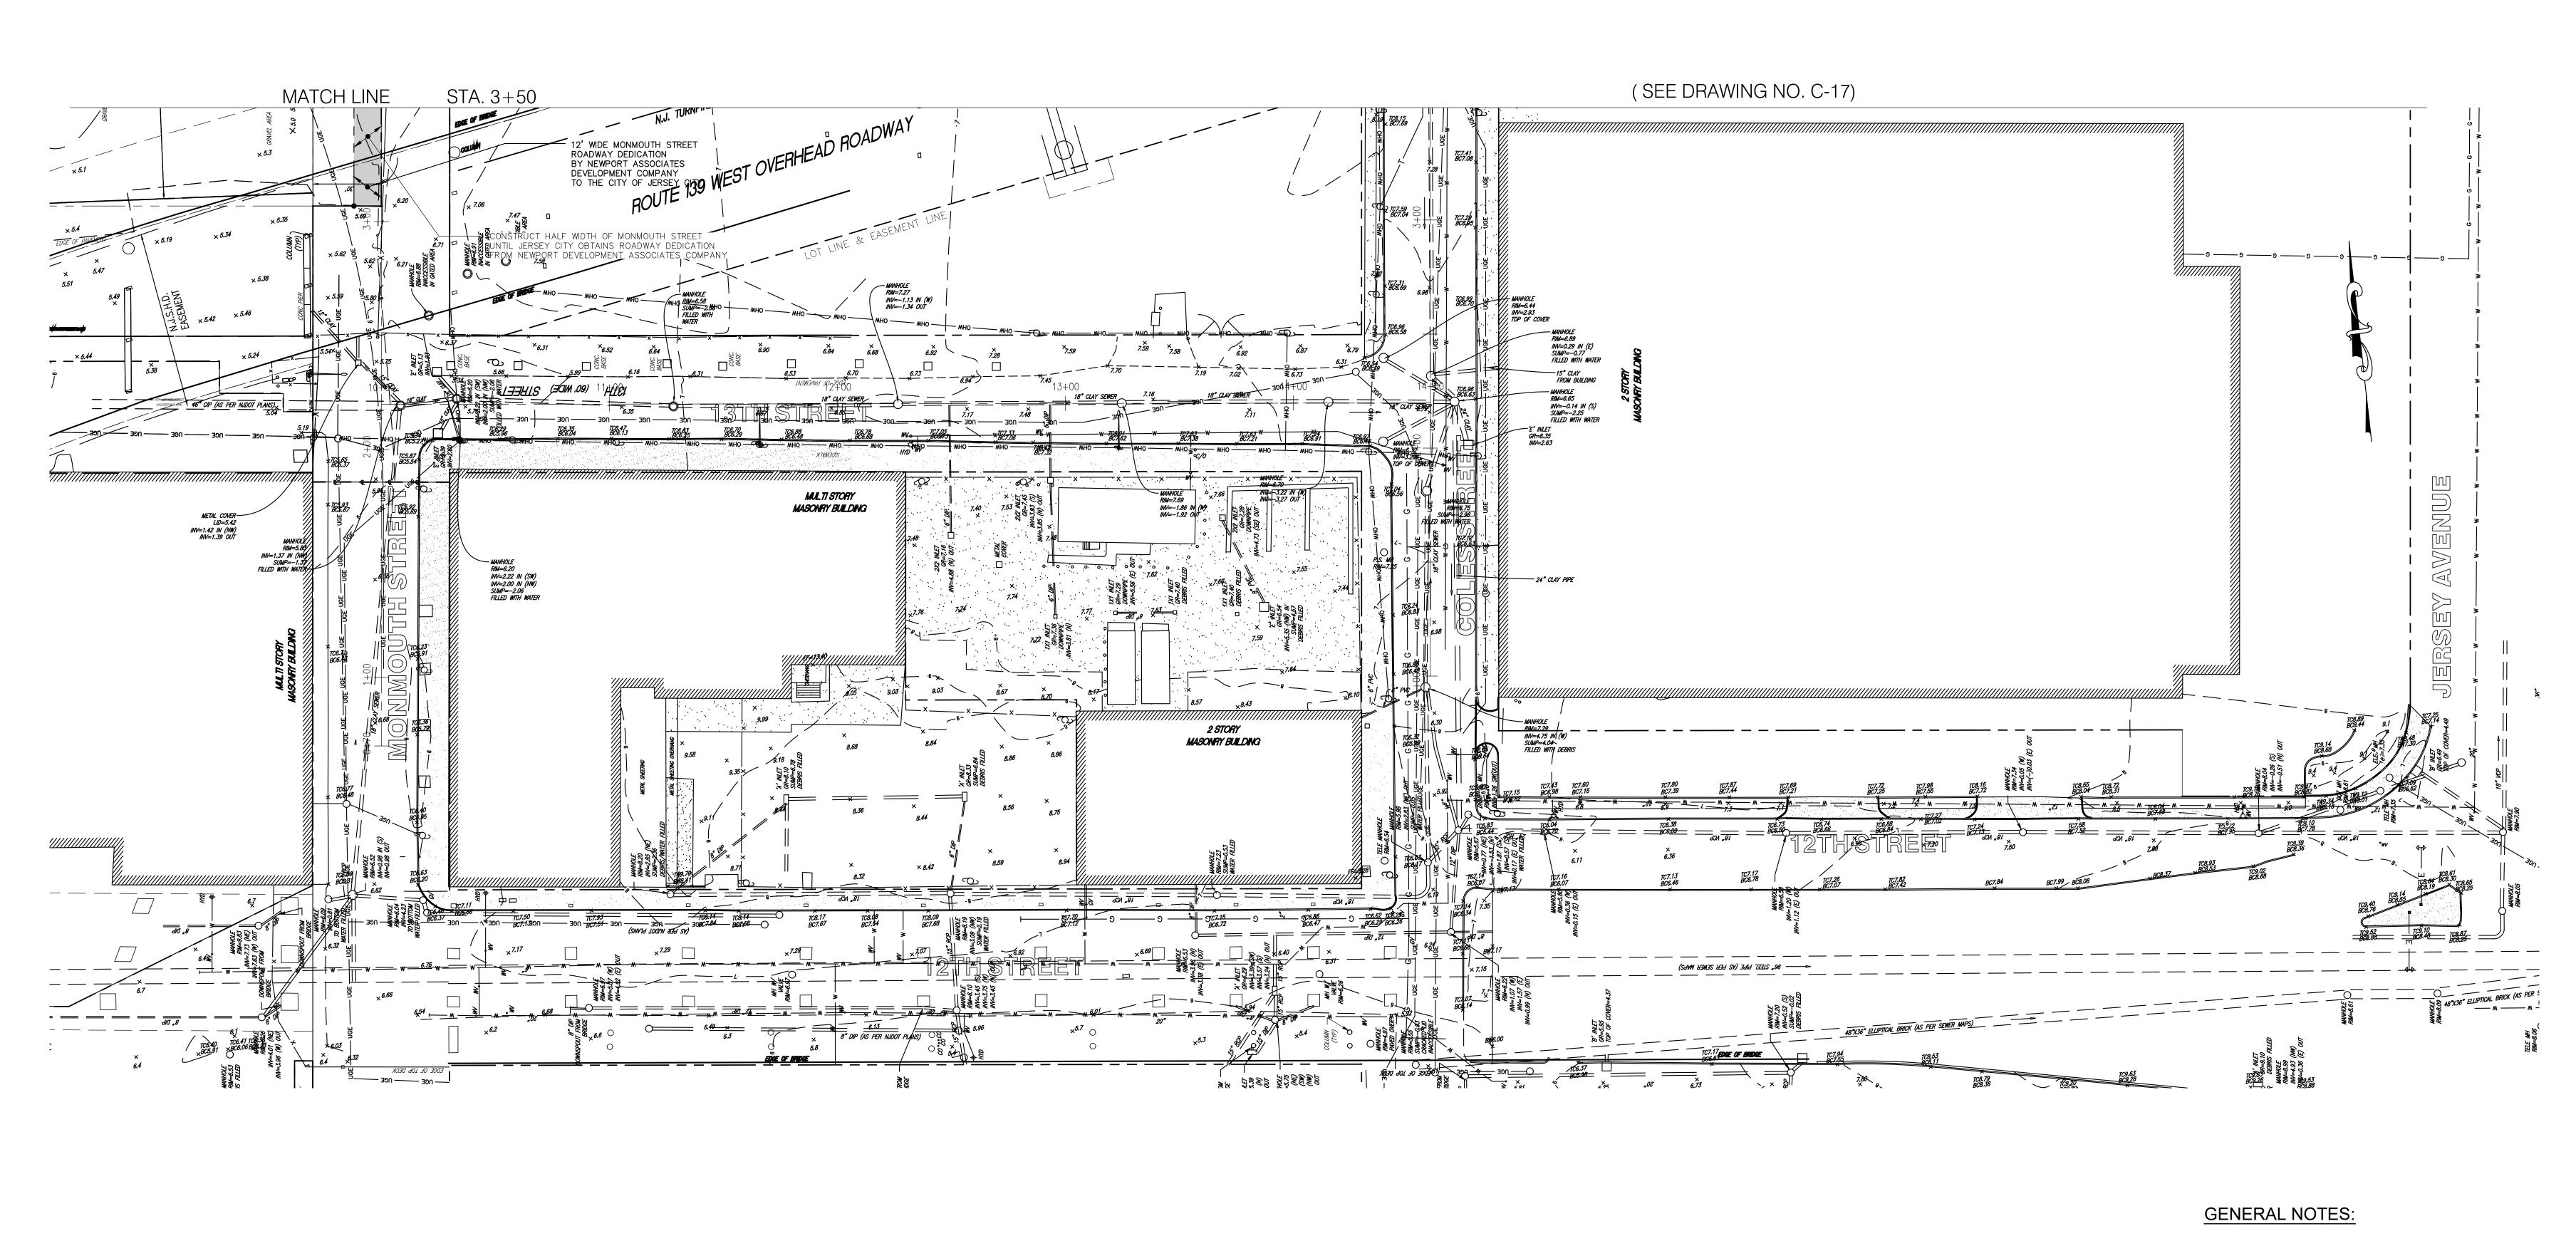JERSEY CITY, HUDSON COUNTY Mitally signed by Jeffrey
Reeves
Date:
2023.11.28
10:51:44-05'00'






- 1. FOR MAP REFERENCES AND GENERAL NOTES SEE DRAWING NO. G-006
- EXISTING LOTS AND BLOCKS SHOWN ARE PRIOR TO EMERSON LOFTS MAJOR SUBDIVISION DATED SEPTEMBER 26, 2018
- PROPOSED LOTS ARE BASED ON SUBDIVISION DATED SEPTEMBER 26, 2018;
 FILED JUNE 2019

LEGEND

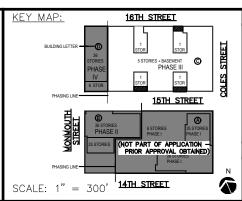LOT 1.00 - PROPOSED SUBDIVISION LOT





E:

D 15 0 30 60

HORIZONTAL SCALE: 1"=30'-0"

N BY: CHECKED BY:

HJD JDR




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		39	PHASE II - ENTRANCE STAIR ELEVATION UPDATE	08.29.23	29	REVISED 14TH ST SOUTH CURB PER AS-BUILT COND.	01.28.22	N.J. LIC
		40	DHASE III. SITE DI ANI AMENDMENT SURMISSIONI	00 18 23	30	DEVISED DHII CDADES	01 28 22	All rights reserved. The Dr


EMERSON LOFTS
PHASE III
BLOCK 6903,
LOTS 3.04
255-259 COLES STREET,
JERSEY CITY, HUDSON COUNTY, NJ.
JERSEY CITY, HUDSON COUNTY, NJ.


EXISTING CONDITIONS 2


255-259 COLES STREET,

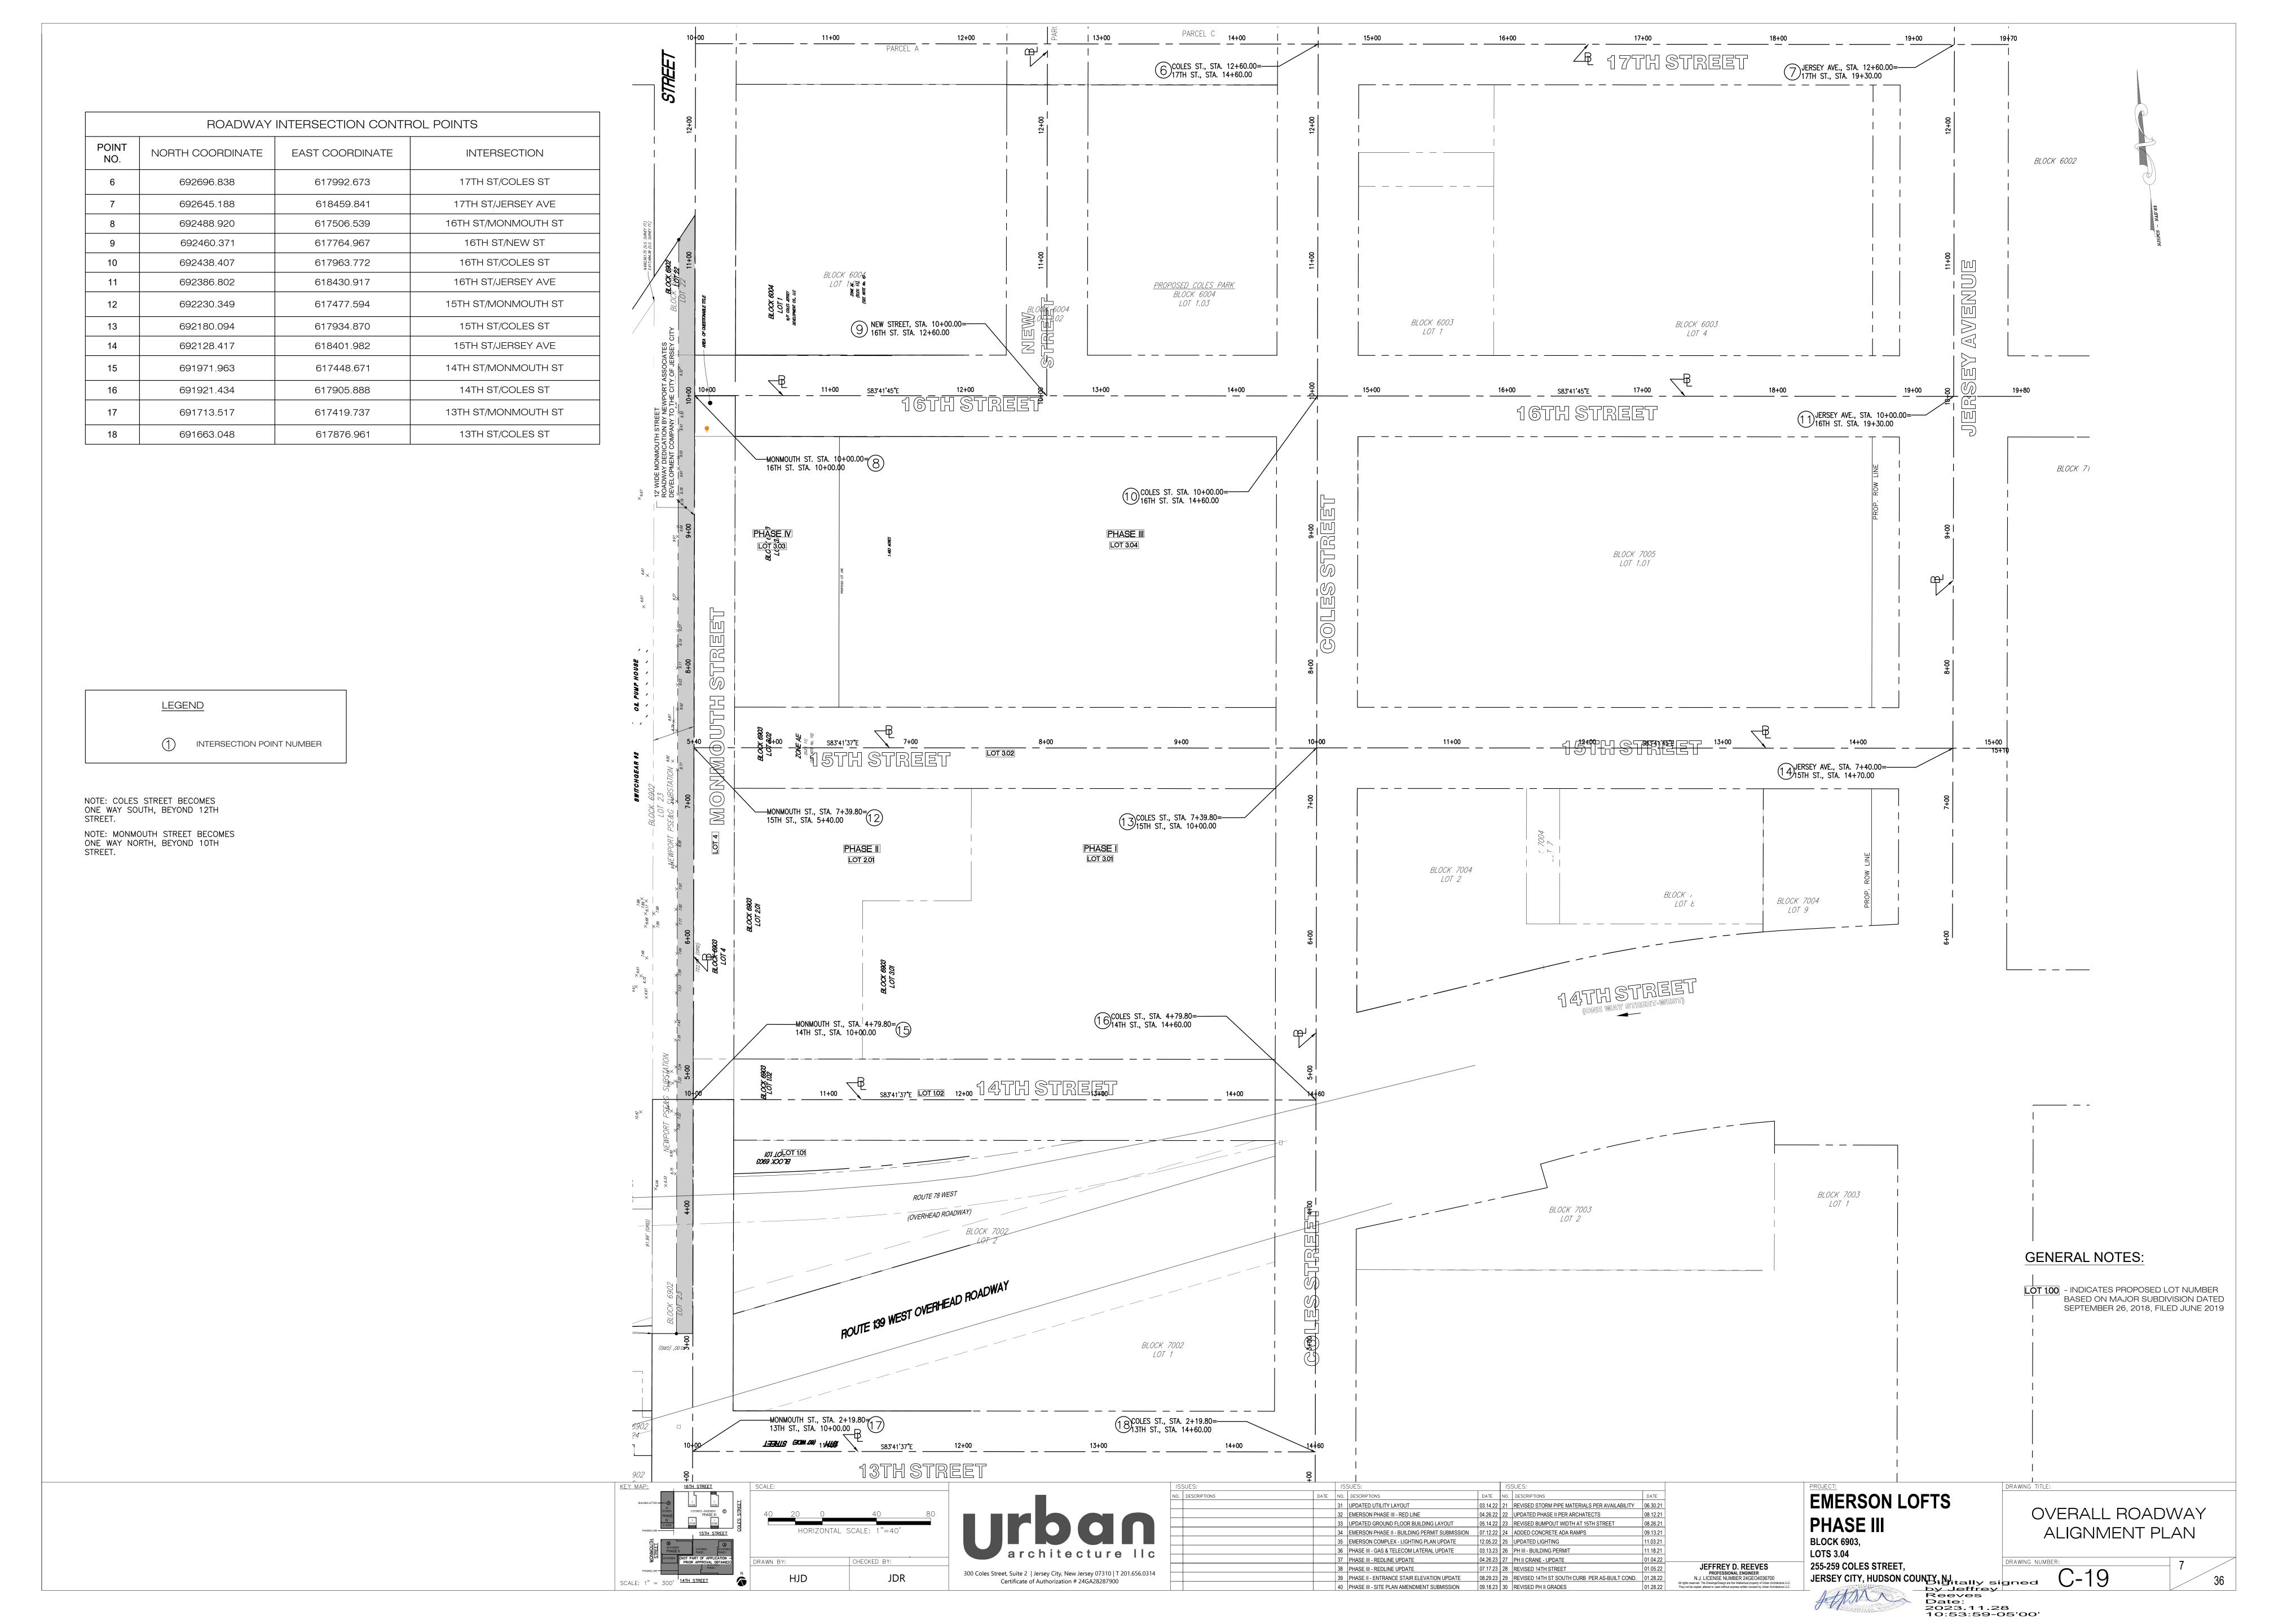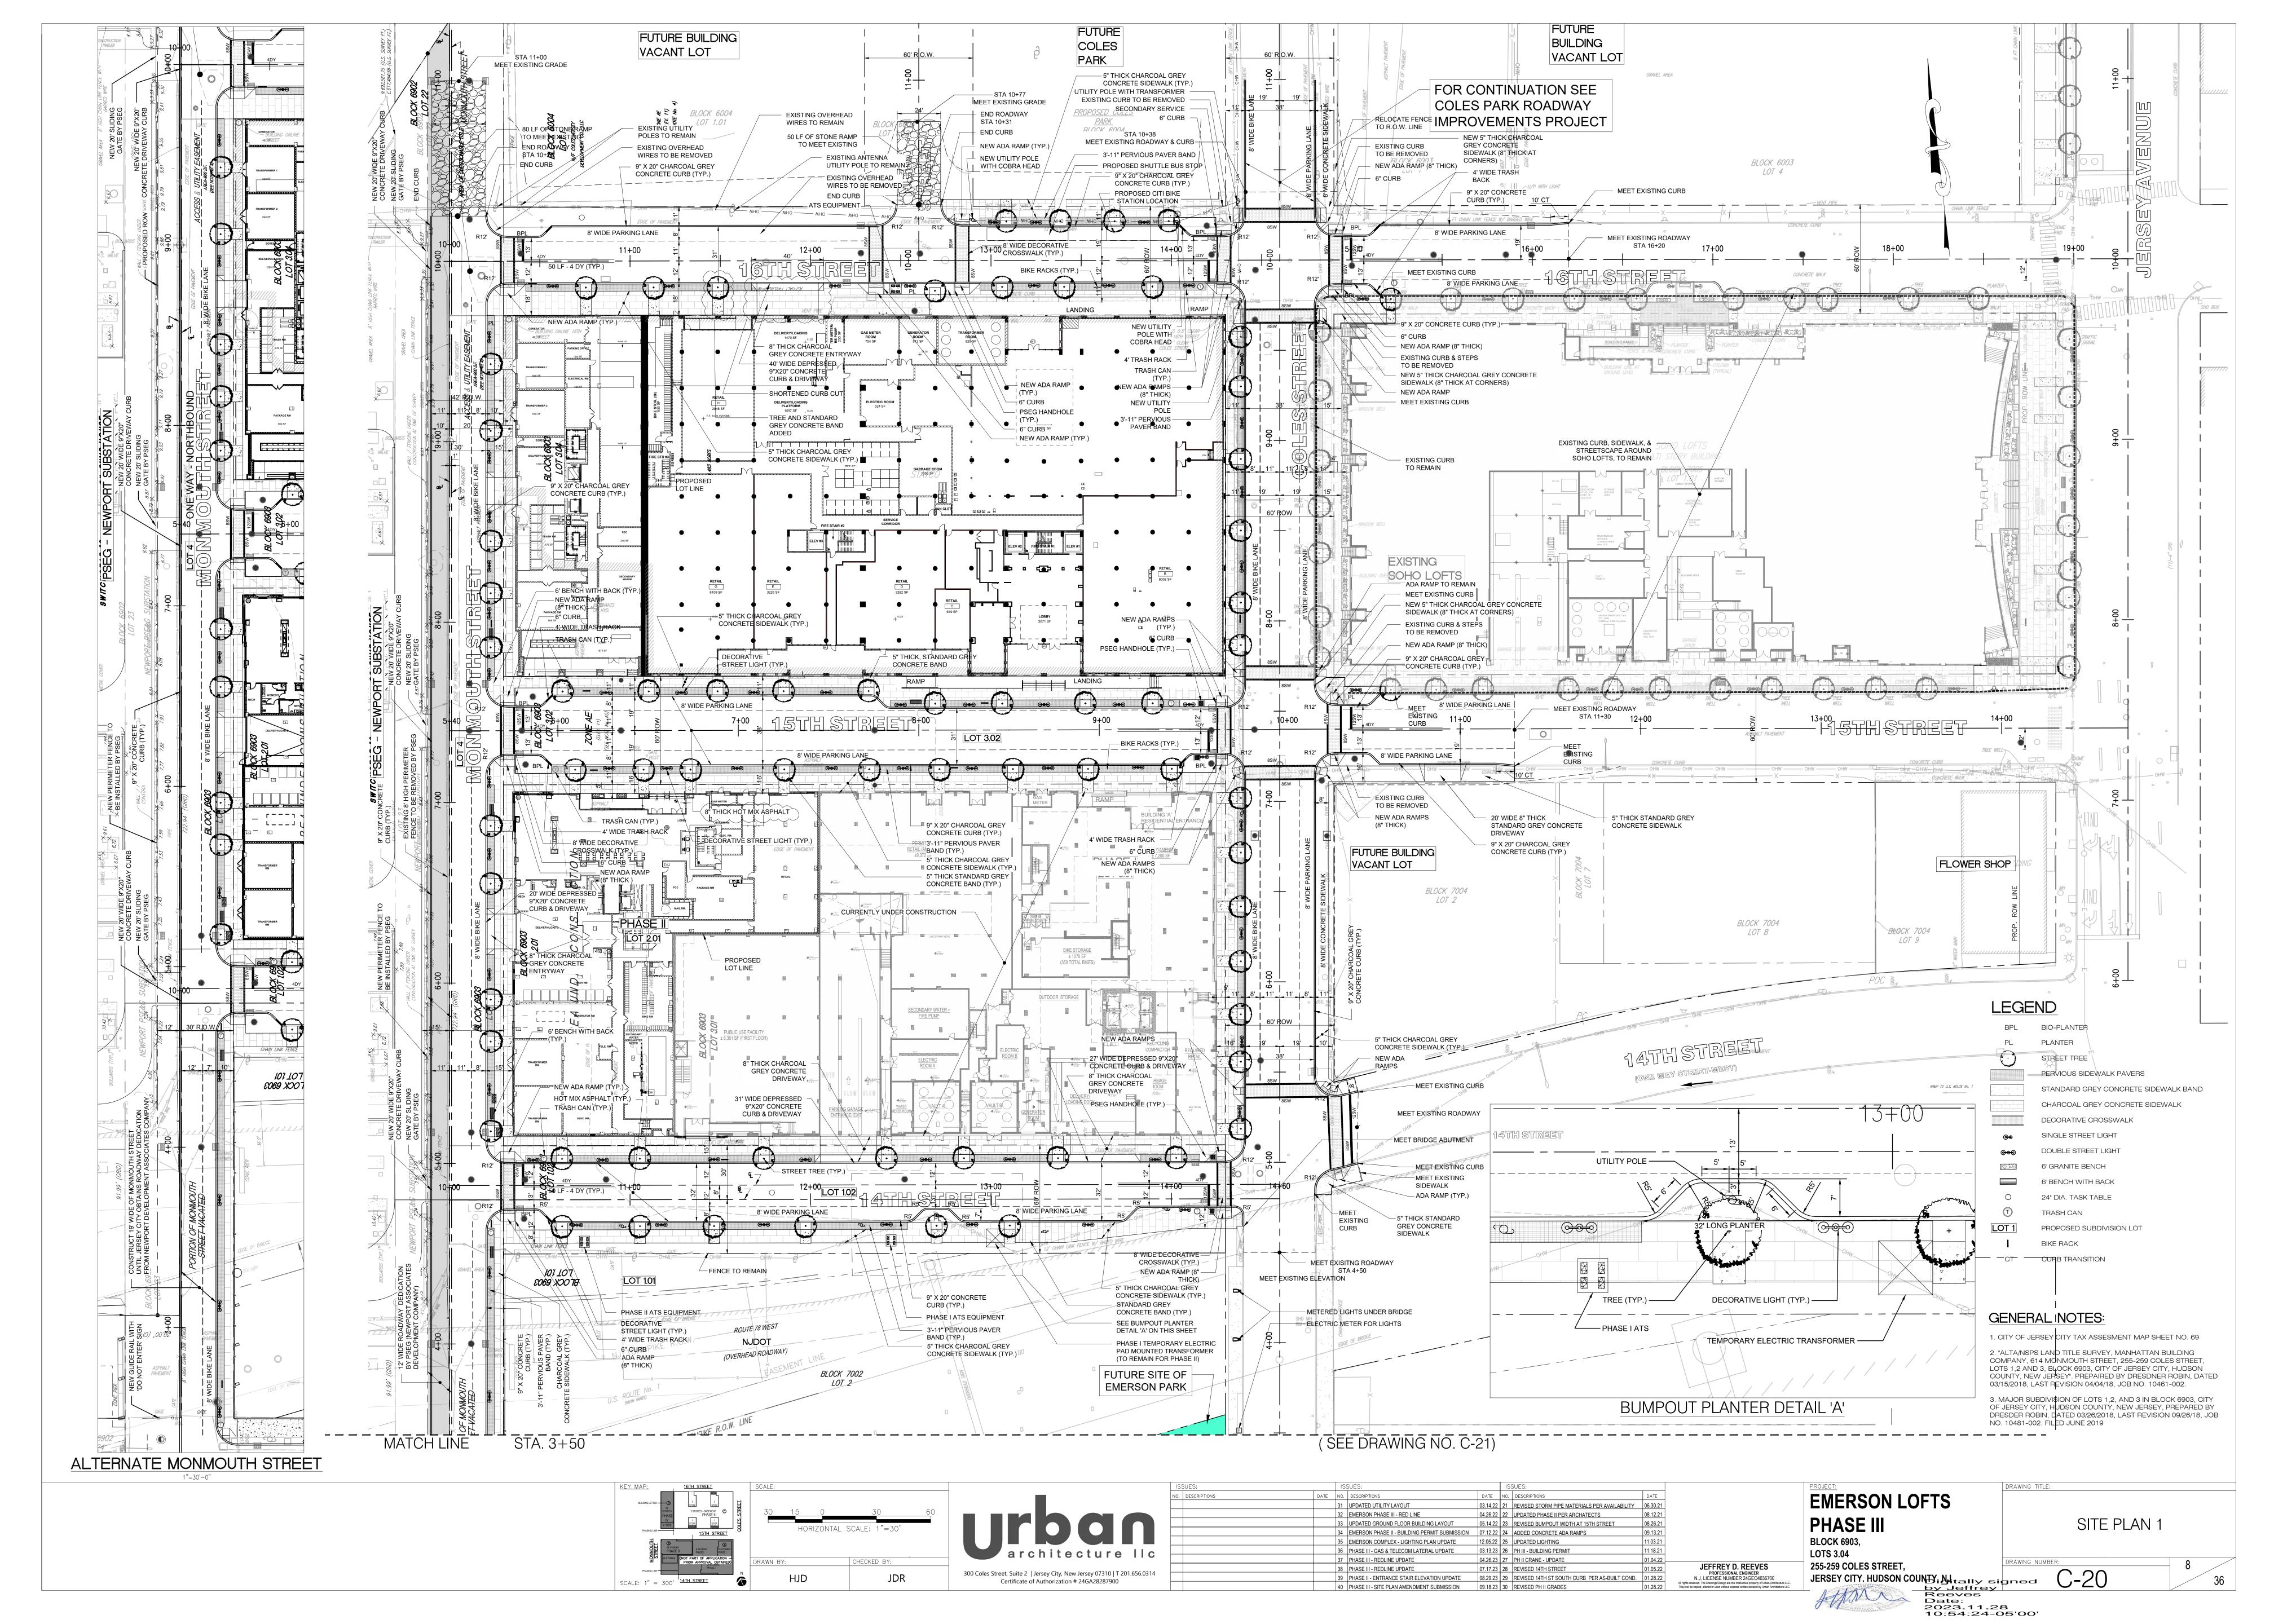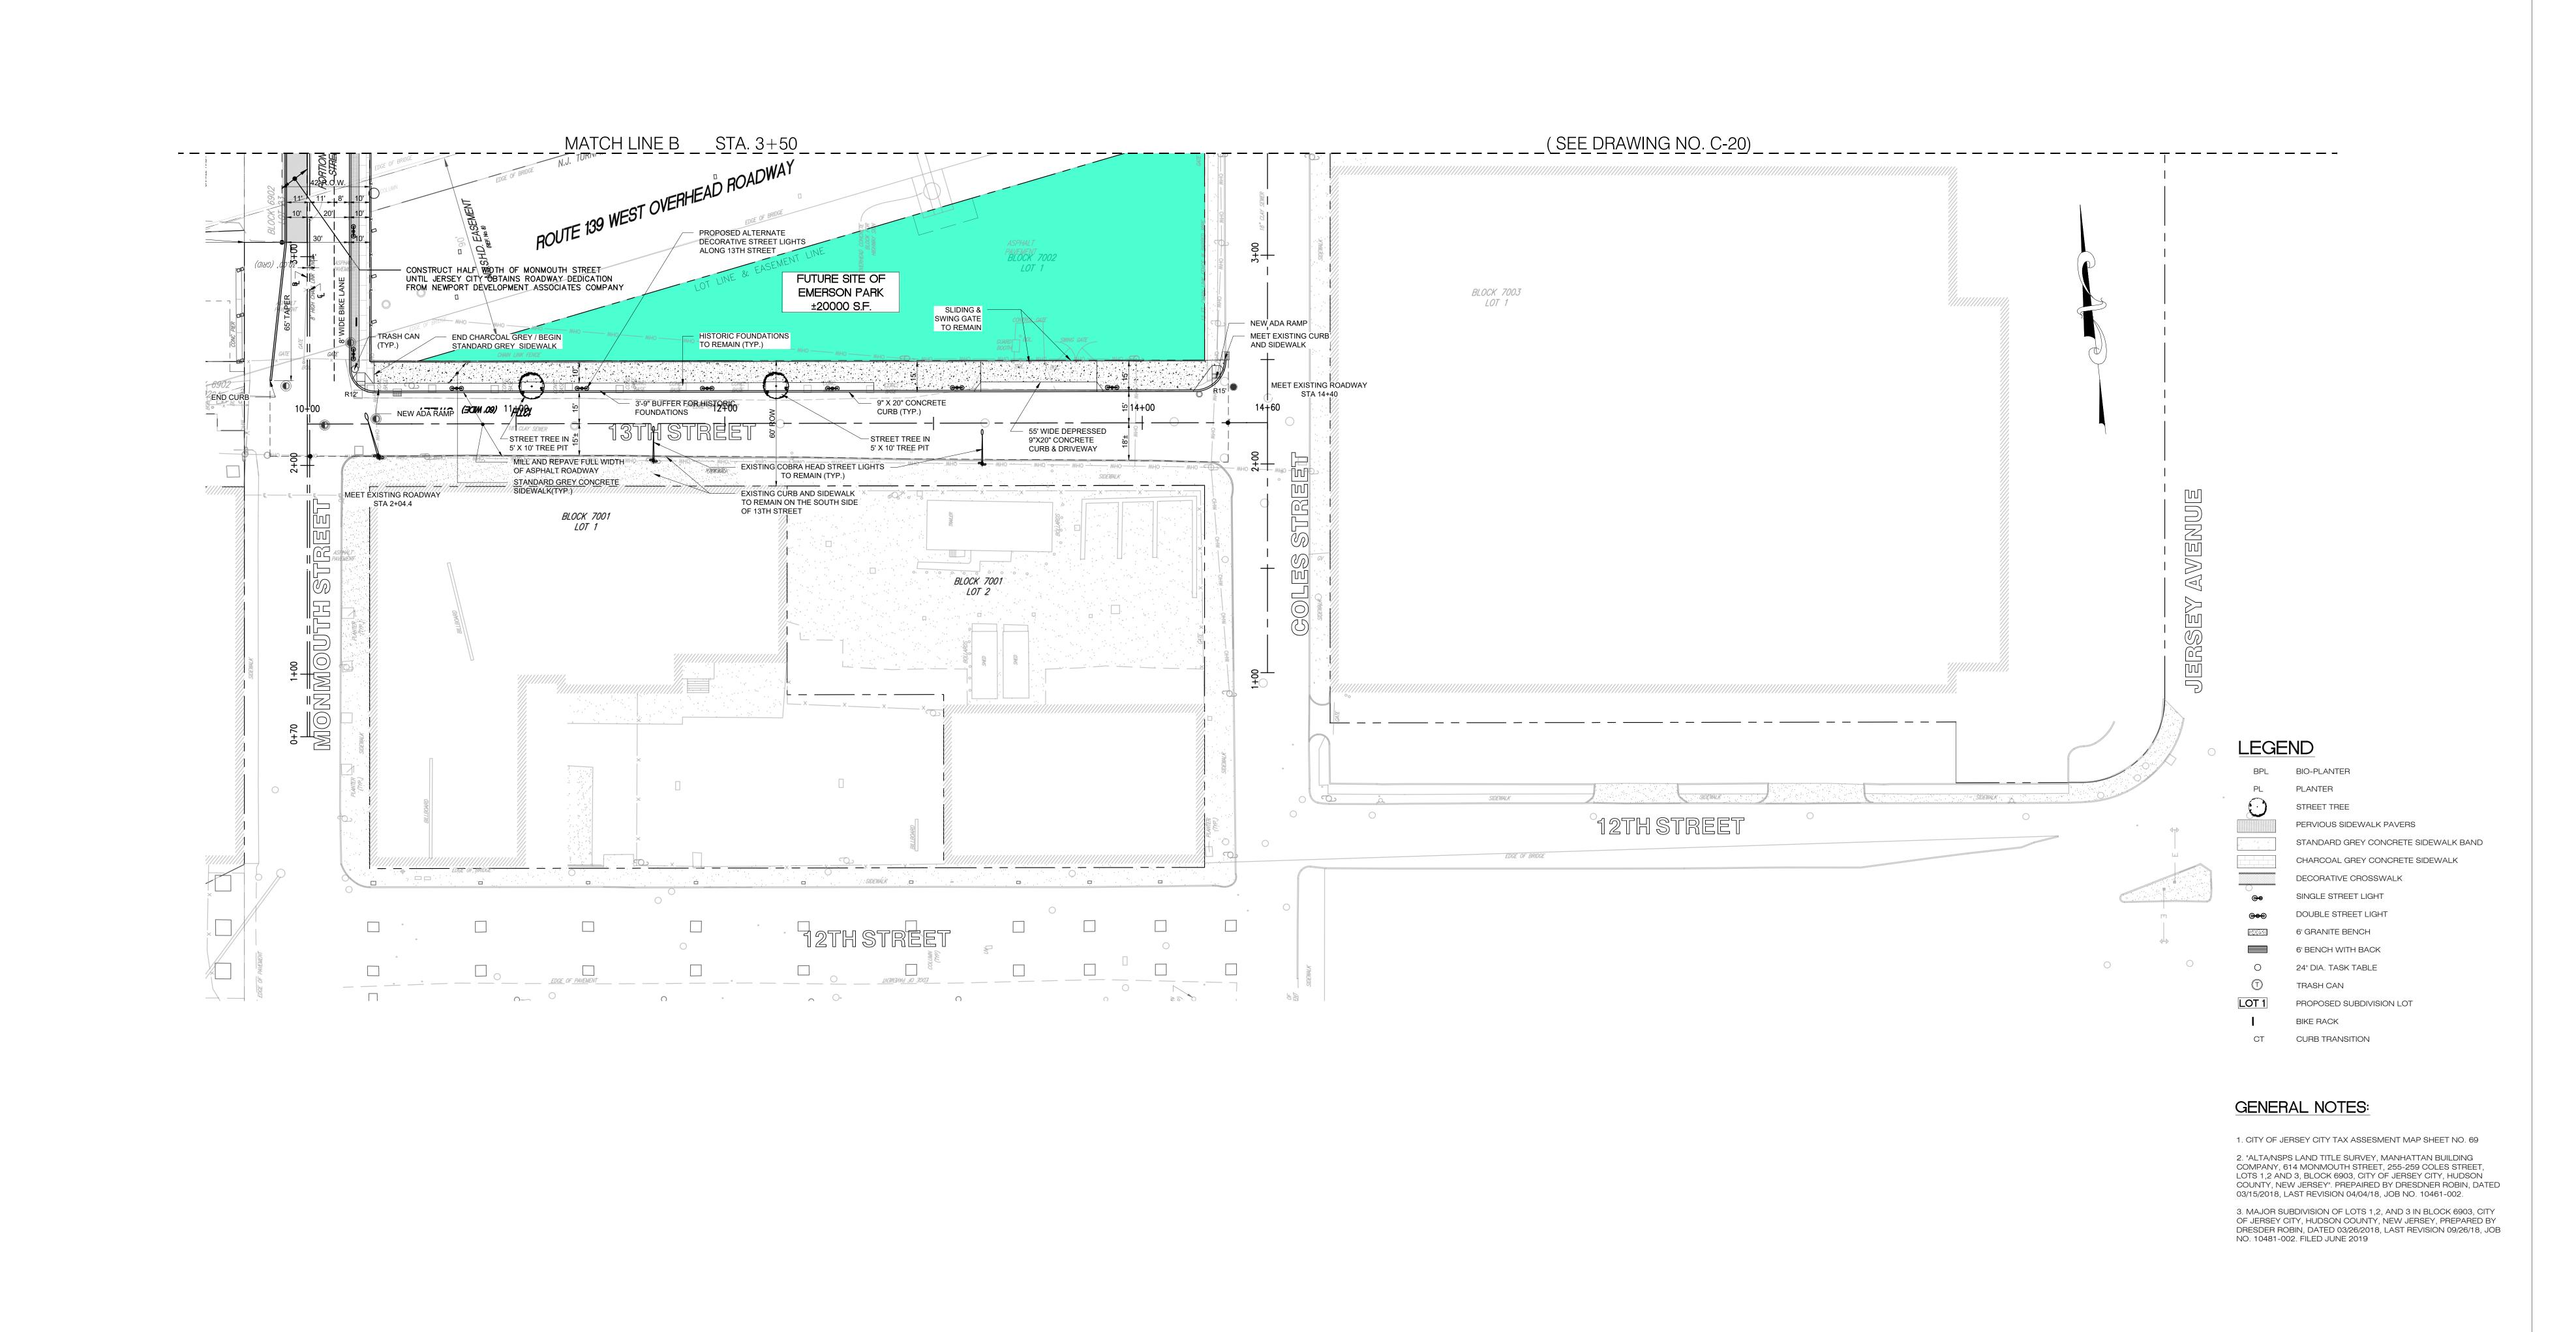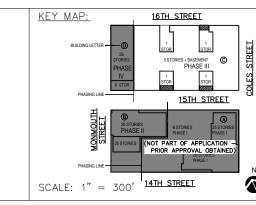JERSEY CITY, HUDSON COUNTY, Notice of the serves pate:
2023.11.28
10:53:02-05'00'









HORIZONTAL SCALE: 1"=30"

BY: CHECKED BY:

HJD JDR



NO.	DESCRIPTIONS	DATE	NO.	DESCRIPTIONS	DATE	NO.	DESCRIPTIONS	DATE	
			31	UPDATED UTILITY LAYOUT	03.14.22	21	REVISED STORM PIPE MATERIALS PER AVAILABILITY	06.30.21	
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			40	PHASE III - SITE PLAN AMENDMENT SUBMISSION	09.18.23	30	REVISED PH II GRADES	01.28.22	

ISSUES:

EMERSON LOFTS

PHASE III

BLOCK 6903,
LOTS 3.04

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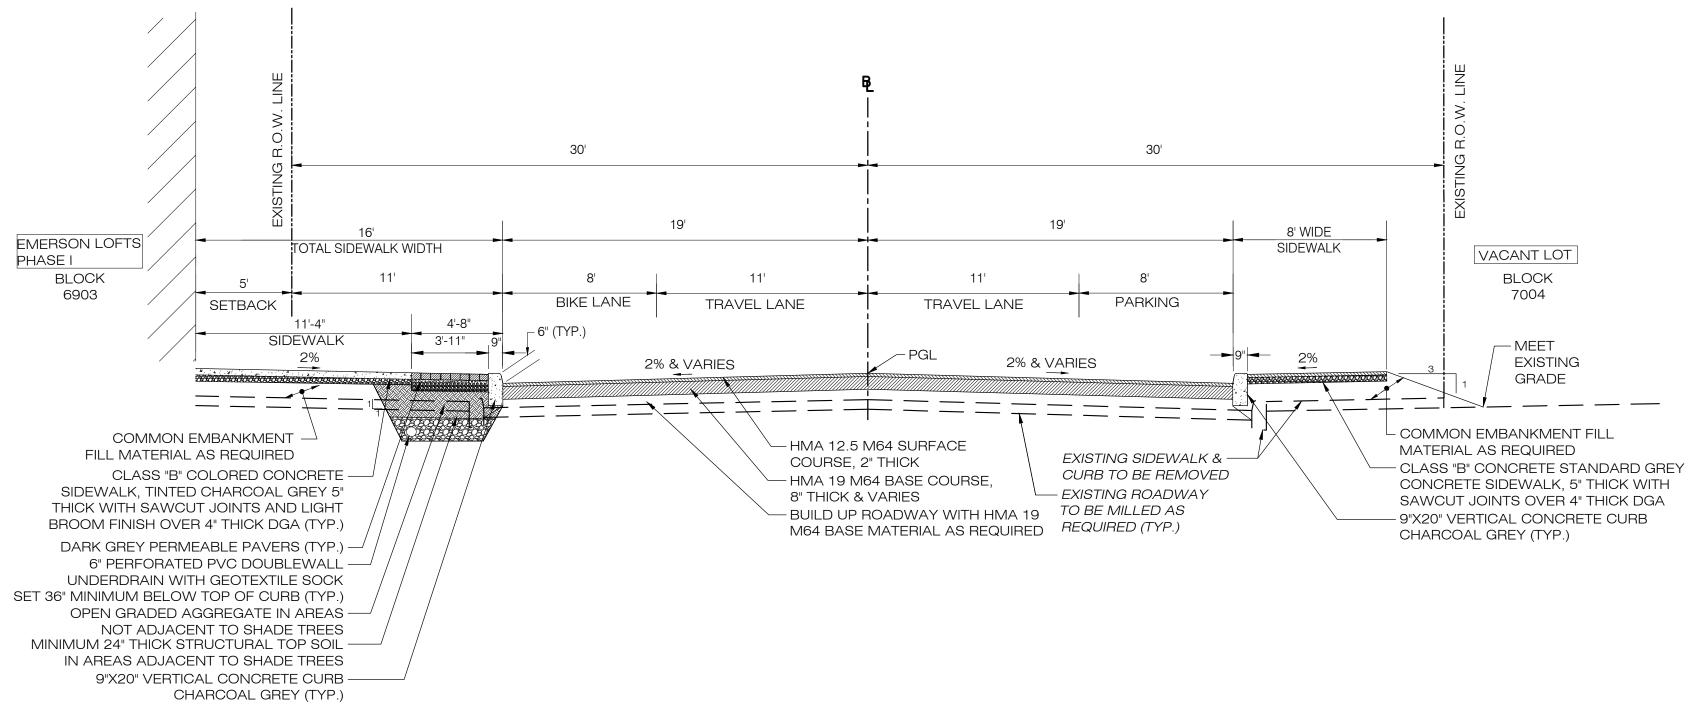
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SITE PLAN 2

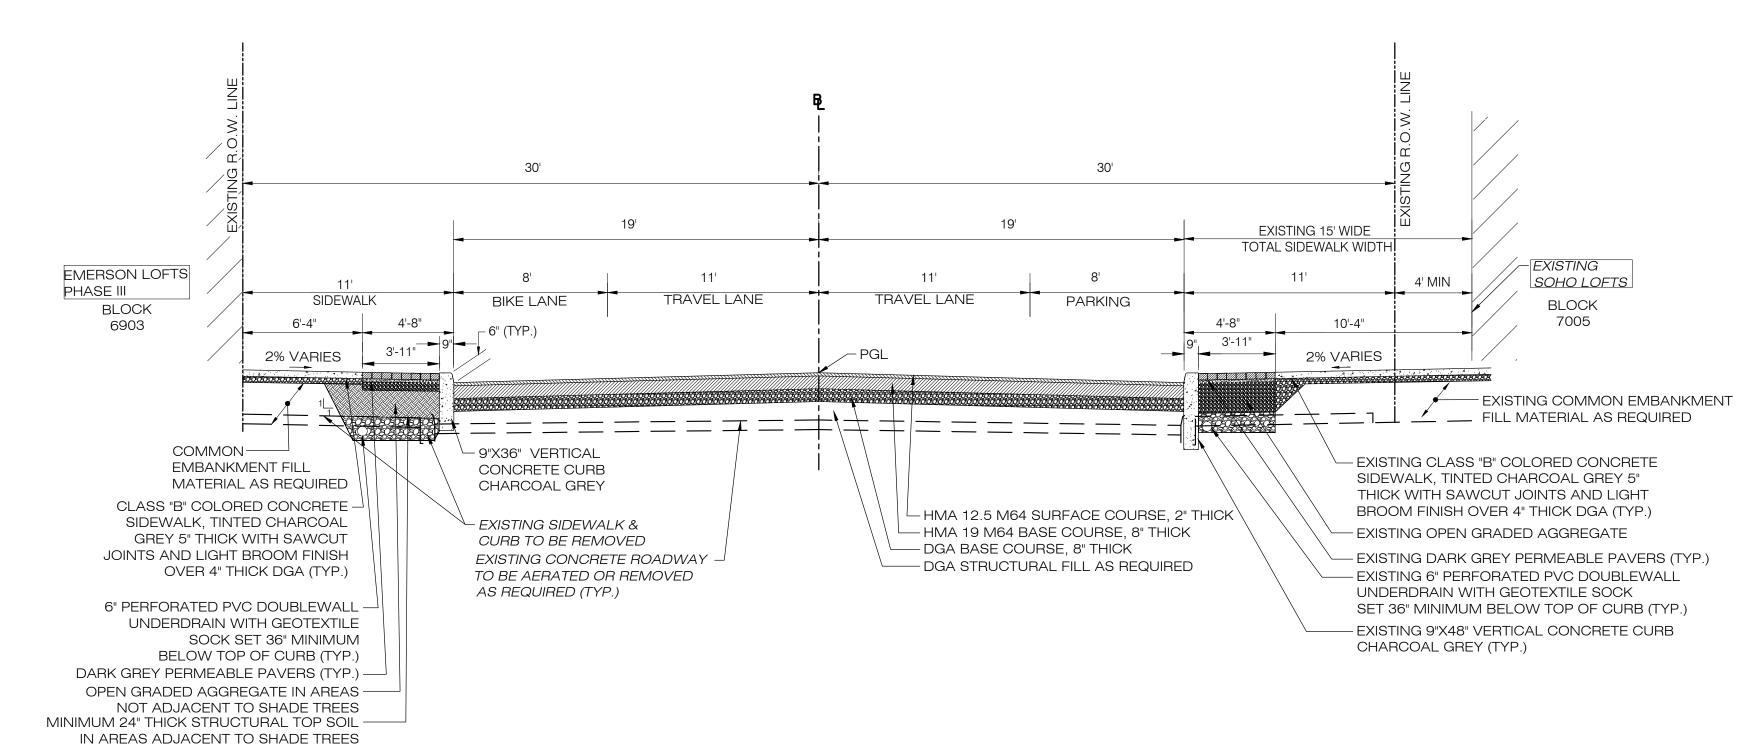
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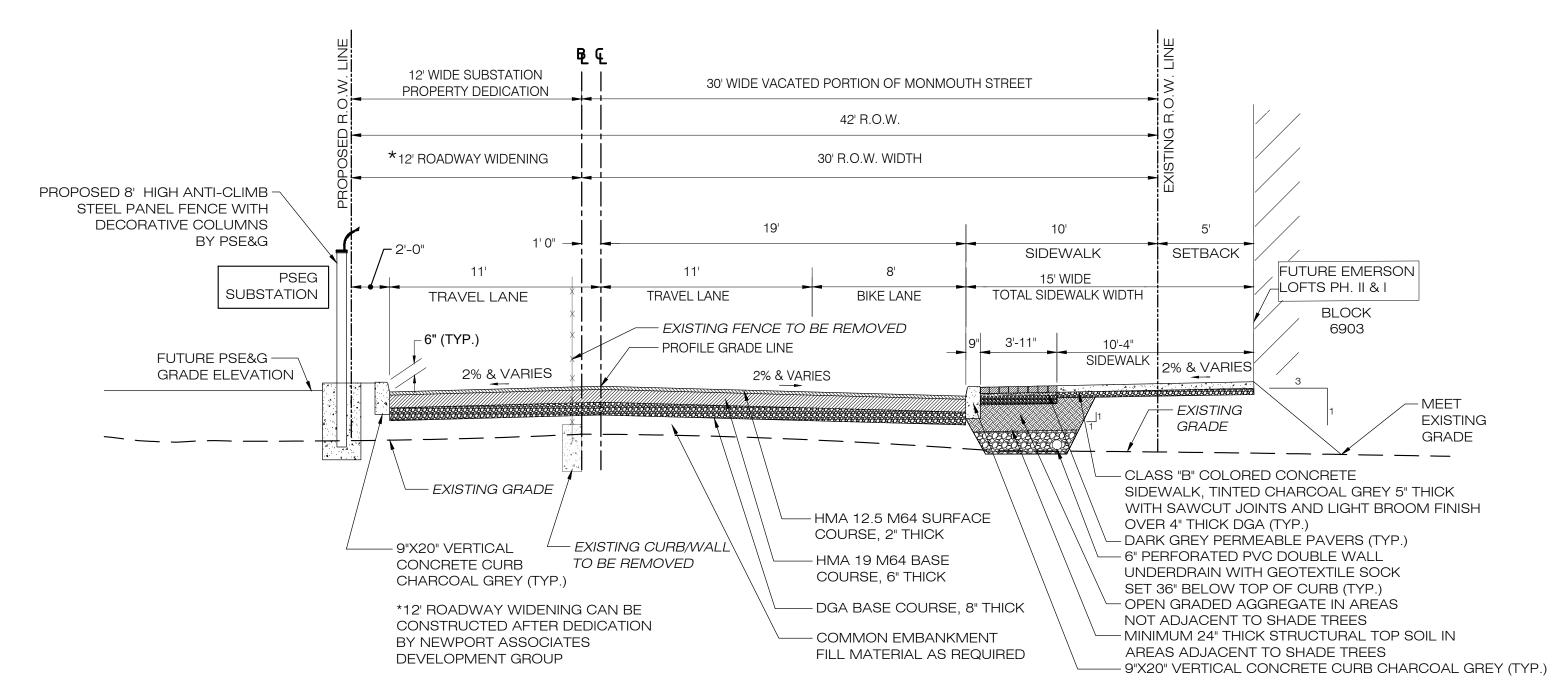
MBER: C-21



COLES STREET TYPICAL ROADWAY SECTION STA 4+50 TO STA 7+40

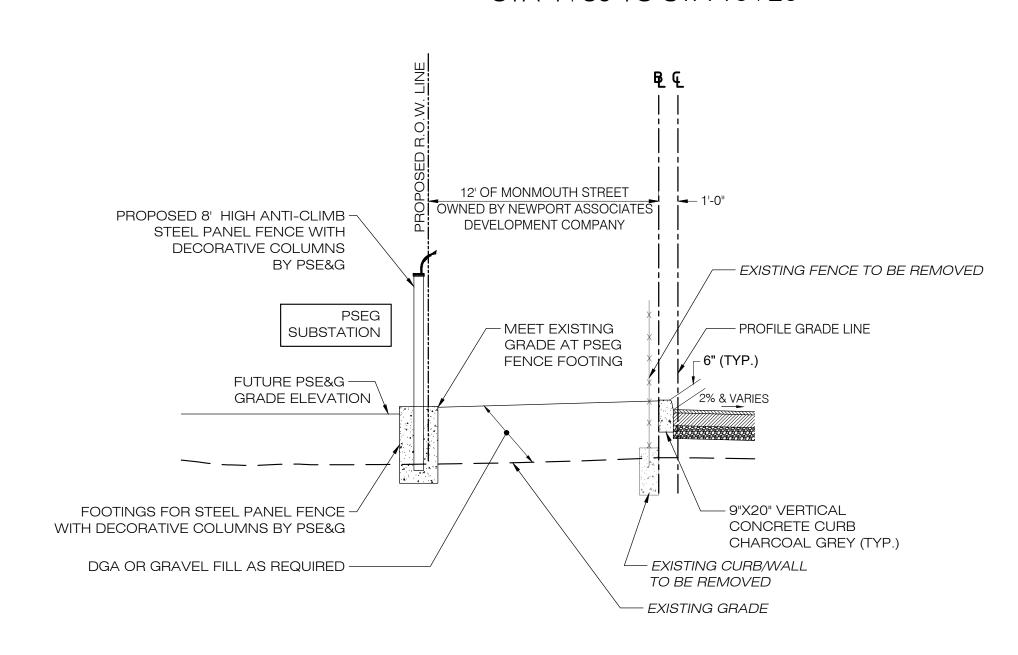


COLES STREET TYPICAL ROADWAY SECTION
STA 7+40 TO STA 10+00




MONMOUTH STREET TYPICAL ROADWAY SECTION

STA 4+80 TO STA 10+20



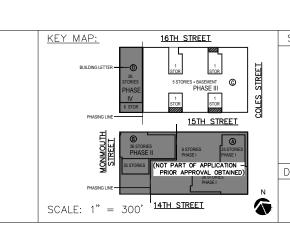*MONMOUTH STREET ALTERNATE ROADWAY HALF-SECTION STA 4+80 TO STA 10+20




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CHECKED BY:

JDR




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NO.	DESCRIPTIONS	DATE	NO.	DESCRIPTIONS	DATE	NO.	DESCRIPTIONS	DATE	
			31	UPDATED UTILITY LAYOUT	03.14.22	21	REVISED STORM PIPE MATERIALS PER AVAILABILITY	06.30.21	
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			40	PHASE III - SITE PLAN AMENDMENT SUBMISSION	09.18.23	30	REVISED PH II GRADES	01.28.22	All rights reserved. The Drawings/Design are the Intellectual property of Urban Archite They not be copied, altered or used without express written consent by Urban Archite

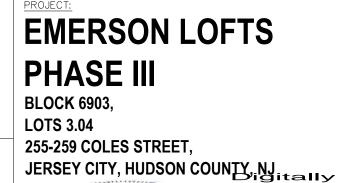


TYPICAL ROADWAY
SECTIONS 1

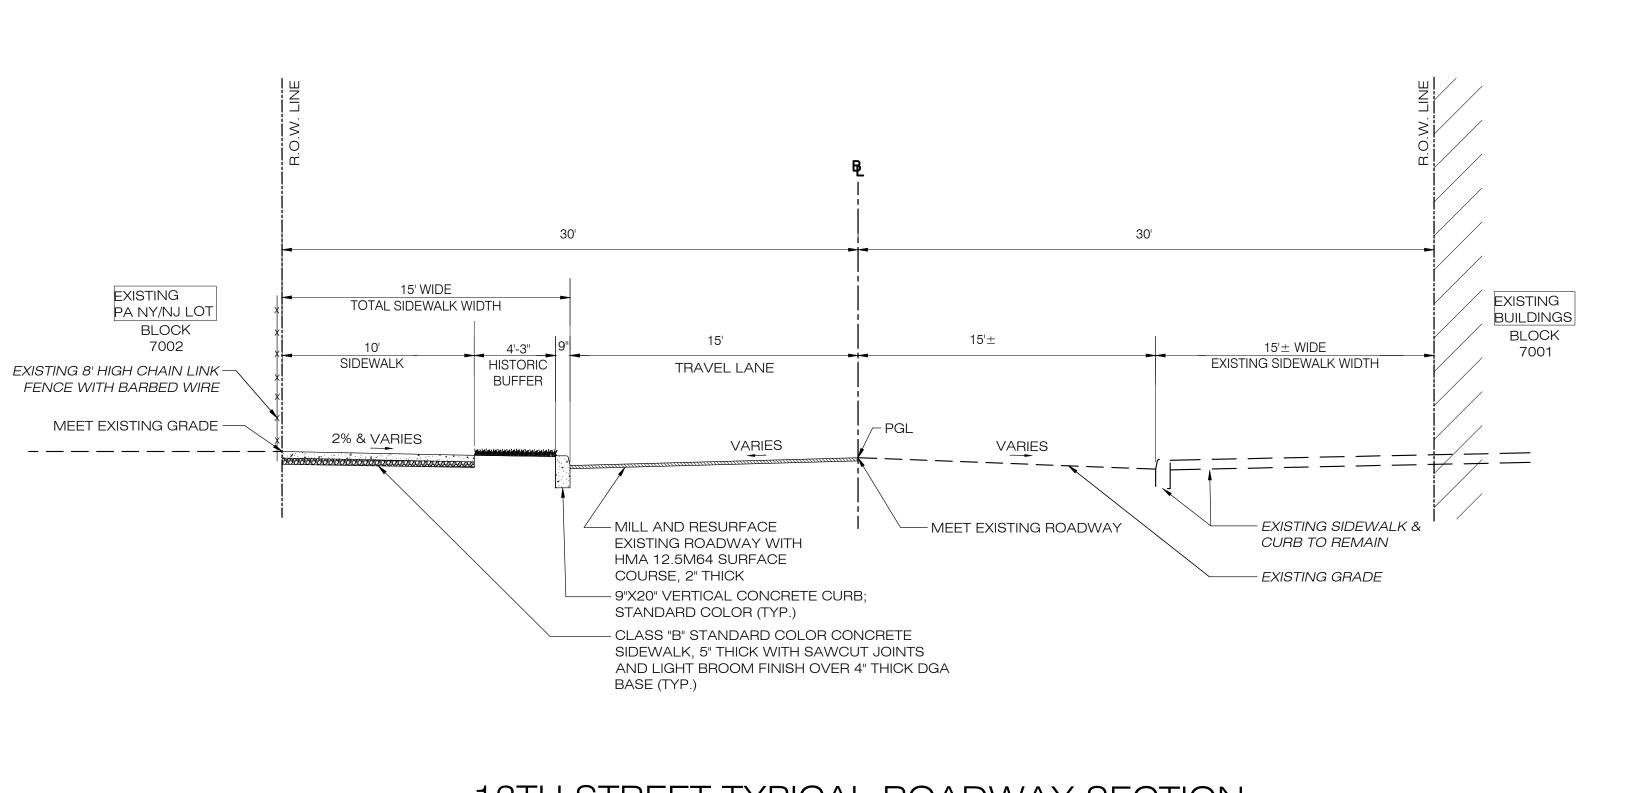
CITY, HUDSON COUNTY NJ Digitally signed by Jeffrey Reeves Date: 2023.11.28 10:55:57-05'00'



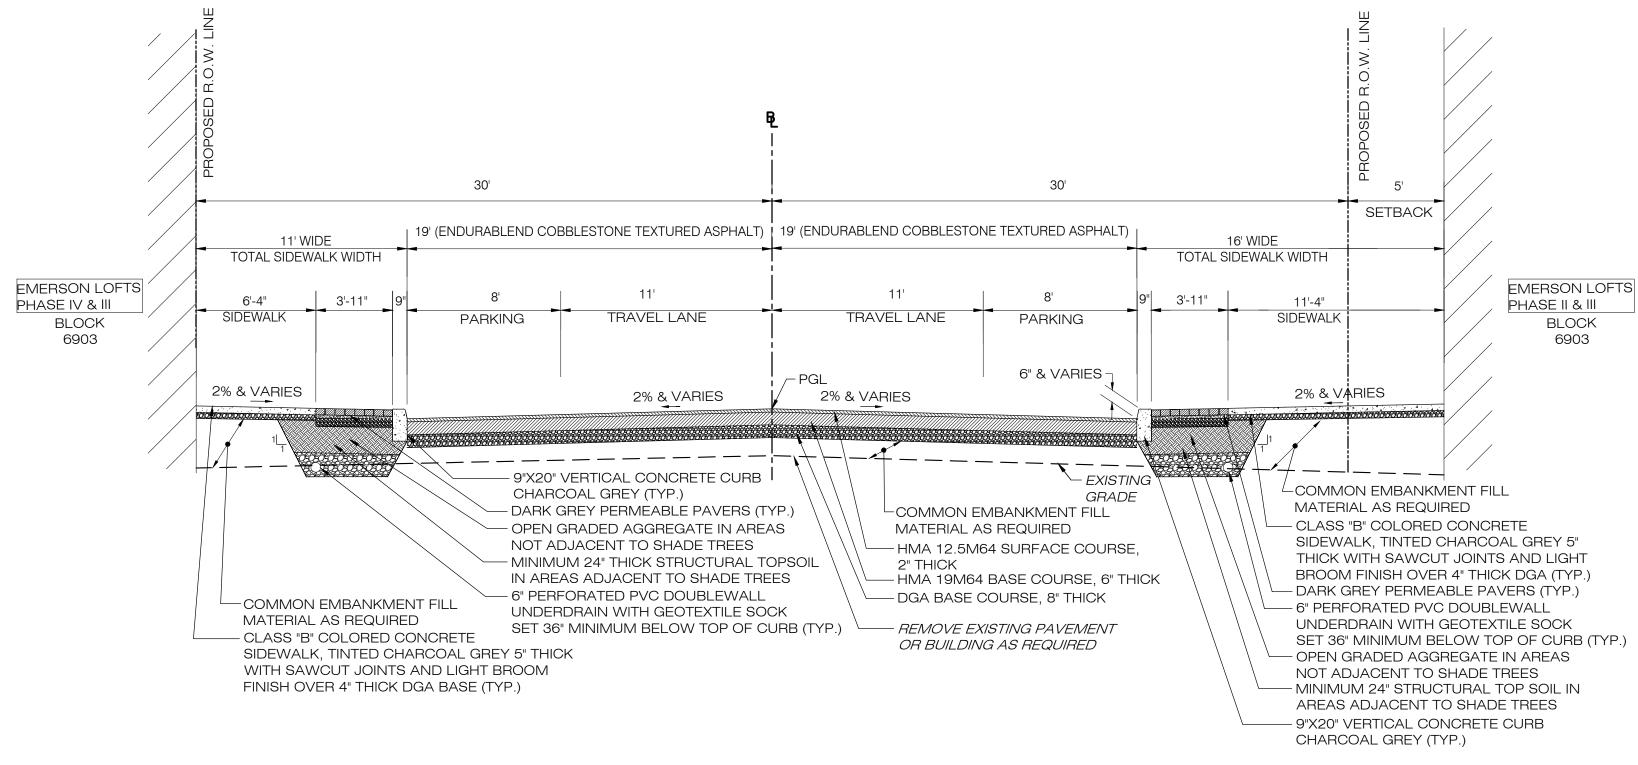
13TH STREET TYPICAL ROADWAY SECTION STA 10+00 TO STA 14+30




15TH STREET TYPICAL ROADWAY SECTION

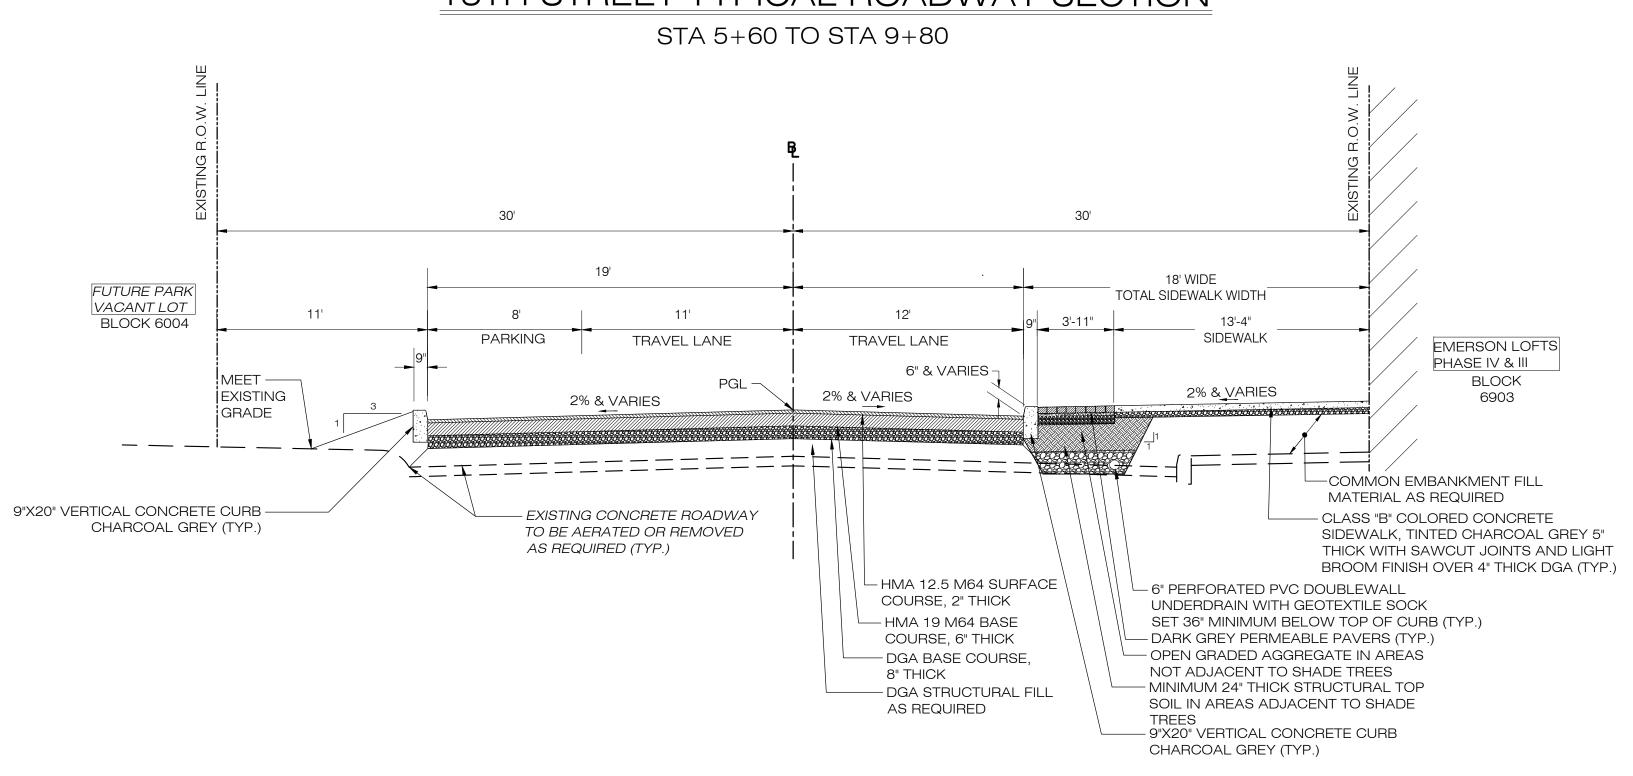

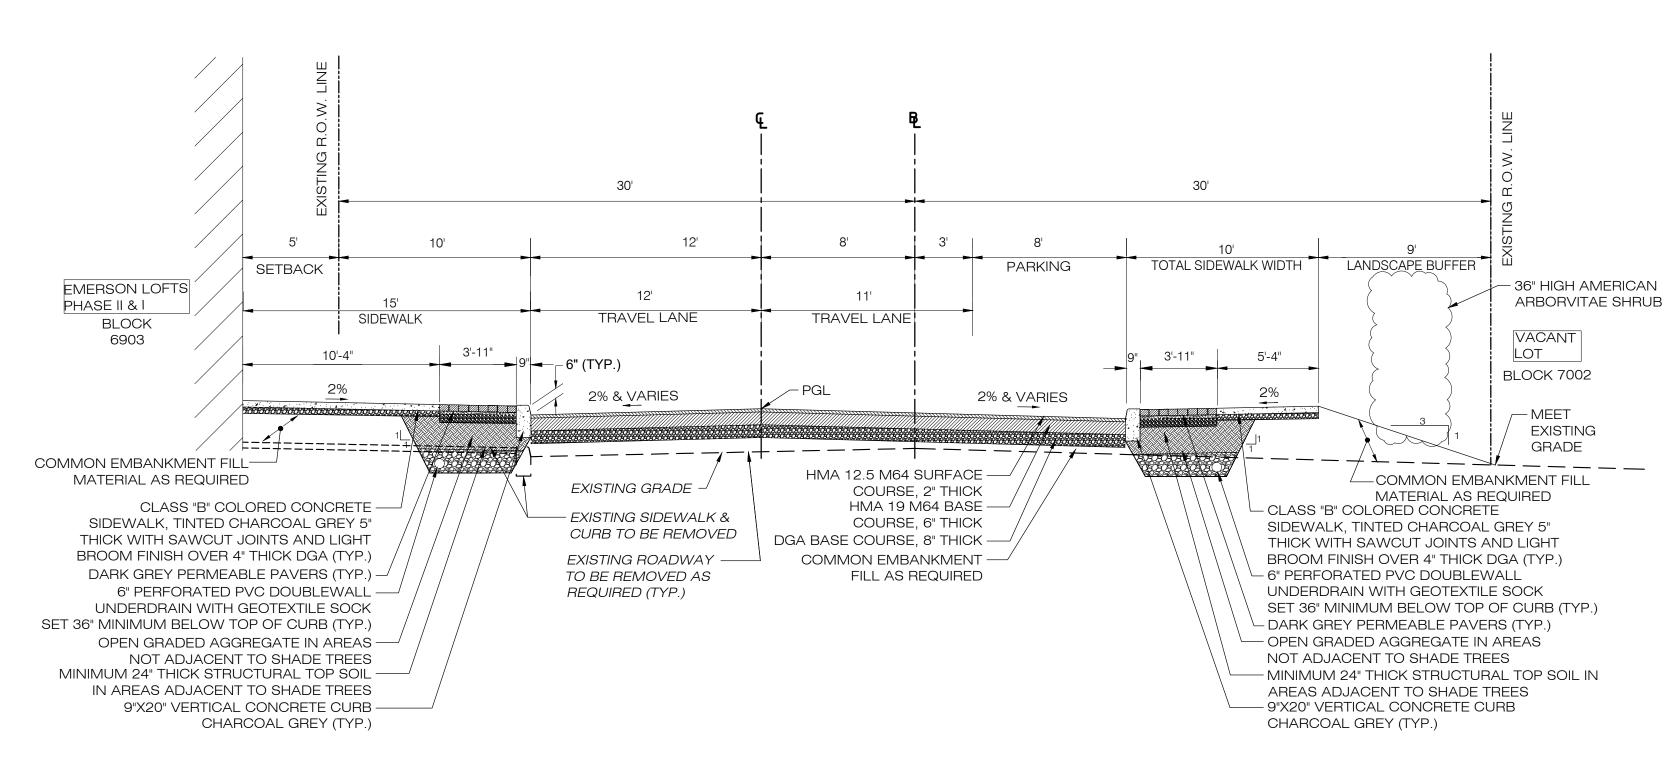
16TH STREET TYPICAL ROADWAY SECTION STA 10+20 TO STA 14+40



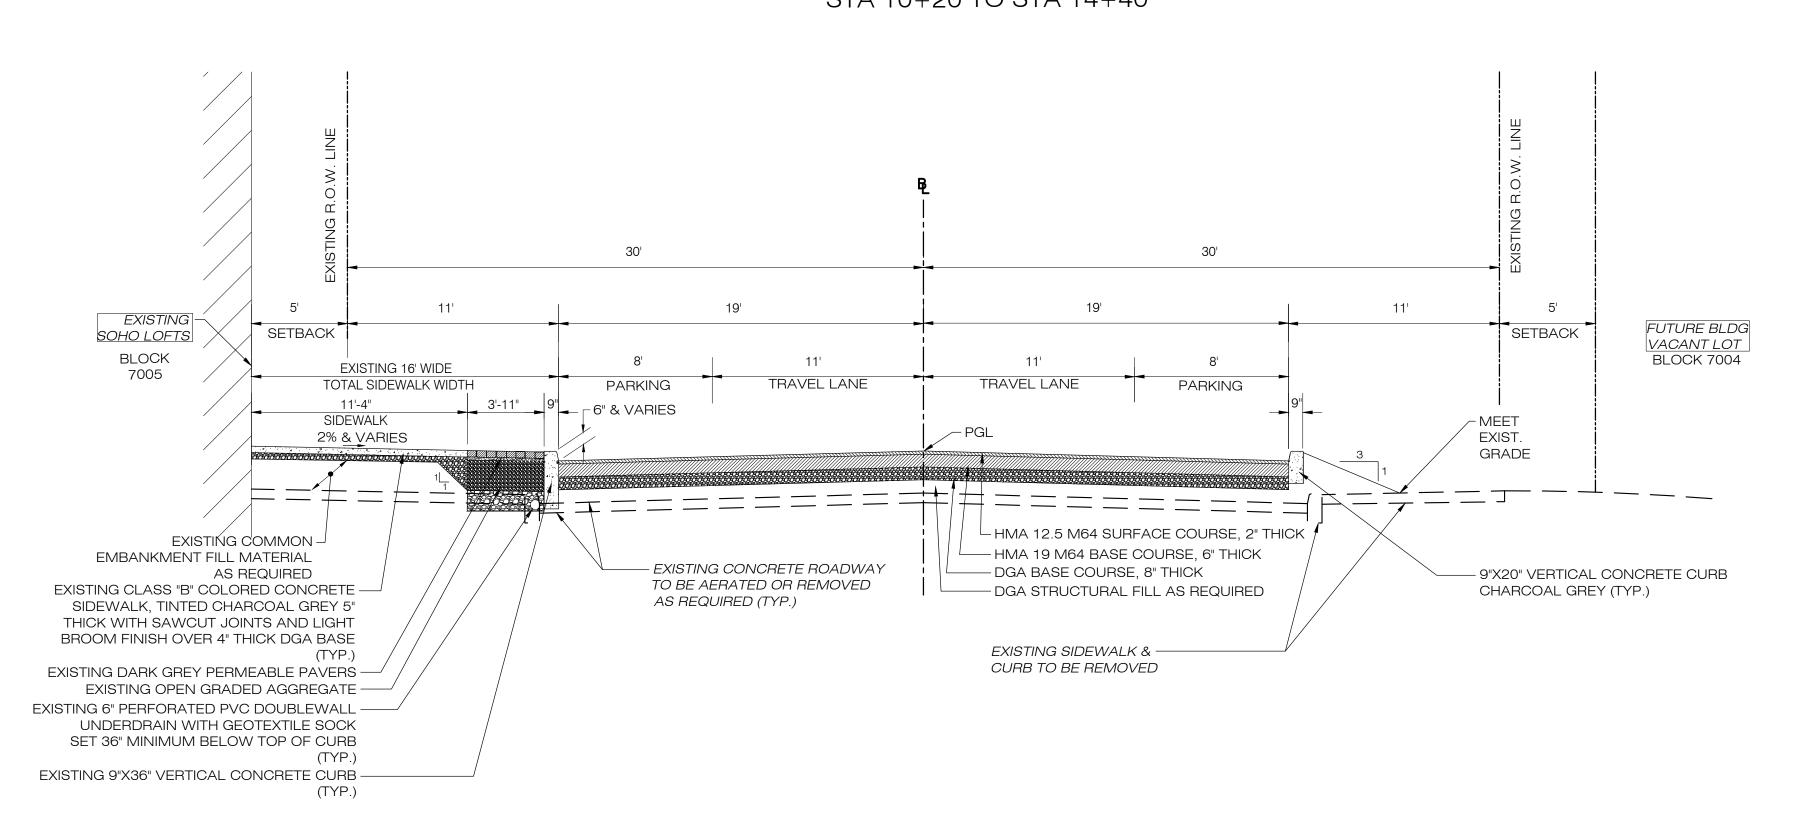14TH STREET TYPICAL ROADWAY SECTION STA 10+20 TO STA 14+40



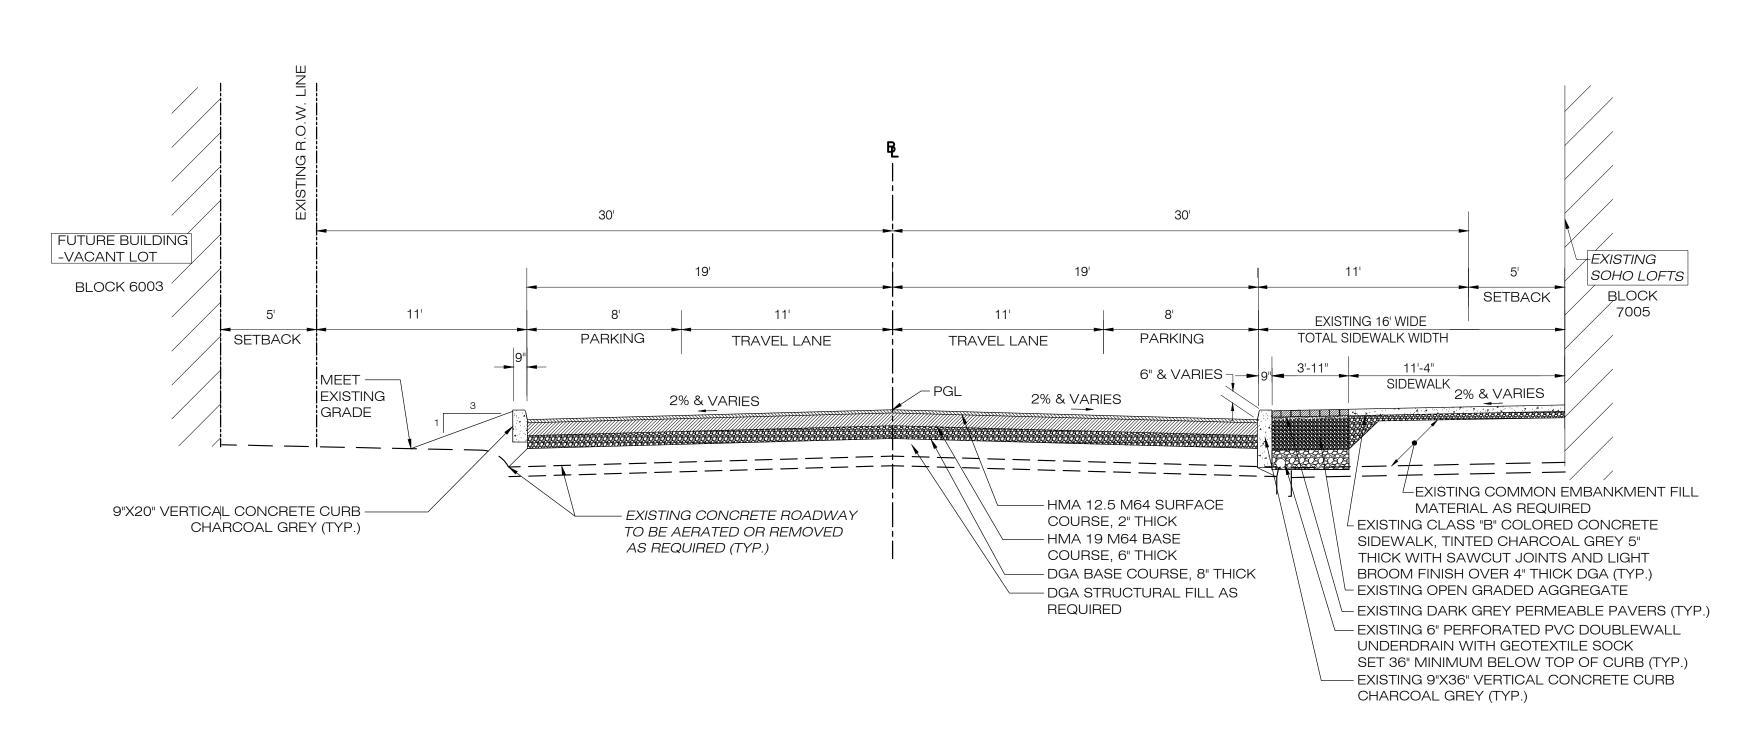15TH STREET TYPICAL ROADWAY SECTION STA 10+20 TO STA 11+30



16TH STREET TYPICAL ROADWAY SECTION

08.26.21

09.13.21

11.03.21

11.18.21

01.04.22

01.05.22

01.28.22

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DRAWING TITLE

DRAWING NUMBER:

TYPICAL ROADWAY

SECTIONS 2

EMERSON LOFTS

JERSEY CITY, HUDSON COUNTY, NJ

by Jeffrey Reeves Date:

2023.11.28 10:56:17-05'00'


PHASE III


255-259 COLES STREET,


BLOCK 6903,

LOTS 3.04

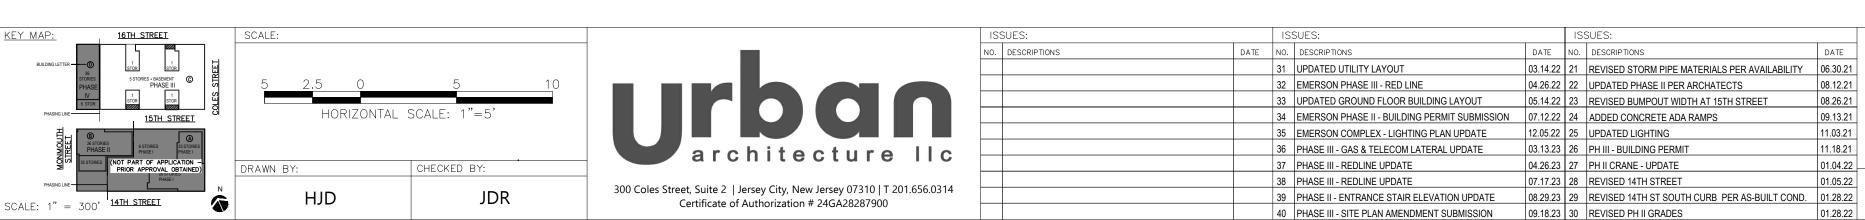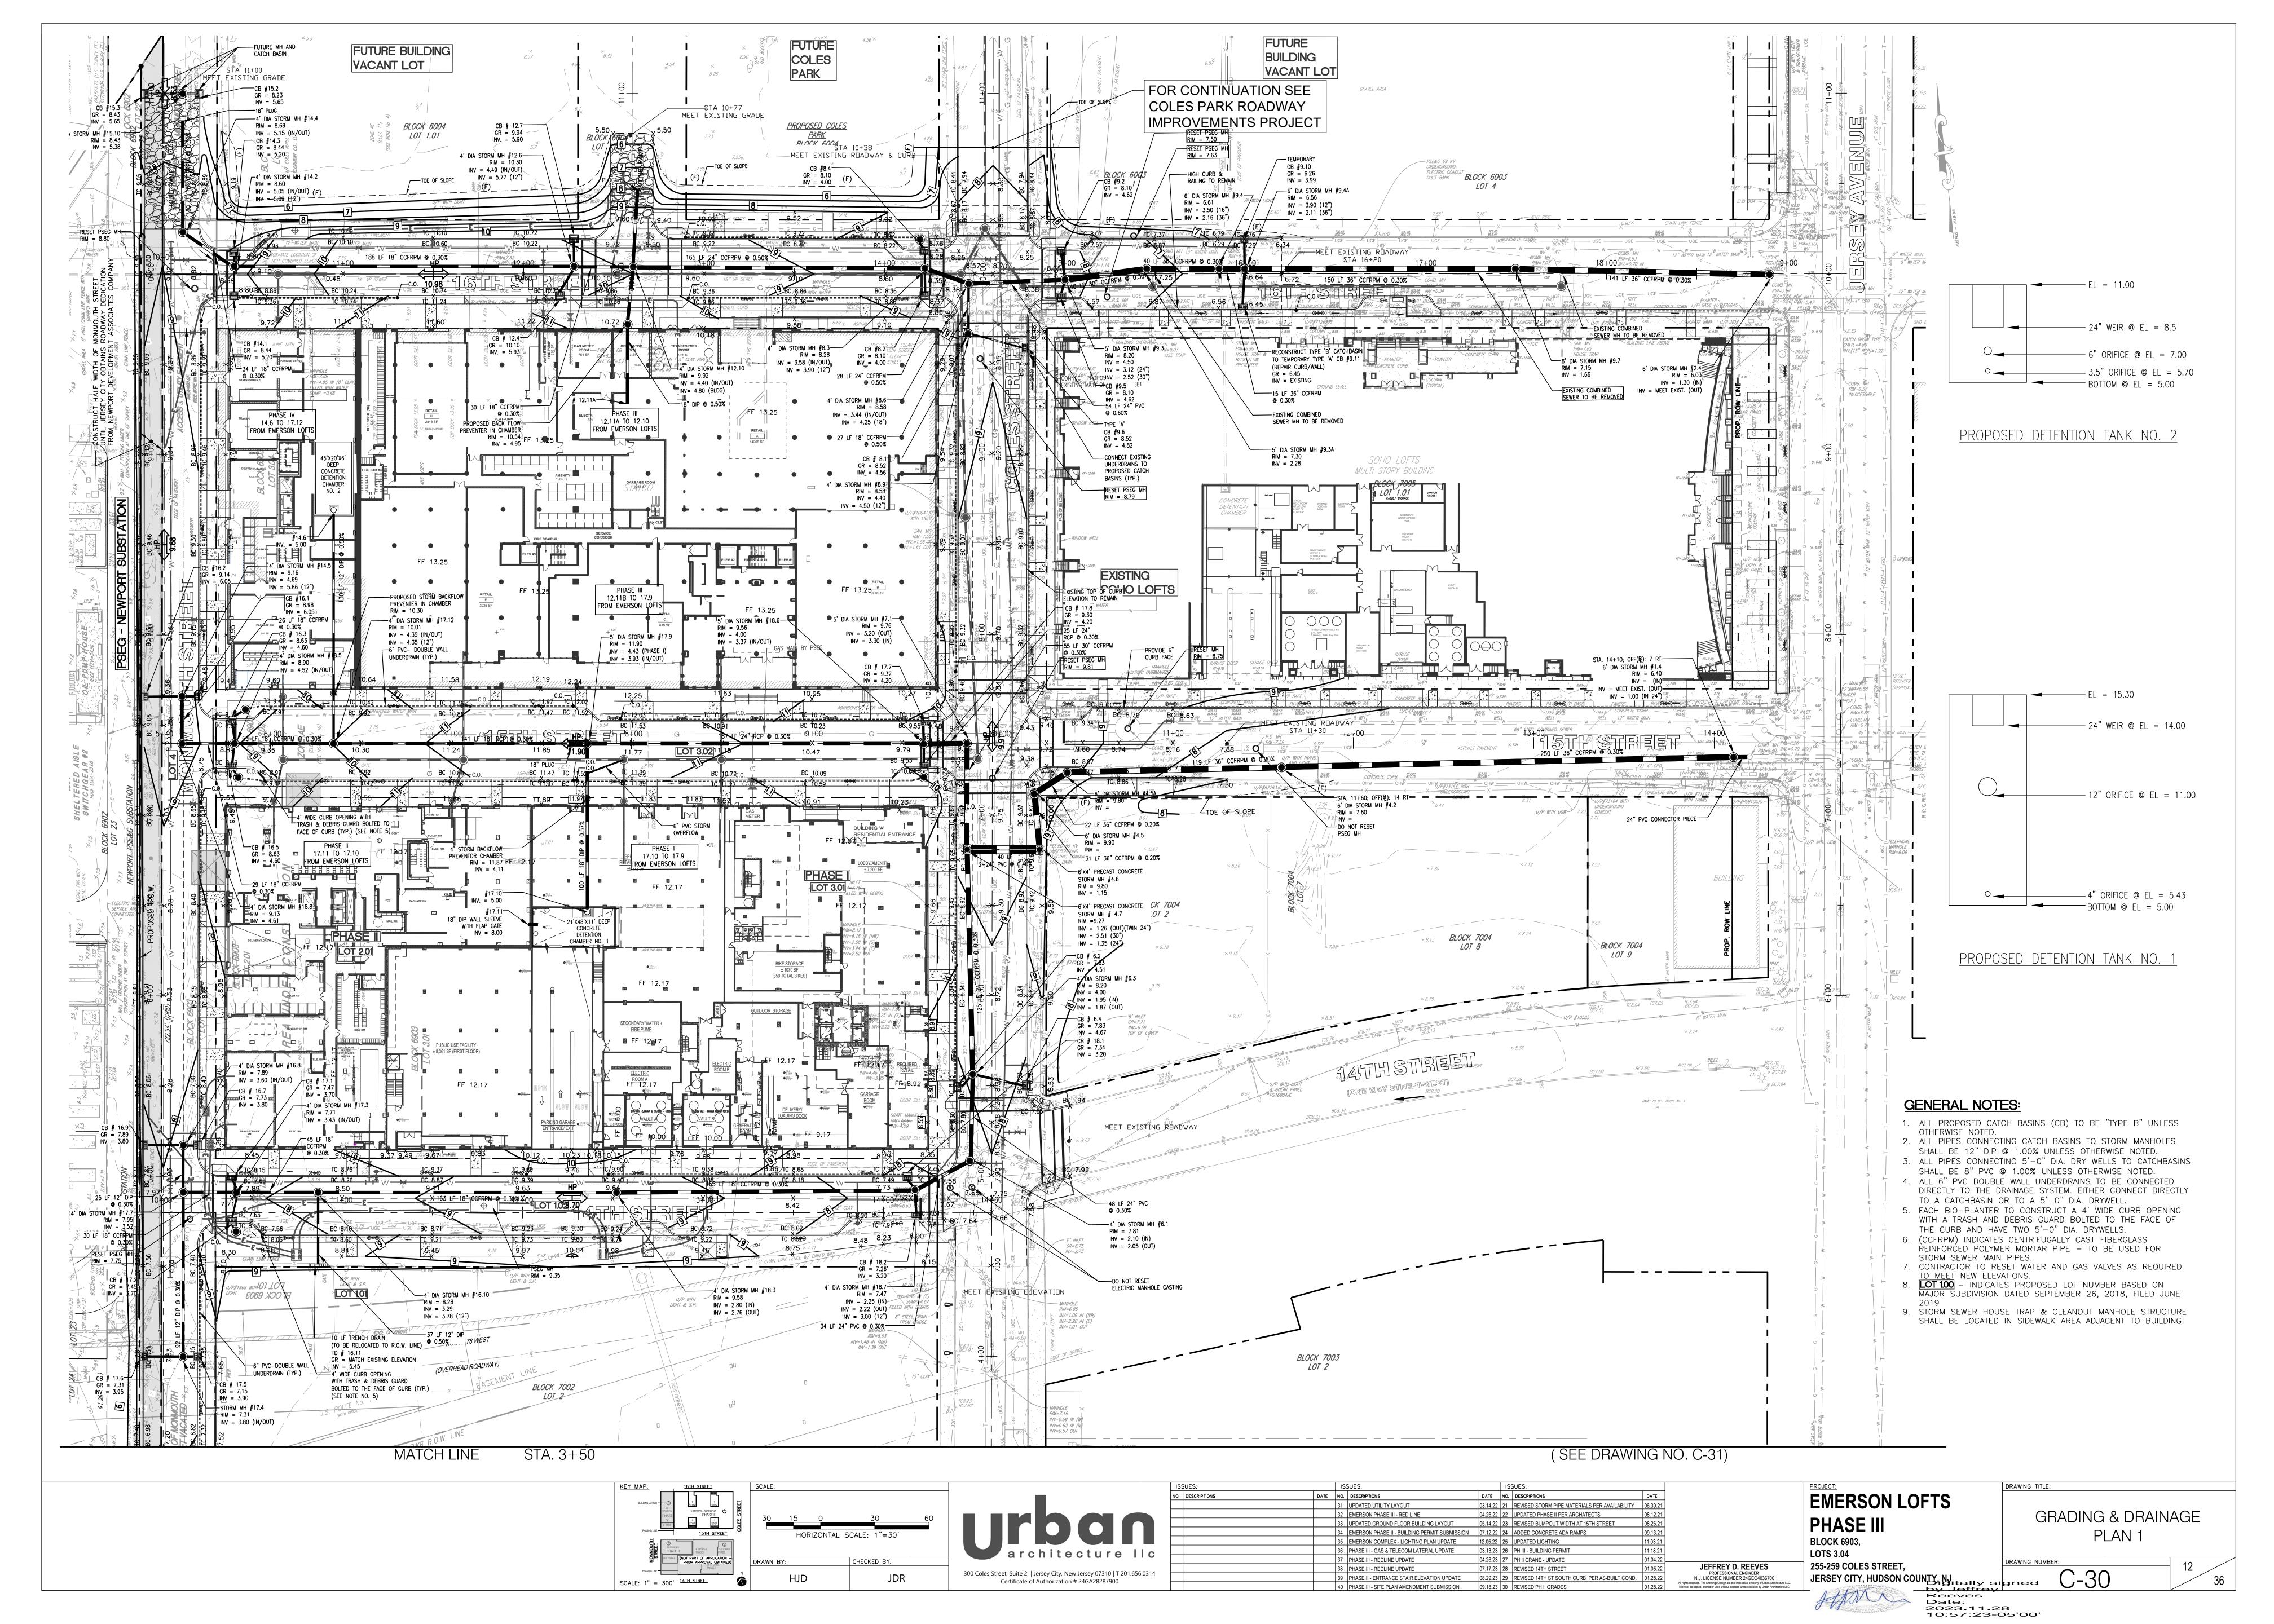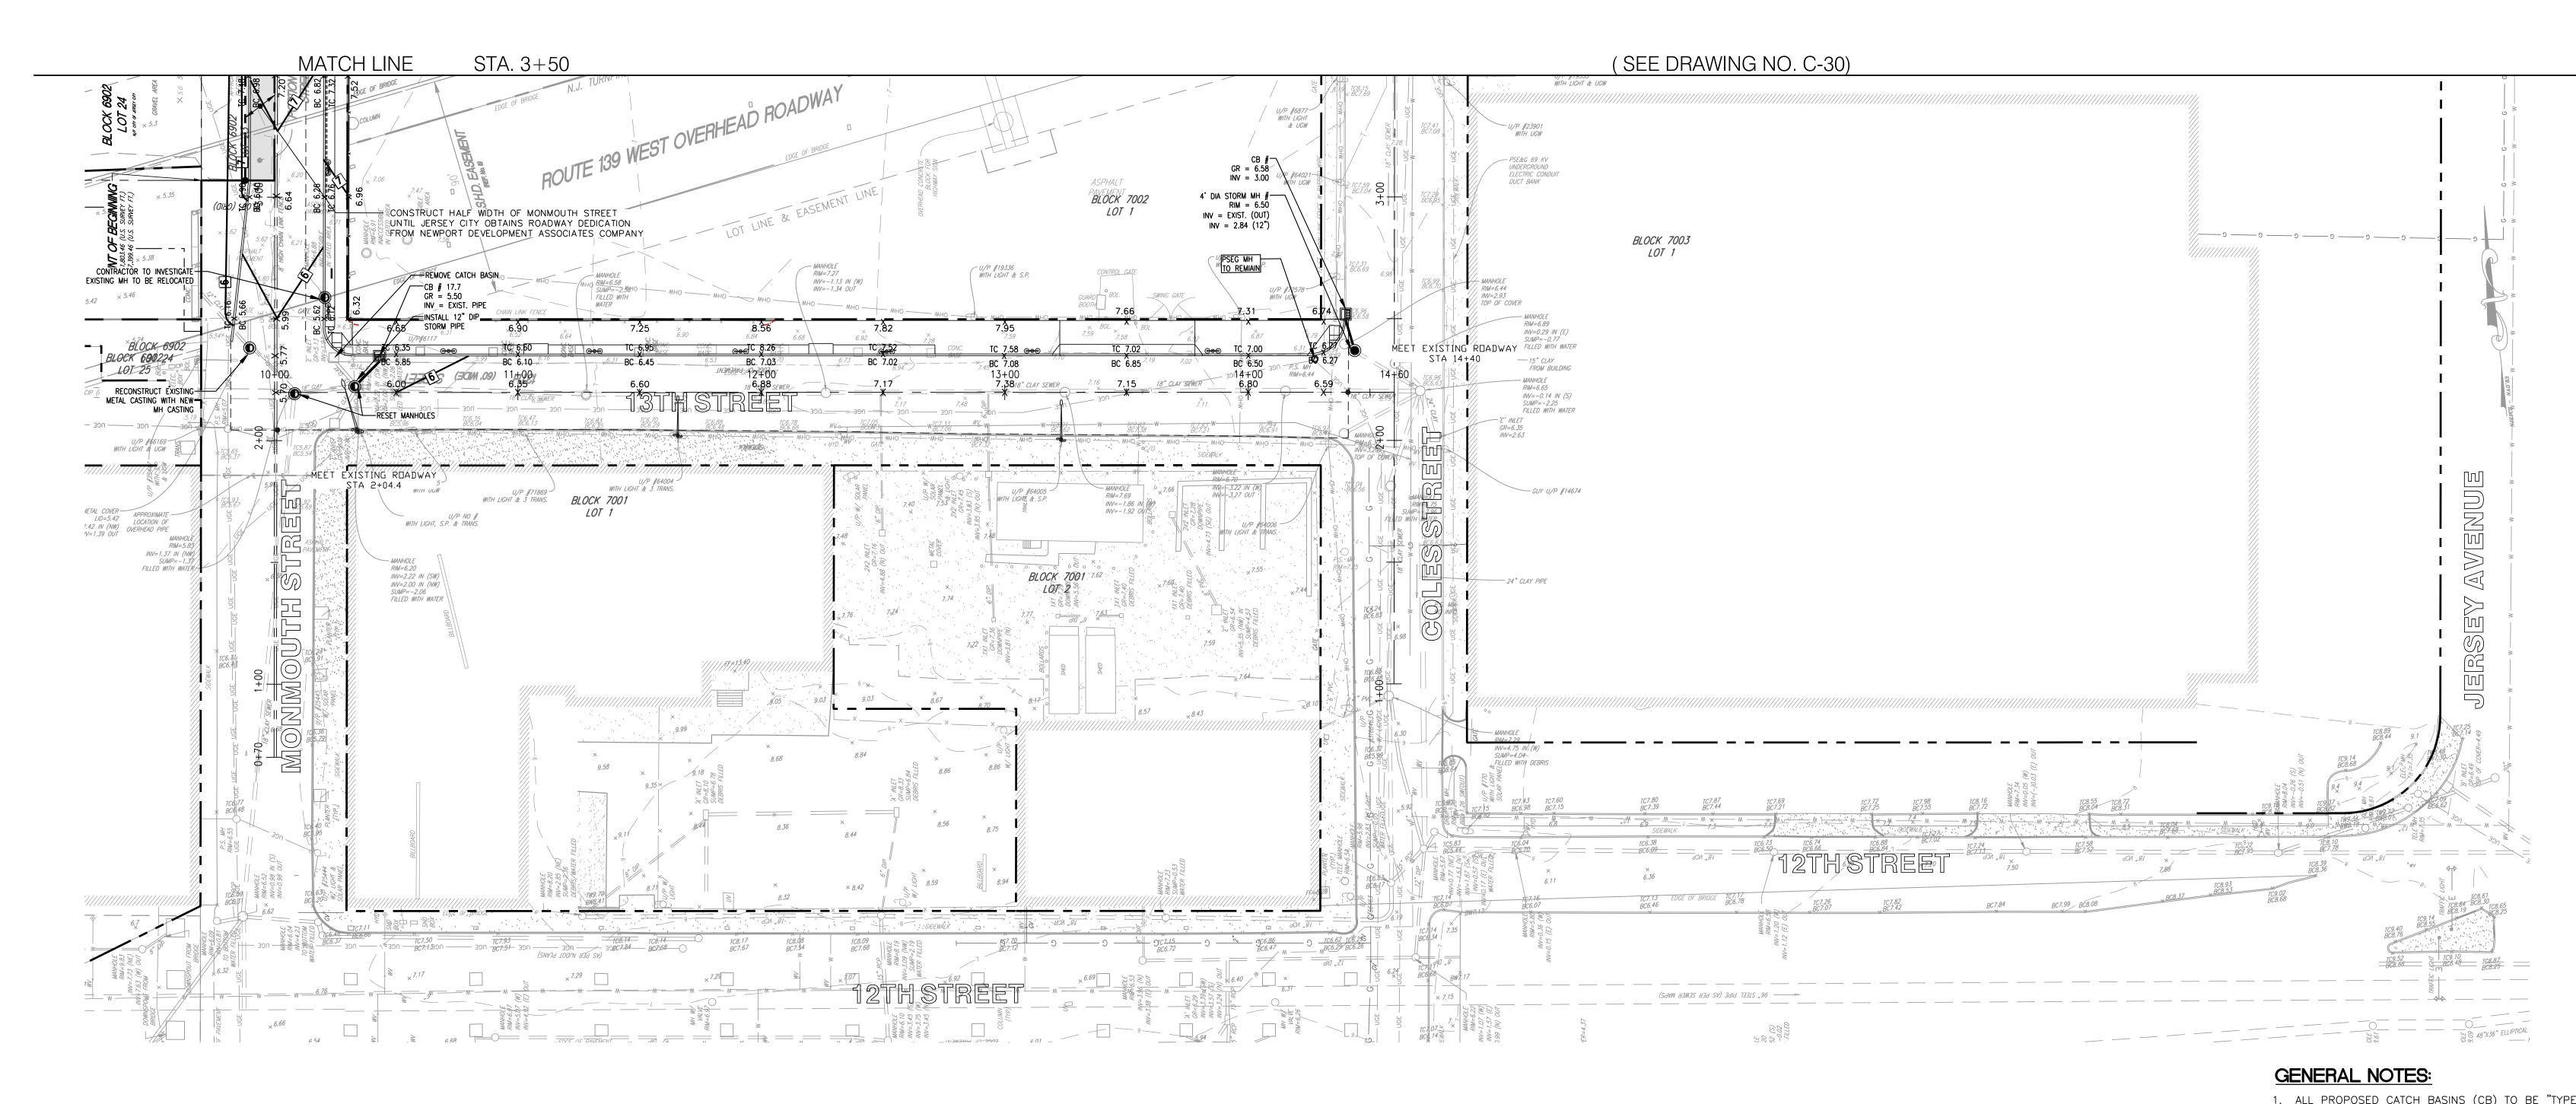STA 14+80 TO STA 16+20








- 1. ALL PROPOSED CATCH BASINS (CB) TO BE "TYPE B" UNLESS OTHERWISE NOTED. 2. ALL PIPES CONNECTING CATCH BASINS TO STORM MANHOLES
- SHALL BE 12" DIP @ 1.00% UNLESS OTHERWISE NOTED. 3. ALL PIPES CONNECTING 5'-0" DIA. DRY WELLS TO CATCHBASINS
- SHALL BE 8" PVC @ 1.00% UNLESS OTHERWISE NOTED. 4. ALL 6" PVC DOUBLE WALL UNDERDRAINS TO BE CONNECTED
- DIRECTLY TO THE DRAINAGE SYSTEM. EITHER CONNECT DIRECTLY TO A CATCHBASIN OR TO A 5'-0" DIA. DRYWELL.
- 5. EACH BIO-PLANTER TO CONSTRUCT A 4' WIDE CURB OPENING WITH A TRASH AND DEBRIS GUARD BOLTED TO THE FACE OF
- THE CURB AND HAVE TWO 5'-0" DIA. DRYWELLS. 6. (CCFRPM) INDICATES CENTRIFUGALLY CAST FIBERGLASS
- REINFORCED POLYMER MORTAR PIPE TO BE USED FOR
- STORM SEWER MAIN PIPES.
- 7. CONTRACTOR TO RESET WATER AND GAS VALVES AS REQUIRED TO MEET NEW ELEVATIONS.

 8. LOT 1.00 — INDICATES PROPOSED LOT NUMBER BASED ON MAJOR SUBDIVISION DATED SEPTEMBER 26, 2018, FILED JUNE

DRAWING TITLE:

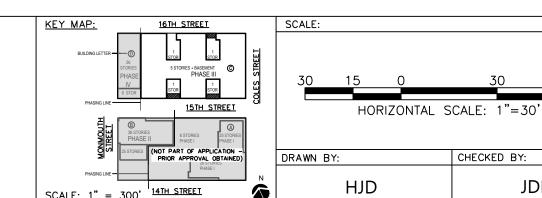9. STORM SEWER HOUSE TRAP & CLEANOUT MANHOLE STRUCTURE SHALL BE LOCATED IN SIDEWALK AREA ADJACENT TO BUILDING.



CHECKED BY:

JDR



31 UPDATED UTILITY LAYOUT 03.14.22 21 REVISED STORM PIPE MATERIALS PER AVAILABILITY 06.30.21 32 EMERSON PHASE III - RED LINE 04.26.22 22 UPDATED PHASE II PER ARCHATECTS 08.12.21 33 UPDATED GROUND FLOOR BUILDING LAYOUT 05.14.22 23 REVISED BUMPOUT WIDTH AT 15TH STREET 08.26.21 34 EMERSON PHASE II - BUILDING PERMIT SUBMISSION 07.12.22 24 ADDED CONCRETE ADA RAMPS 09.13.21 35 EMERSON COMPLEX - LIGHTING PLAN UPDATE 12.05.22 25 UPDATED LIGHTING 11.03.21	
33 UPDATED GROUND FLOOR BUILDING LAYOUT 05.14.22 23 REVISED BUMPOUT WIDTH AT 15TH STREET 08.26.21 34 EMERSON PHASE II - BUILDING PERMIT SUBMISSION 07.12.22 24 ADDED CONCRETE ADA RAMPS 09.13.21	
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35 FMERSON COMPLEX - LIGHTING PLAN UPDATE 12.05.22 25 UPDATED LIGHTING 11.03.21	
TO DESCRIPTION OF THE PROPERTY	
36 PHASE III - GAS & TELECOM LATERAL UPDATE 03.13.23 26 PH III - BUILDING PERMIT 11.18.21	
37 PHASE III - REDLINE UPDATE 04.26.23 27 PH II CRANE - UPDATE 01.04.22	
38 PHASE III - REDLINE UPDATE 07.17.23 28 REVISED 14TH STREET 01.05.22 JEFFREY D. REEVES	3
39 PHASE II - ENTRANCE STAIR ELEVATION UPDATE 08.29.23 29 REVISED 14TH ST SOUTH CURB PER AS-BUILT COND. 01.28.22 N.J. LICENSE NUMBER 24GE0403I	
40 PHASE III - SITE PLAN AMENDMENT SUBMISSION 09.18.23 30 REVISED PH II GRADES 01.28.22 All rights reserved. The Drawings Design are the Intellectual property of Ur	

ISSUES:

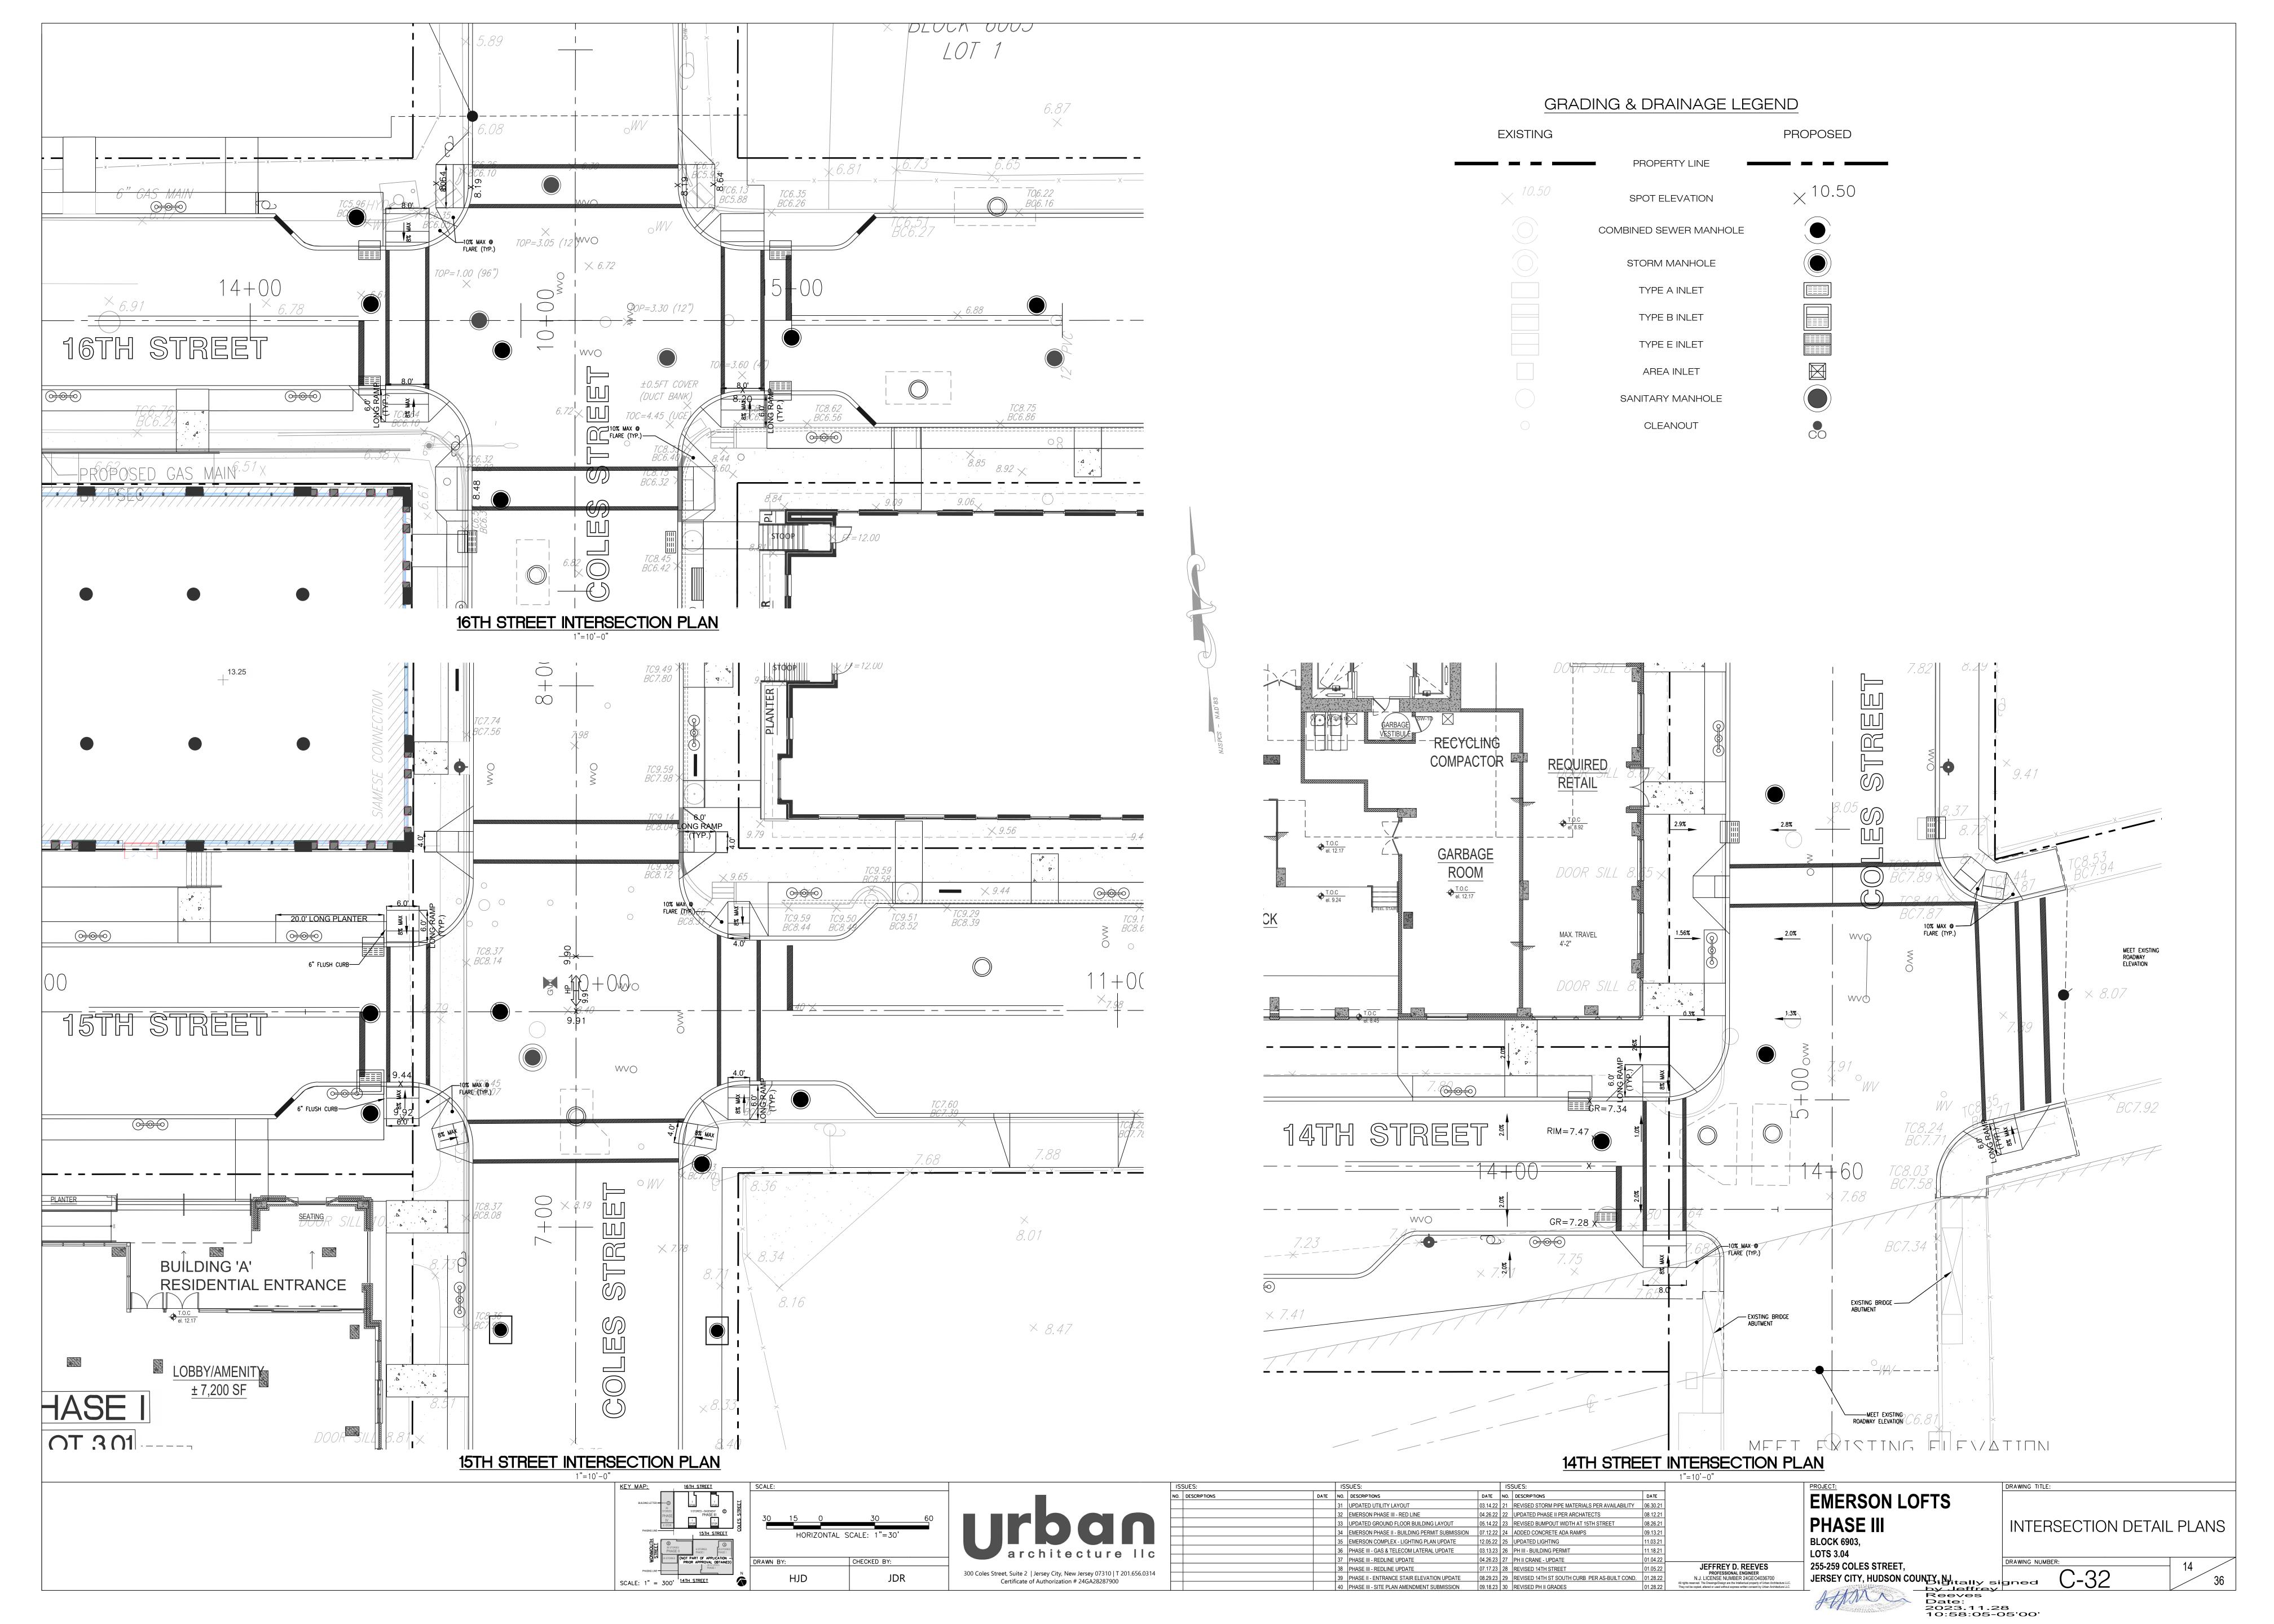
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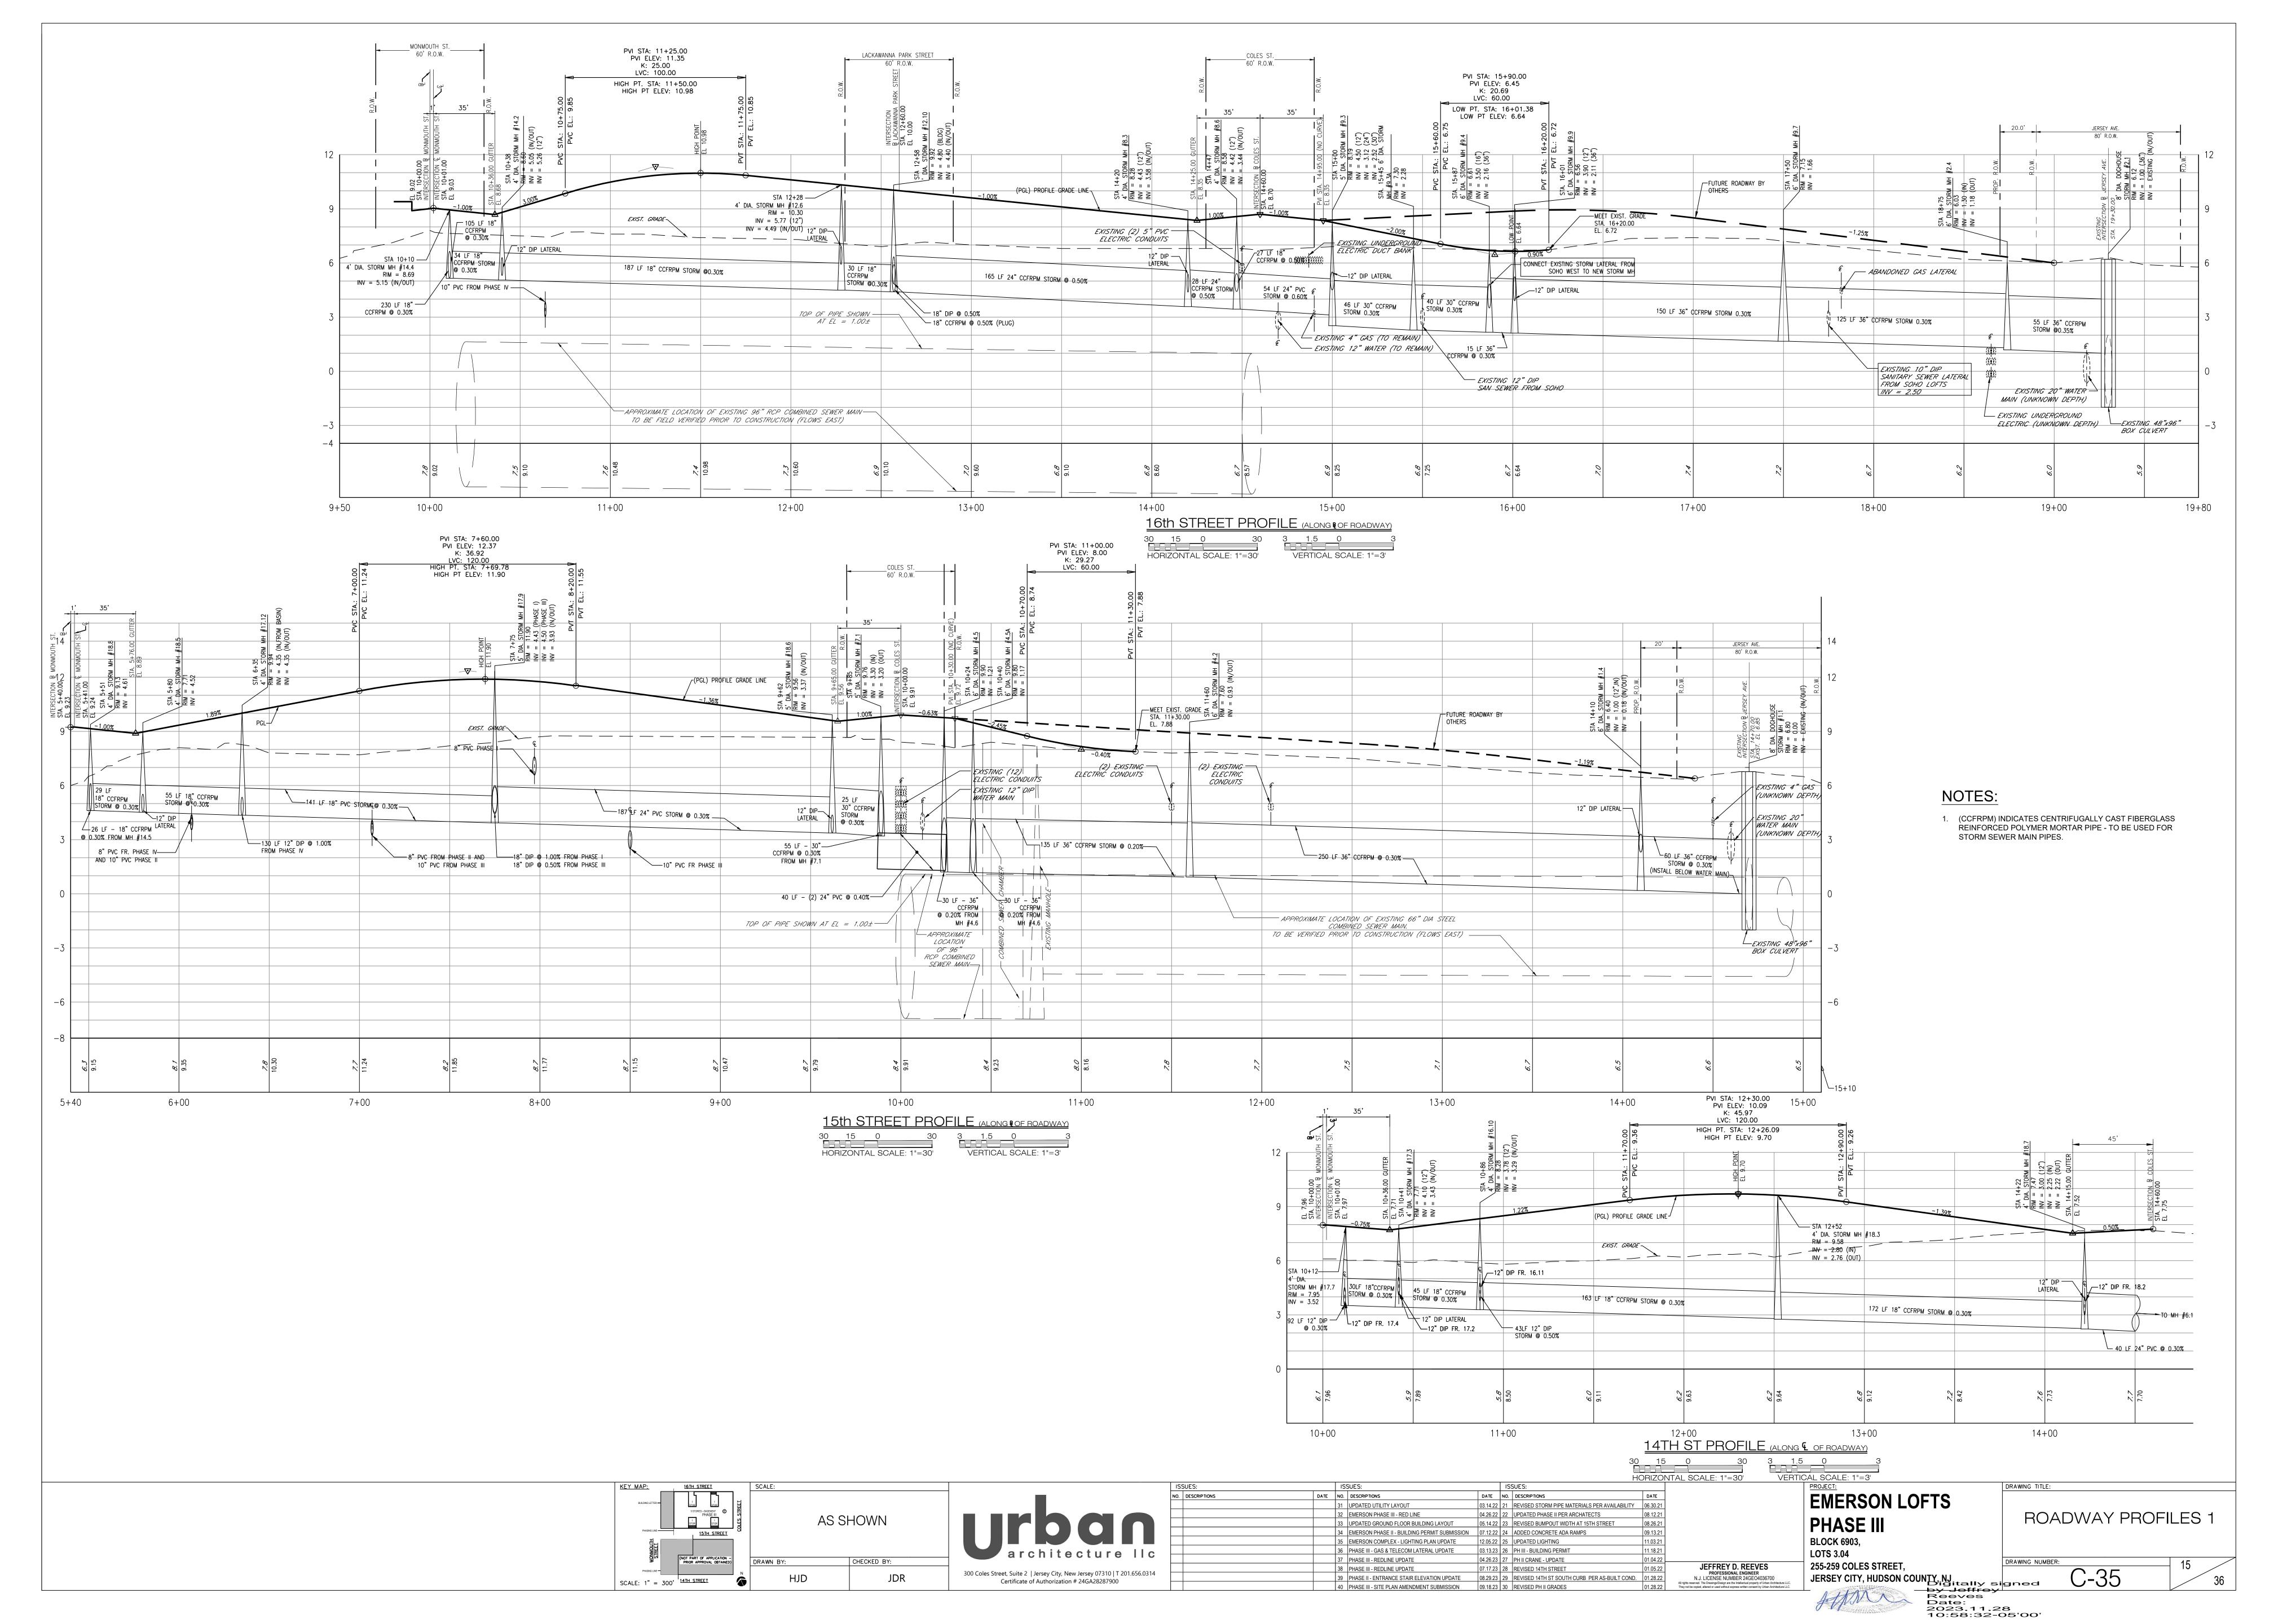
EMERSON LOFTS PHASE III BLOCK 6903, LOTS 3.04 255-259 COLES STREET,


GRADING & DRAINAGE PLAN 2

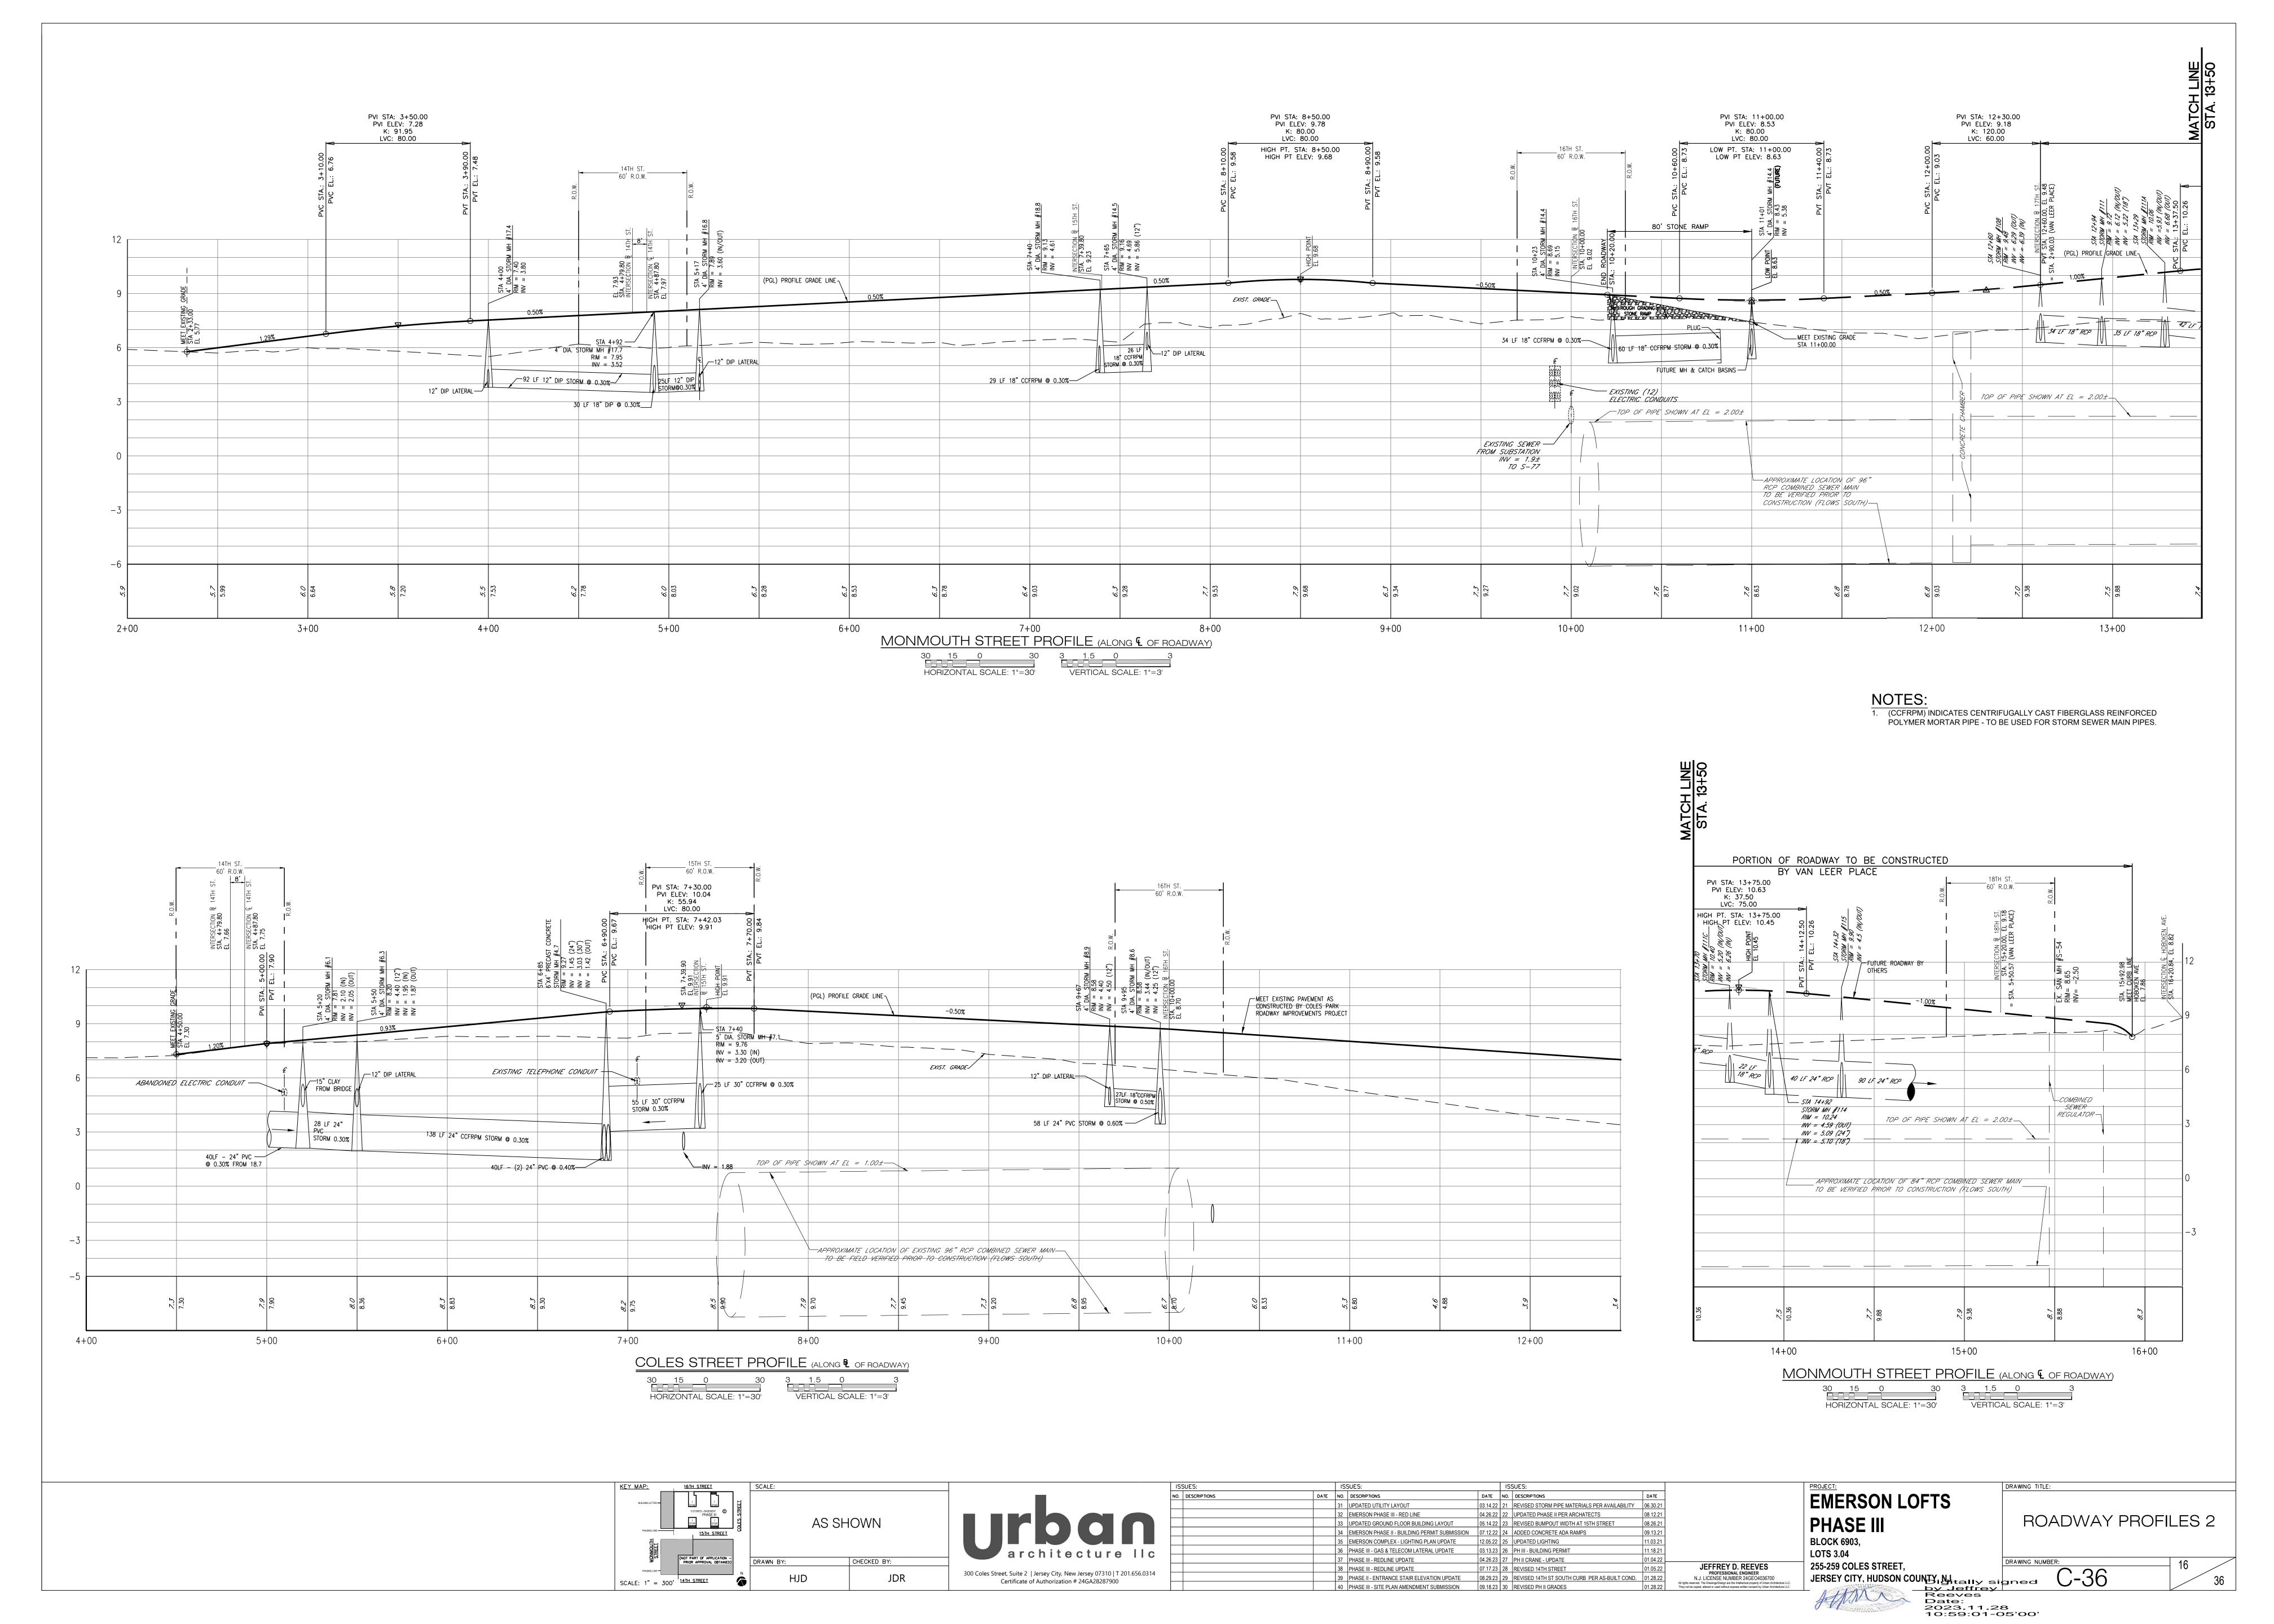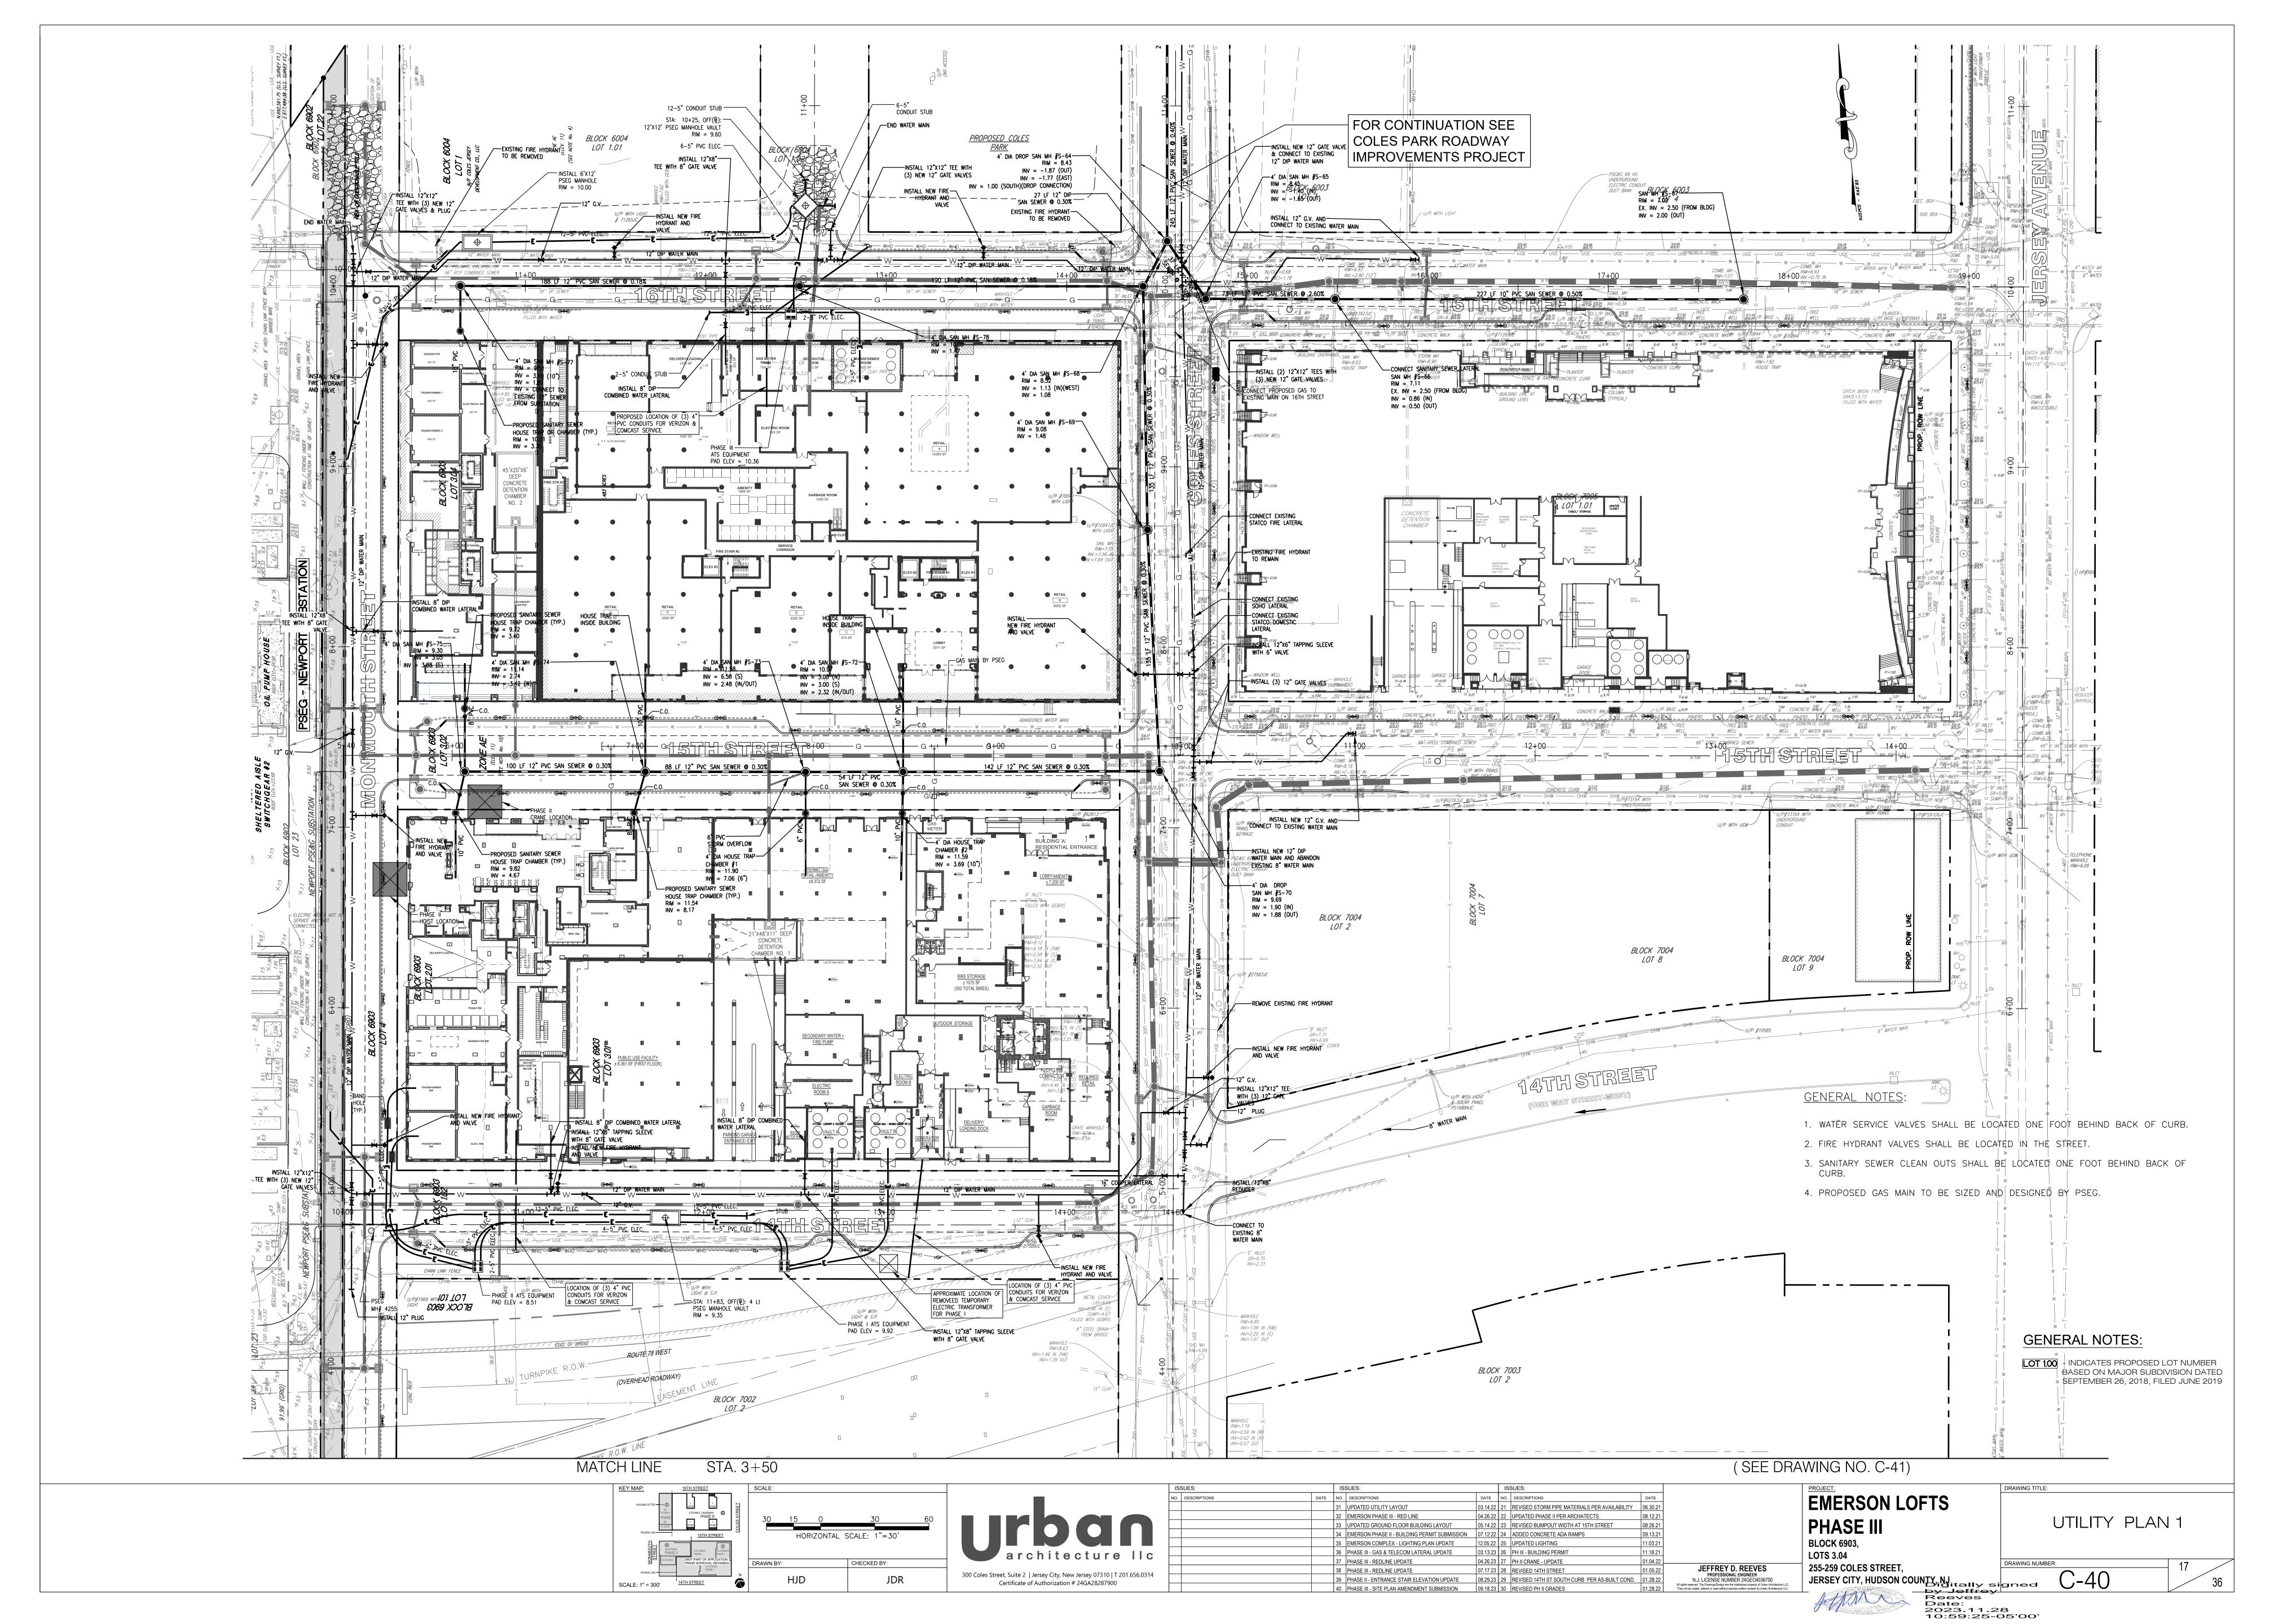
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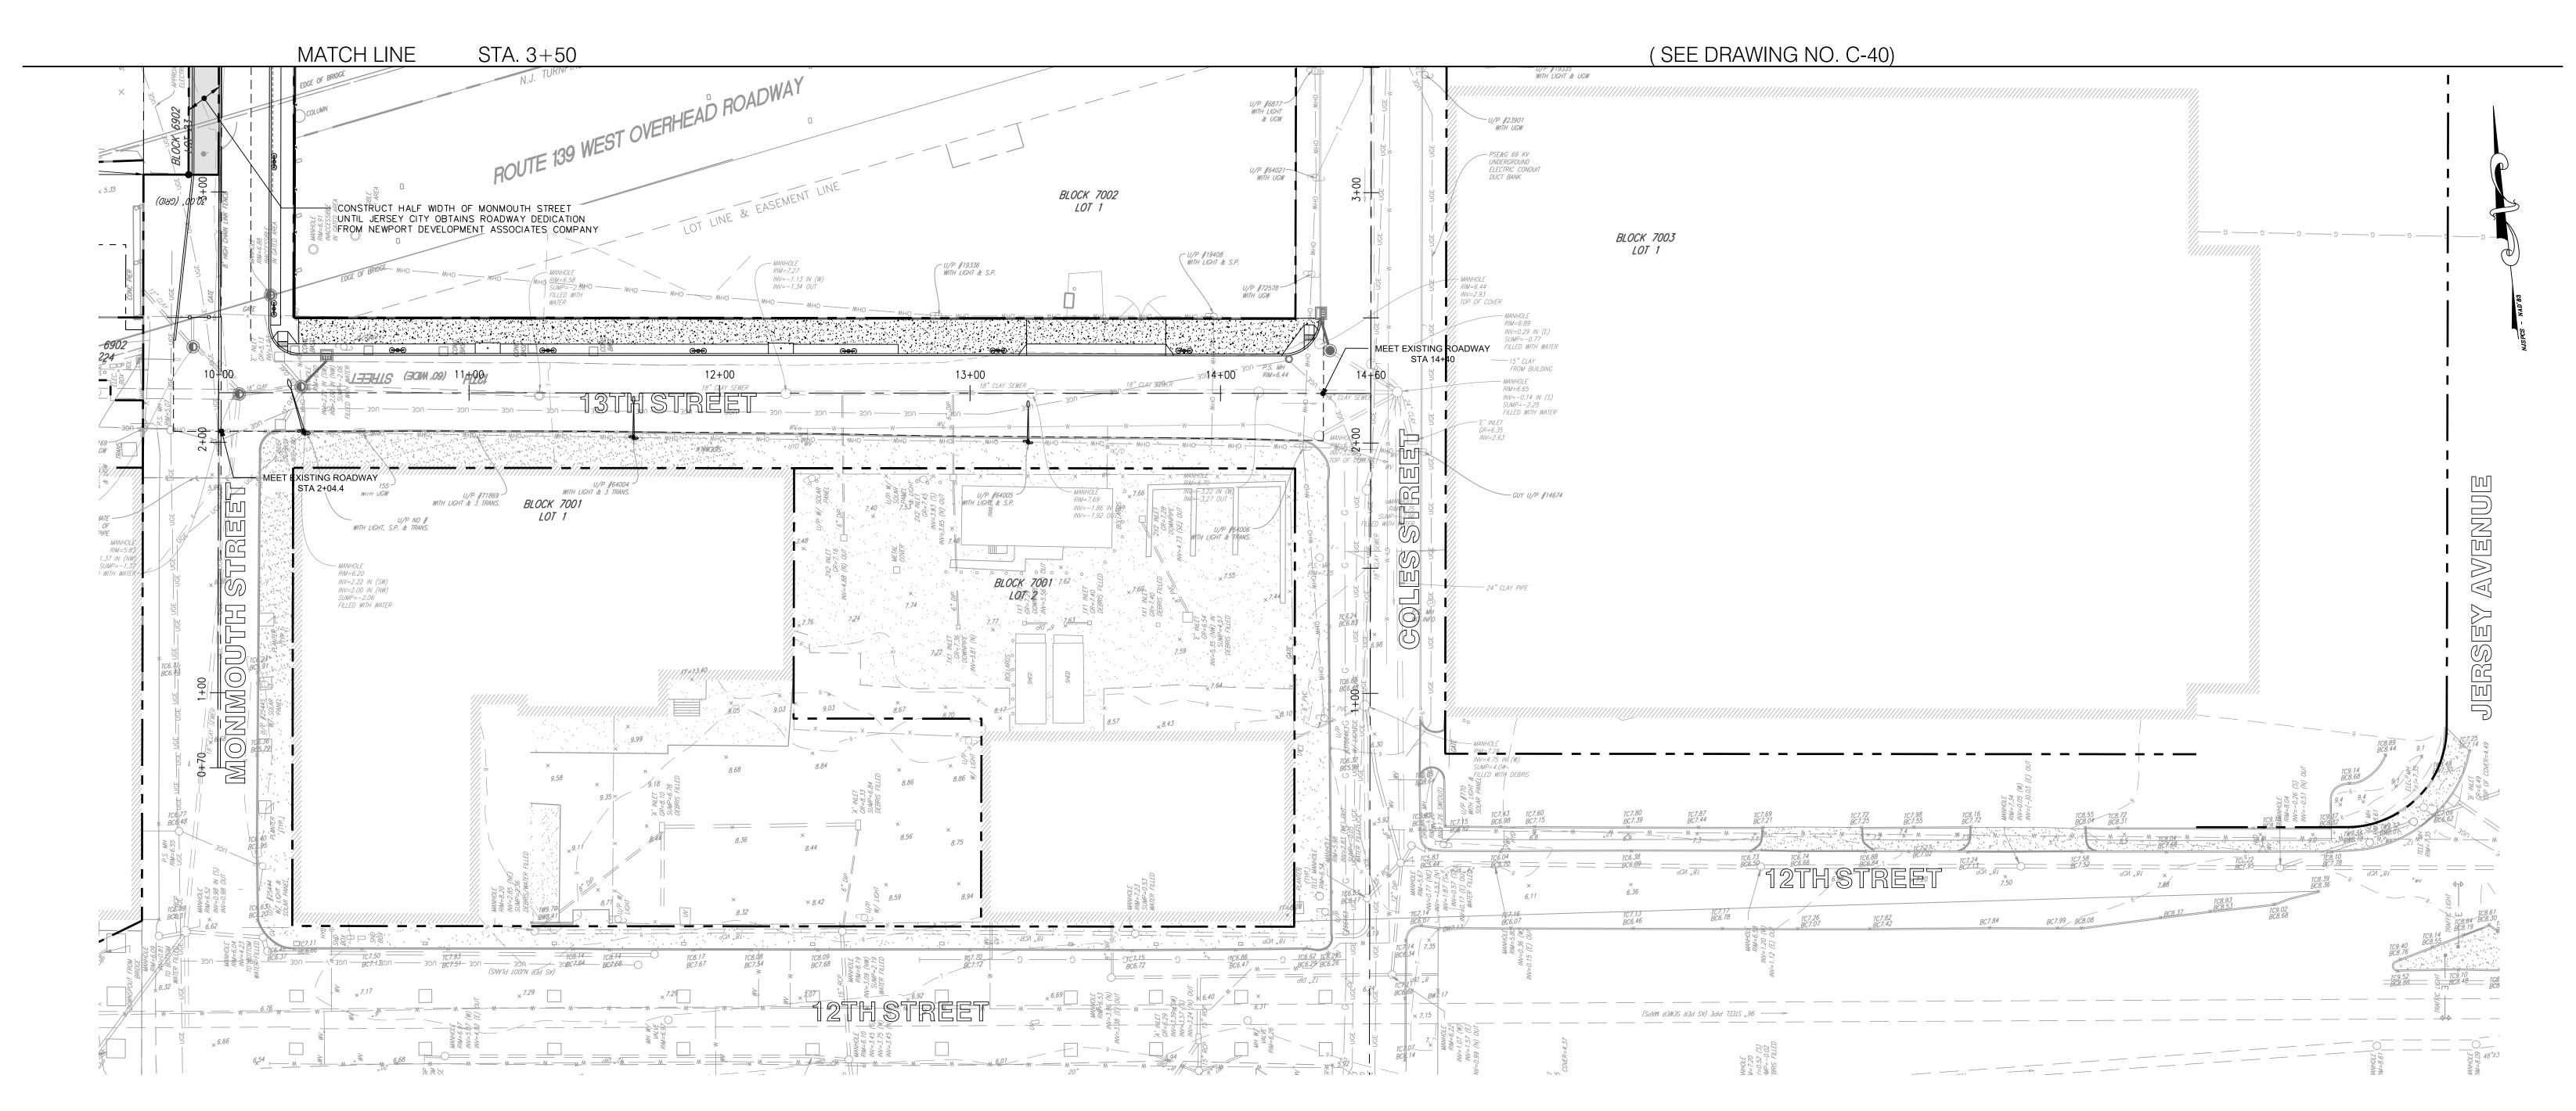
JERSEY CITY, HUDSON COUNTY NJ signed by Jeffrey
Reeves
Date:
2023.11.28
10:57:50-05'00'













GENERAL NOTES:

- WATER SERVICE VALVES SHALL BE LOCATED ONE FOOT BEHIND BACK OF CURB.
 FIRE HYDRANT VALVES SHALL BE LOCATED IN THE STREET.
- 3. SANITARY SEWER CLEAN OUTS SHALL BE LOCATED ONE FOOT BEHIND BACK OF CURB.
- 4. PROPOSED GAS MAIN TO BE SIZED AND DESIGNED BY PSEG.


GENERAL NOTES:

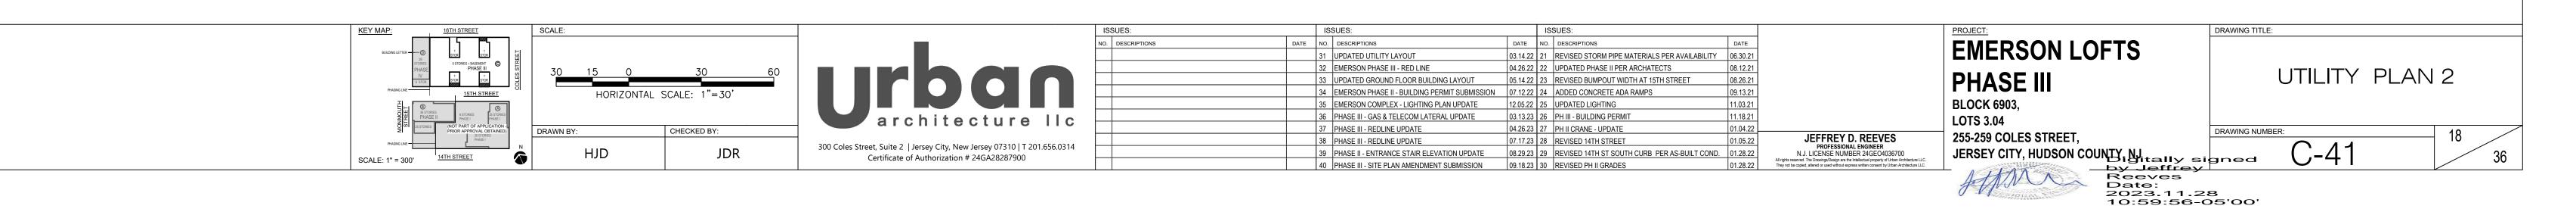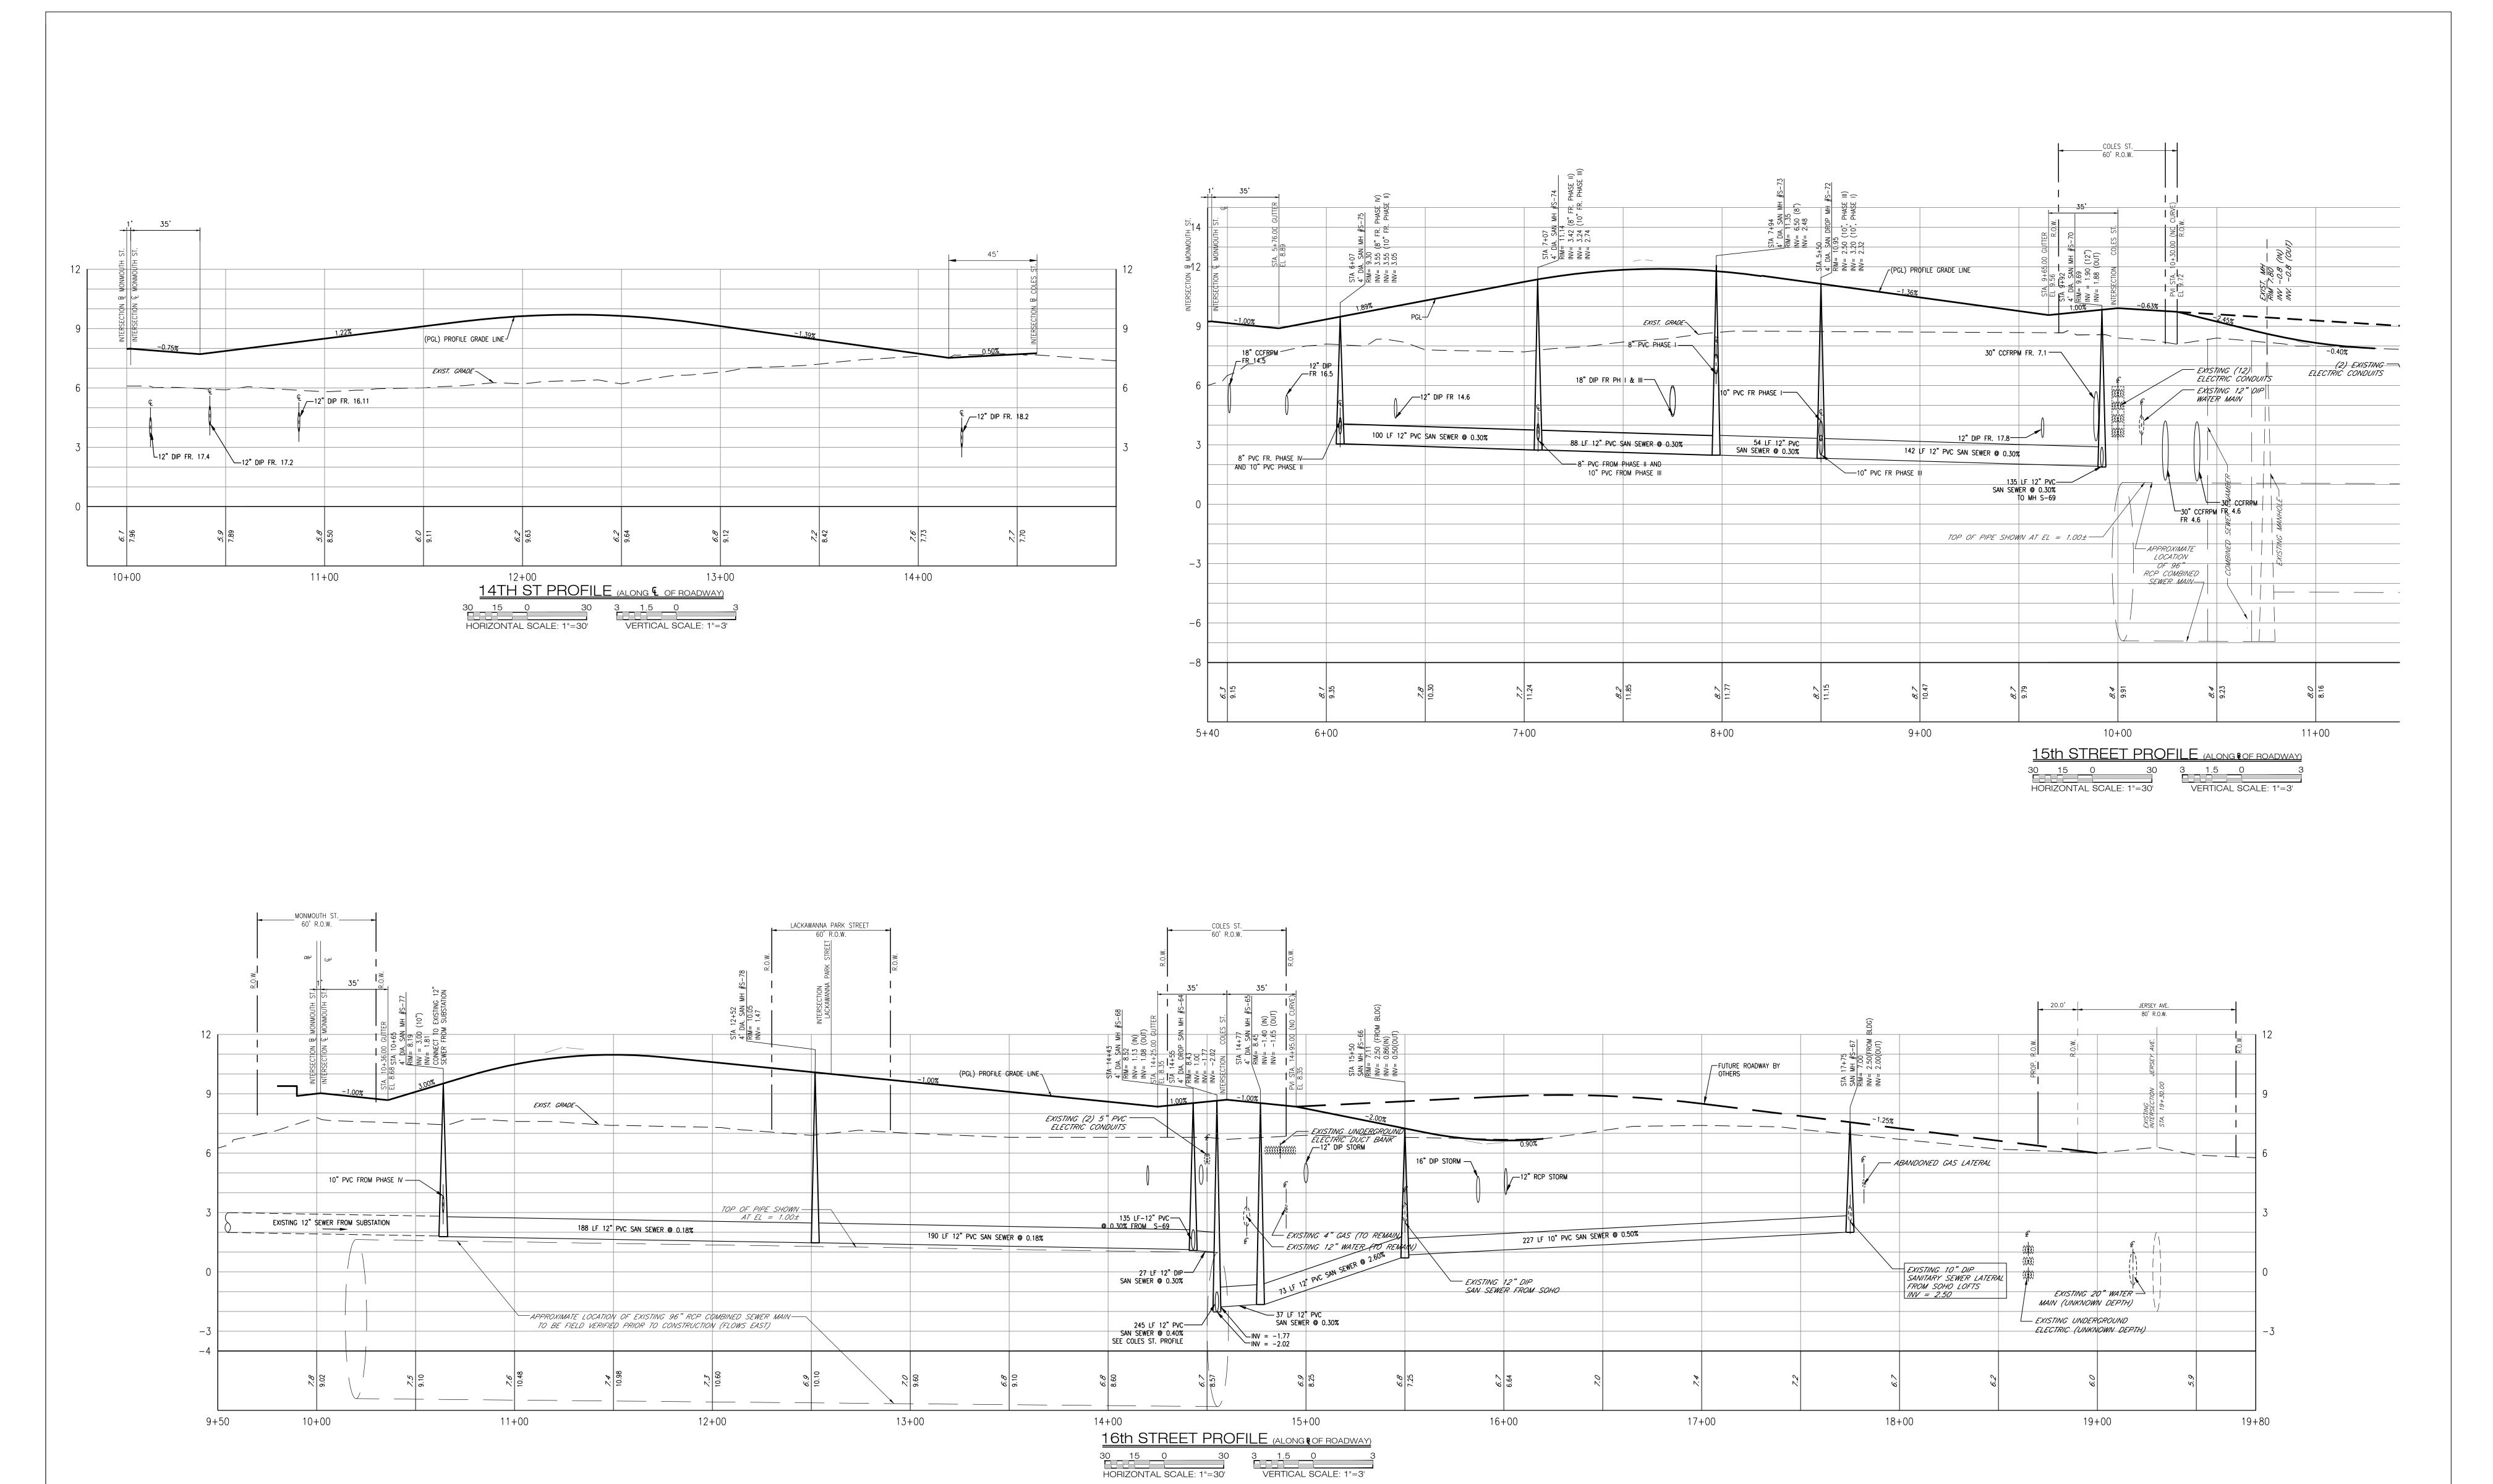
LOT 1.00 - INDICATES PROPOSED LOT NUMBER BASED ON MAJOR SUBDIVISION DATED SEPTEMBER 26, 2018, FILED JUNE 2019





KEY MAP: 16TH STREET SCALE:		ISSUES:	ISSUES:	ISSUES:		PROJECT:	DRAWING TITLE:
BULDING LETTER — 1 1 1 1 1 1 1 1 1 1 1 1 1 1 1 1 1 1		NO. DESCRIPTIONS	DATE NO. DESCRIPTIONS 31 UPDATED UTILITY LAYOUT	DATE NO. DESCRIPTIONS DATE 03.14.22 21 REVISED STORM PIPE MATERIALS PER AVAILABILITY 06.30	E 1.21	EMERSON LOFTS	
AS SHOWN	IIII		32 EMERSON PHASE III - RED LINE 33 UPDATED GROUND FLOOR BUILDING LAYOUT 34 EMERSON PHASE II - BUILDING PERMIT SUBMISSION	04.26.22 22 UPDATED PHASE II PER ARCHATECTS 08.12 05.14.22 23 REVISED BUMPOUT WIDTH AT 15TH STREET 08.26 07.12.22 24 ADDED CONCRETE ADA RAMPS 09.13	2.21 3.21 3.21	PHASE III	UTILITY PROFILES 1
MADOUTH REFORM	architecture II		35 EMERSON COMPLEX - LIGHTING PLAN UPDATE 36 PHASE III - GAS & TELECOM LATERAL UPDATE	12.05.22 25 UPDATED LIGHTING 11.03 03.13.23 26 PH III - BUILDING PERMIT 11.18	.21 .21	BLOCK 6903, LOTS 3.04	
CHECKED BY: Checked by: C	300 Coles Street, Suite 2 Jersey City, New Jersey 07310 T 201.656.03		37 PHASE III - REDLINE UPDATE 38 PHASE III - REDLINE UPDATE 20 PHASE III - ENTRANCE STAIR ELEVATION UPDATE	04.26.23 27 PH II CRANE - UPDATE 01.04 07.17.23 28 REVISED 14TH STREET 01.05	.22 JEFFREY D. REEVES PROFESSIONAL ENGINEER N.J. LICENSE NUMBER 24GE04036700 All rights reserved. The Drawings/Design are the Intellectual property of Urbean Architecture LLC. They not be copied, altered or used without express written consent by Urban Architecture LLC.	255-259 COLES STREET,	DRAWING NUMBER: 19
SCALE: 1" = 300' 14TH STREET HJD JDR	Certificate of Authorization # 24GA28287900		40 PHASE III - SITE PLAN AMENDMENT SUBMISSION	09.18.23 30 REVISED PH II GRADES 01.26	All rights reserved. The DrawingsDesign are the Intellectual property of Urban Architecture LLC. They not be copied, altered or used without express written consent by Urban Architecture LLC.	JERSEY CITY, HUDSON COUNTY, NJ by Jeffrey Reeves	signed U-40 36

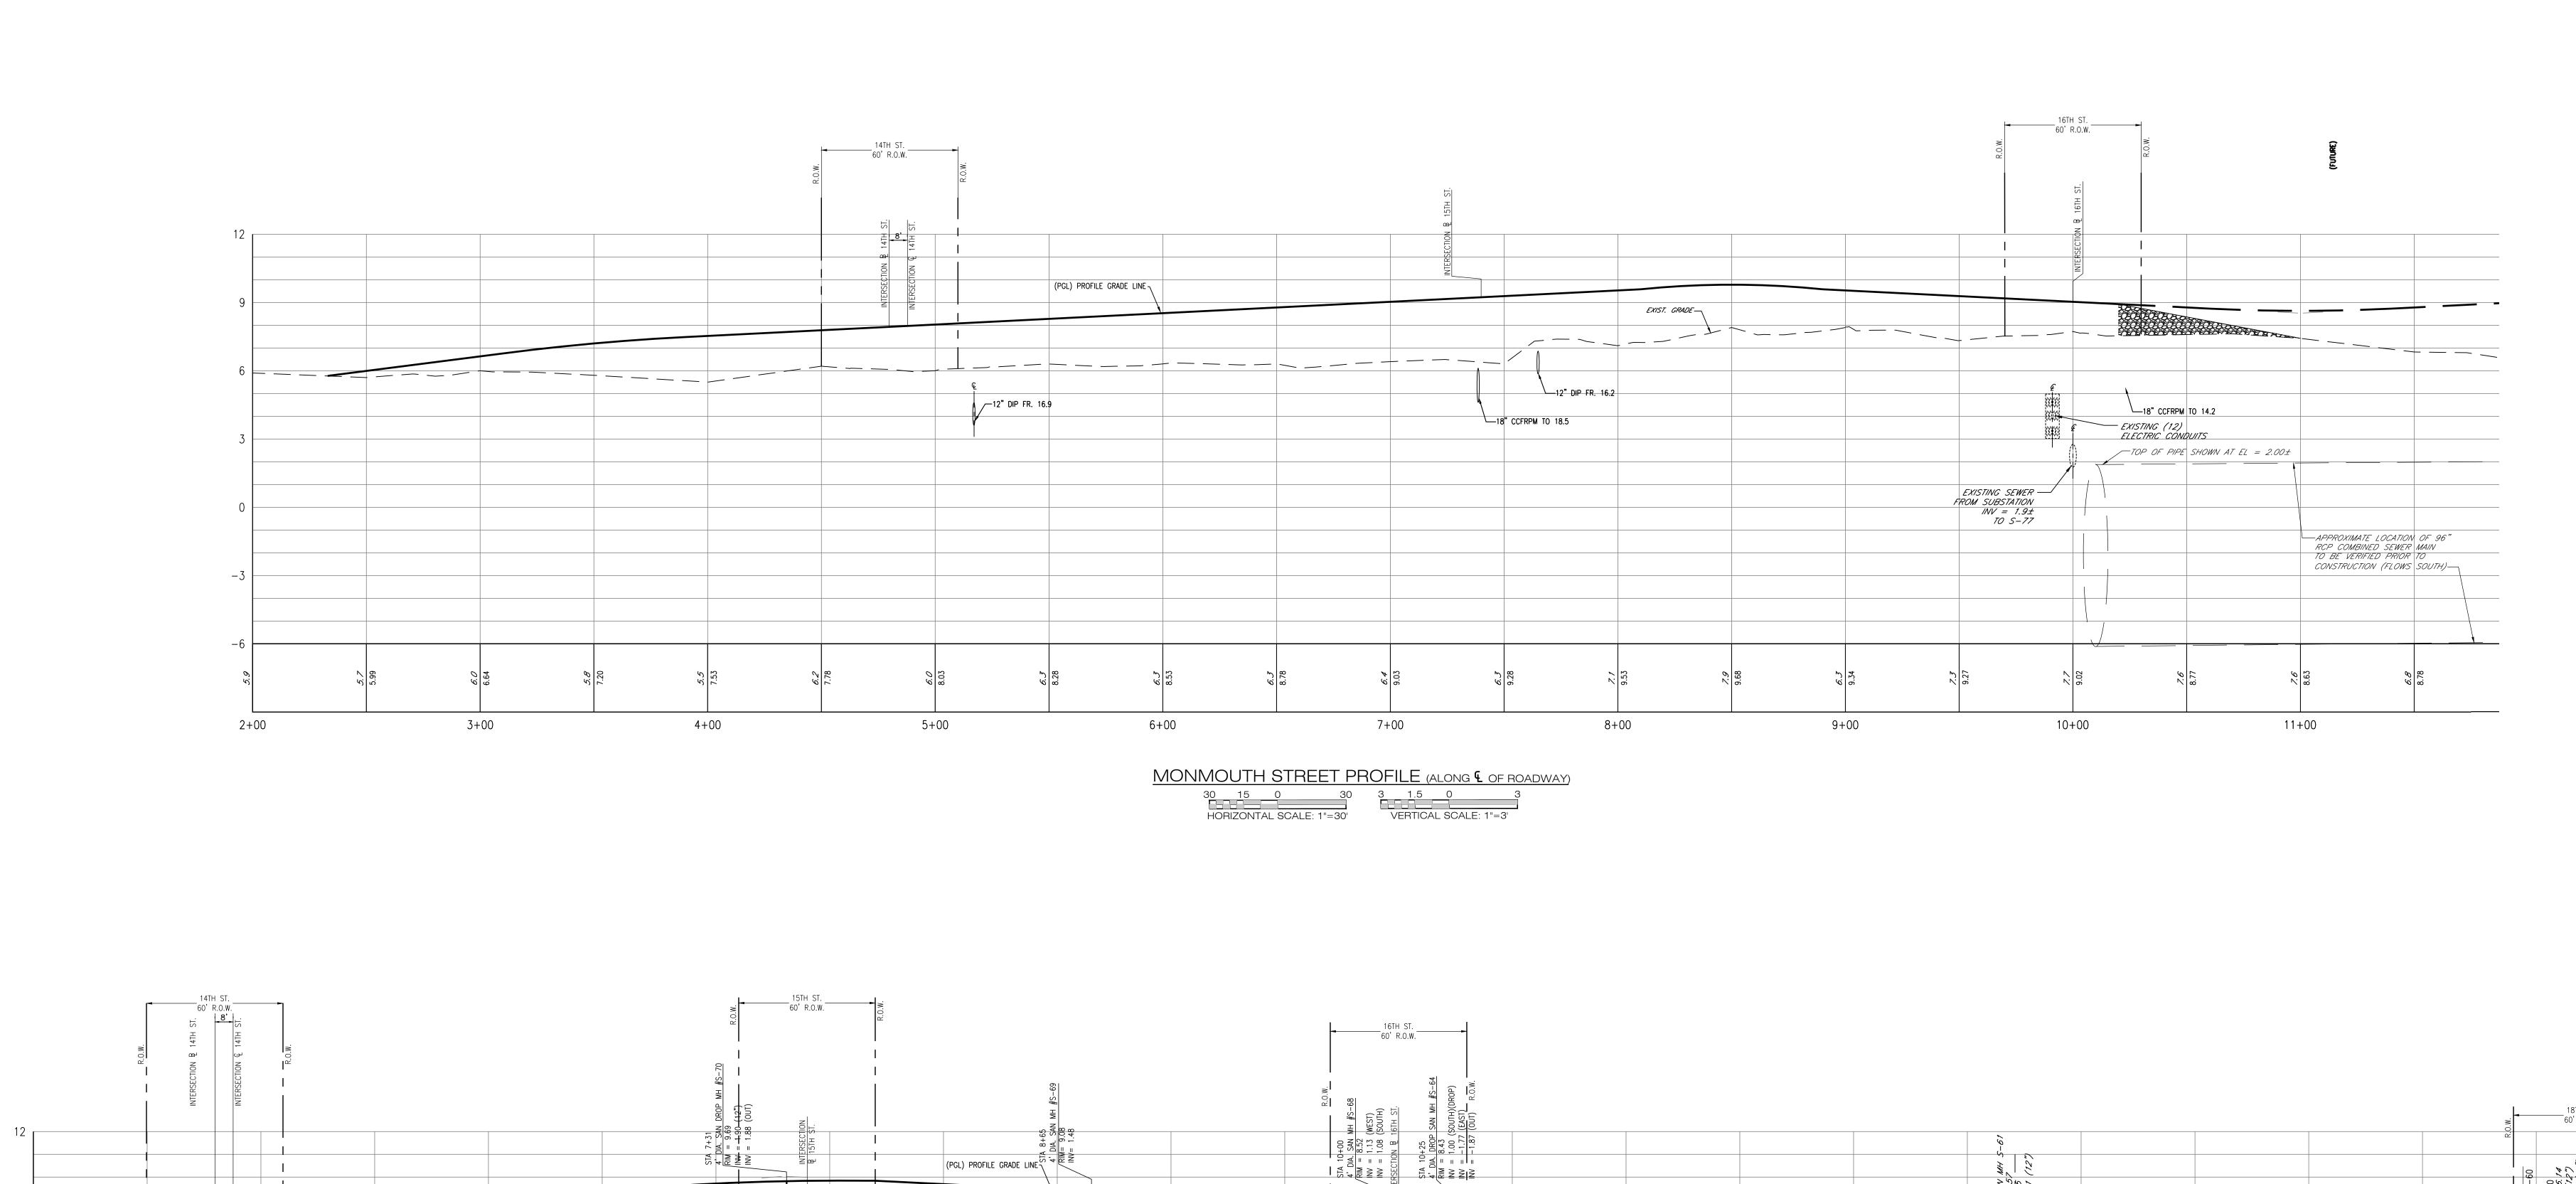

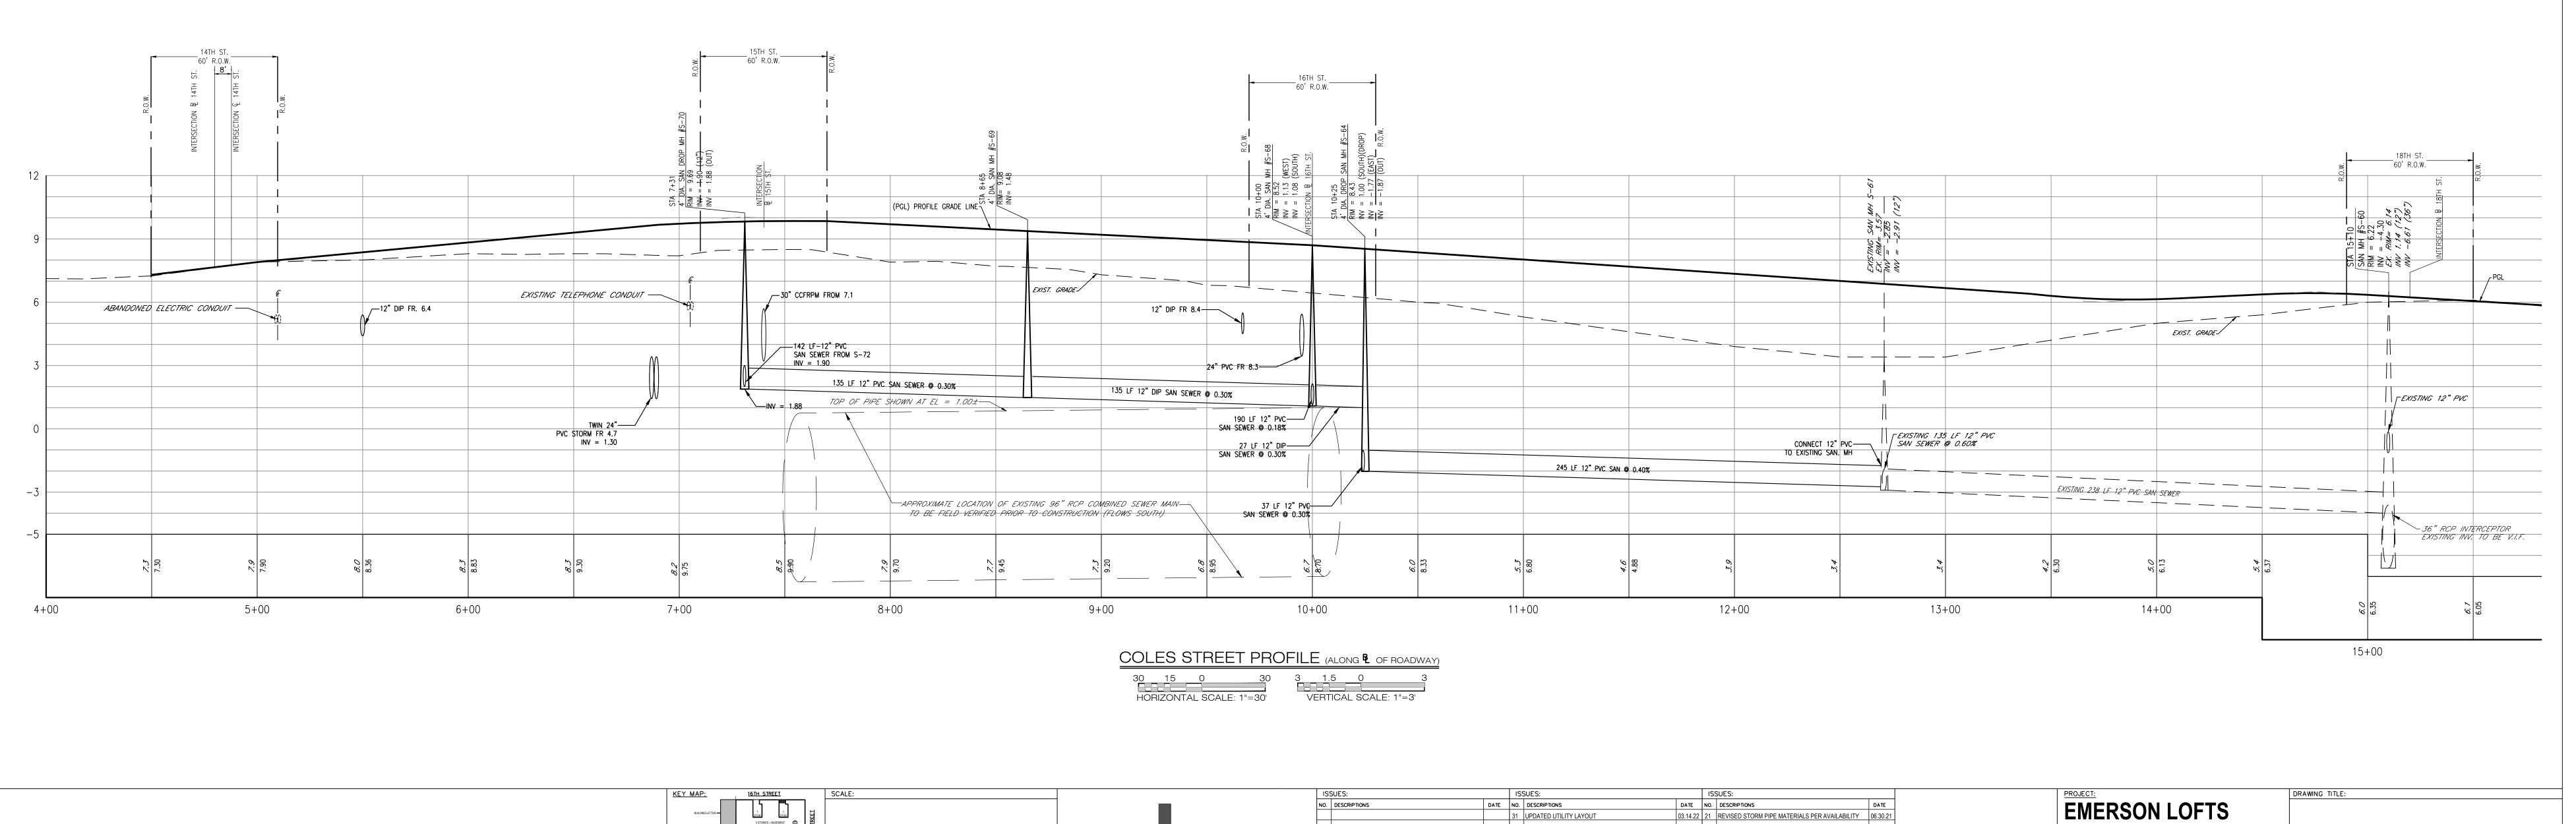

300 Coles Street, Suite 2 | Jersey City, New Jersey 07310 | T 201.656.0314 Certificate of Authorization # 24GA28287900

AS SHOWN

CHECKED BY:

JDR

(NOT PART OF APPLICATION -PRIOR APPROVAL OBTAINED)

SCALE: $1" = 300' \frac{1}{14TH STREET}$

DRAWN BY:

DATE NO. DESCRIPTIONS

31 UPDATED UTILITY LAYOUT

32 EMERSON PHASE III - RED LINE

33 UPDATED GROUND FLOOR BUILDING LAYOUT

35 EMERSON COMPLEX - LIGHTING PLAN UPDATE

34 EMERSON PHASE II - BUILDING PERMIT SUBMISSION 07.12.22 24 ADDED CONCRETE ADA RAMPS

04.26.22 22 UPDATED PHASE II PER ARCHATECTS

12.05.22 25 UPDATED LIGHTING

35	EMERSON COMPLEX - LIGHTING PLAN UPDATE	12.03.22	25	OPDATED LIGHTING	11.03.21
36	PHASE III - GAS & TELECOM LATERAL UPDATE	03.13.23	26	PH III - BUILDING PERMIT	11.18.21
37	PHASE III - REDLINE UPDATE	04.26.23	27	PH II CRANE - UPDATE	01.04.22
38	PHASE III - REDLINE UPDATE	07.17.23	28	REVISED 14TH STREET	01.05.22
39	PHASE II - ENTRANCE STAIR ELEVATION UPDATE	08.29.23	29	REVISED 14TH ST SOUTH CURB PER AS-BUILT COND.	01.28.22
40	PHASE III - SITE PLAN AMENDMENT SUBMISSION	09.18.23	30	REVISED PH II GRADES	01.28.22

05.14.22 23 REVISED BUMPOUT WIDTH AT 15TH STREE

UTILITY PROFILES 2

PHASE III

LOTS 3.04

255-259 COLES STREET,


JERSEY CITY, HUDSON COUNTY, NJ.


Proposition of the street of the

BLOCK 6903,

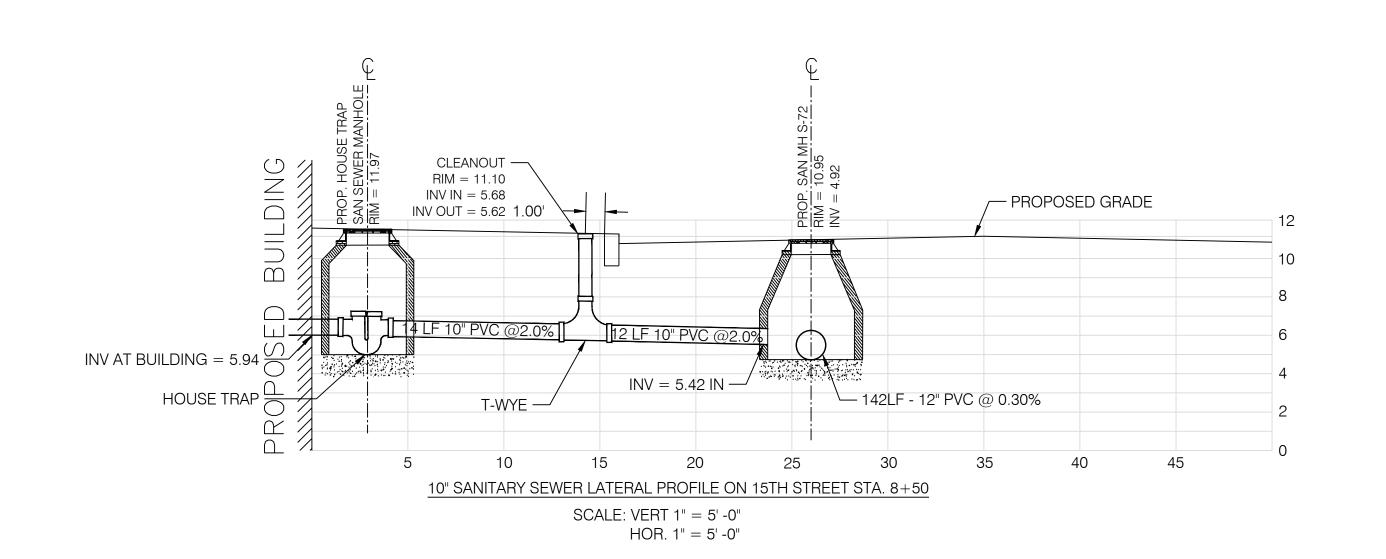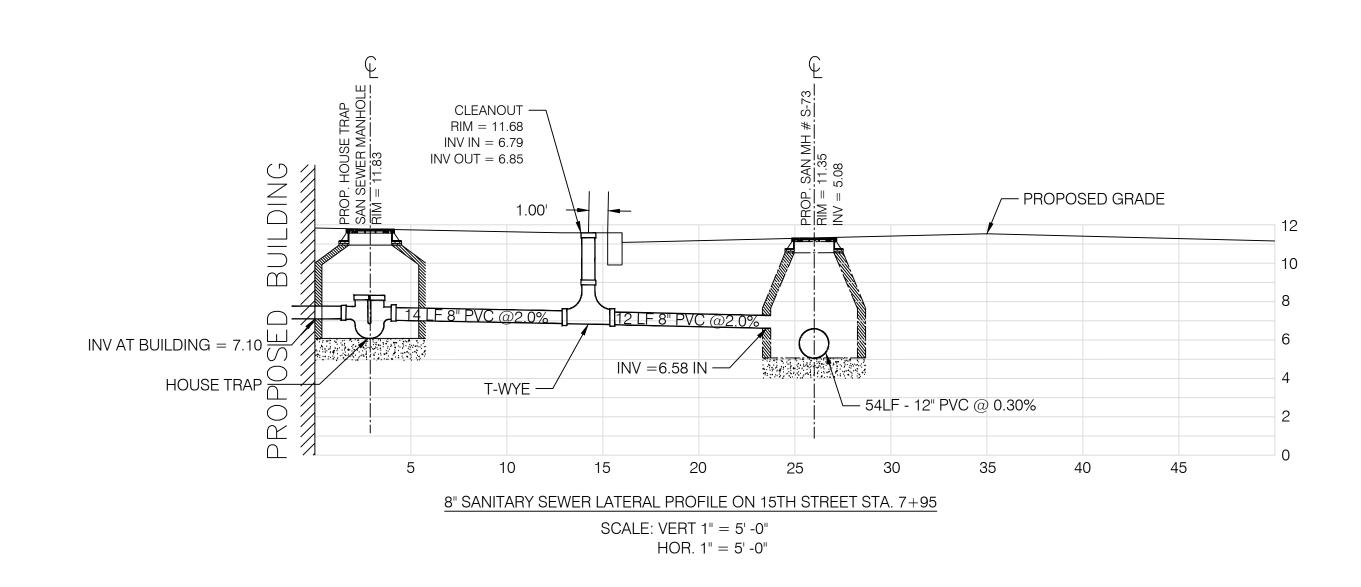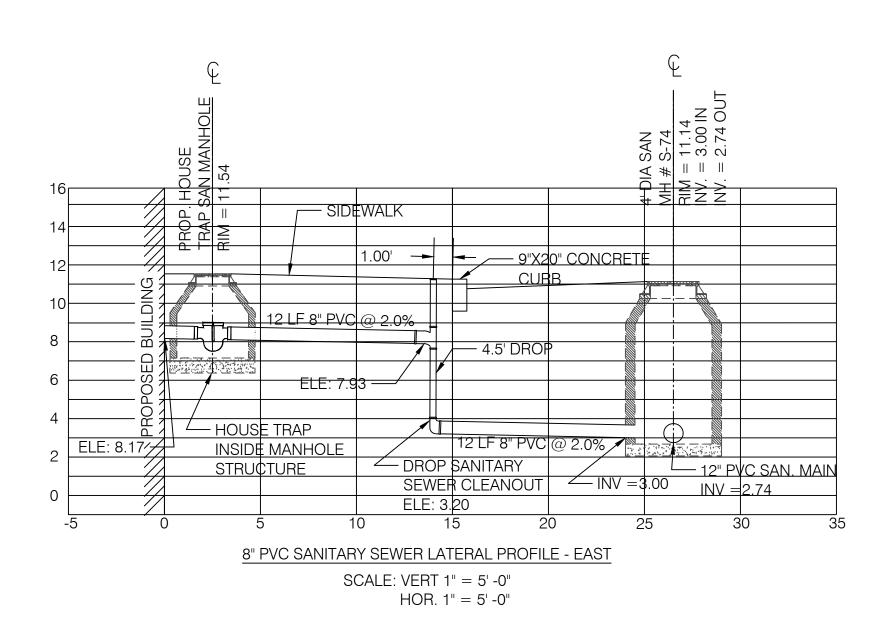
LOTS 3.04

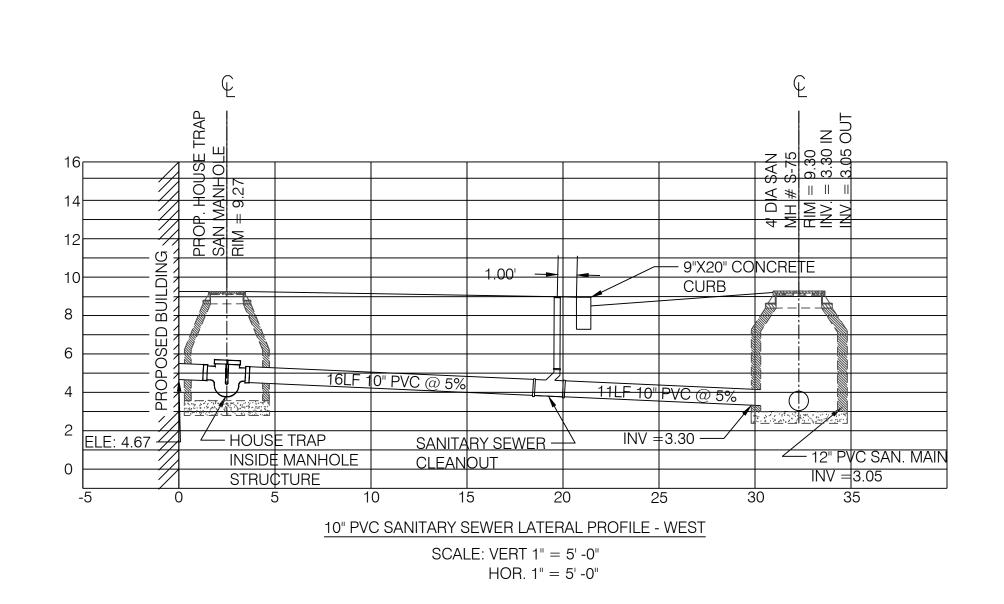
JEFFREY D. REEVES
PROFESSIONAL ENGINEER
N.J. LICENSE NUMBER 24GEO4036700
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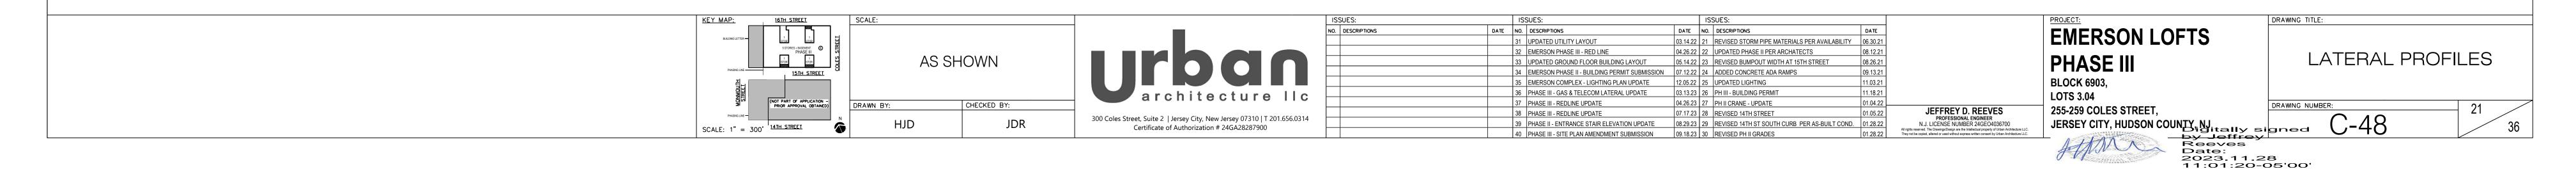



EMERSON BUILDING COMPLEX PHASE I LATERAL PROFILES







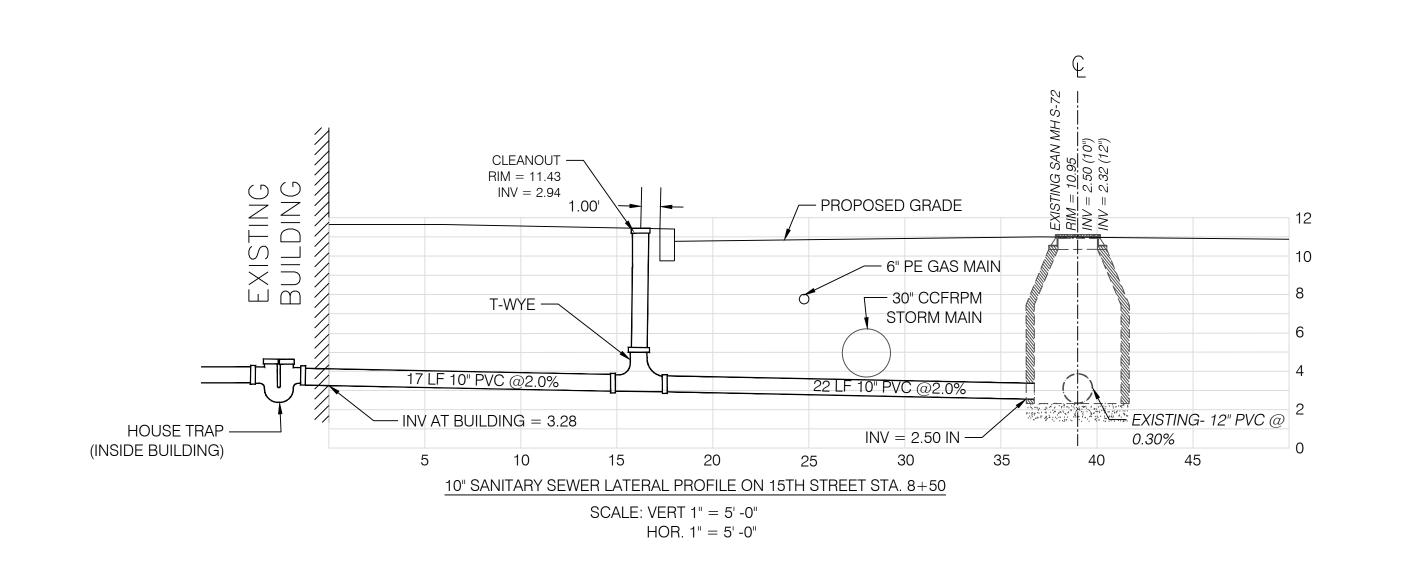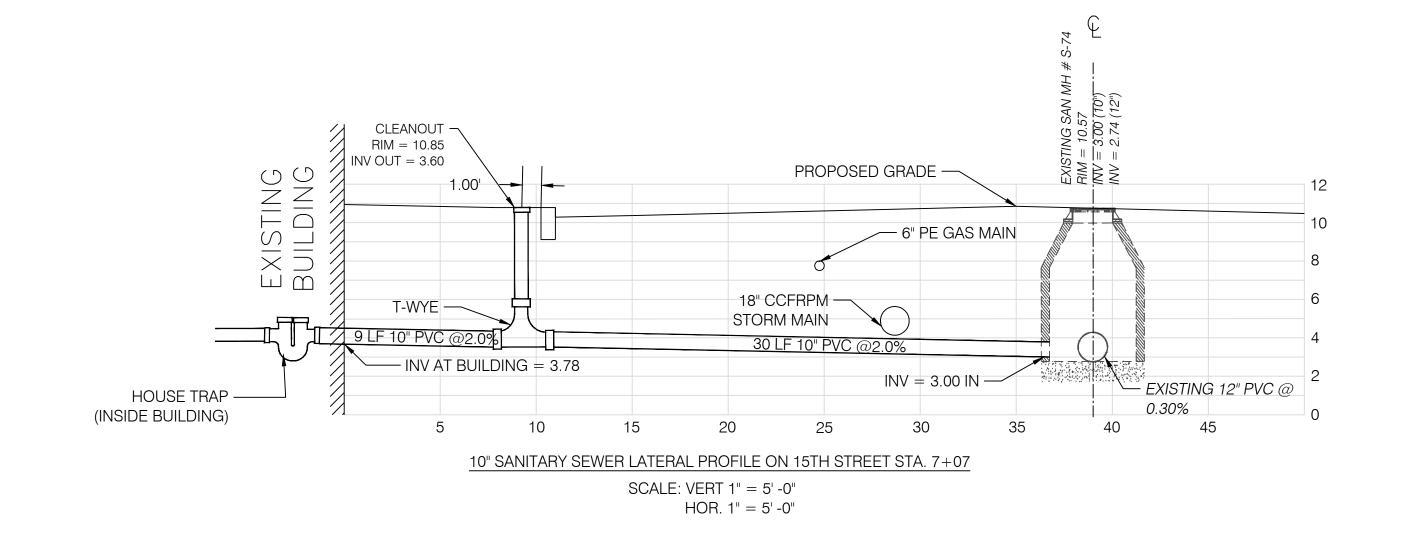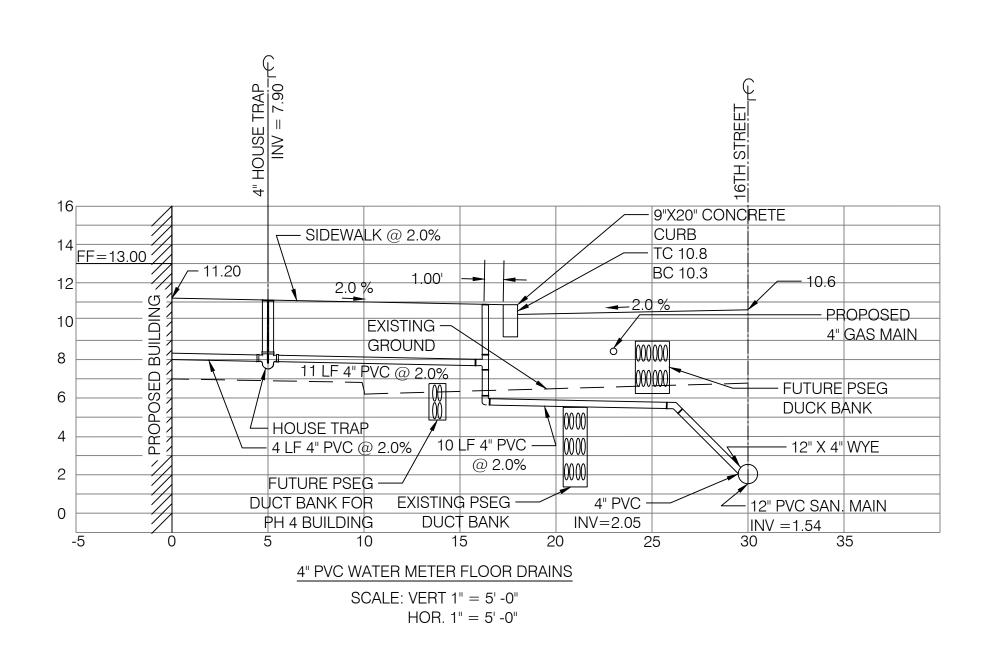EMERSON BUILDING COMPLEX PHASE II LATERAL PROFILES












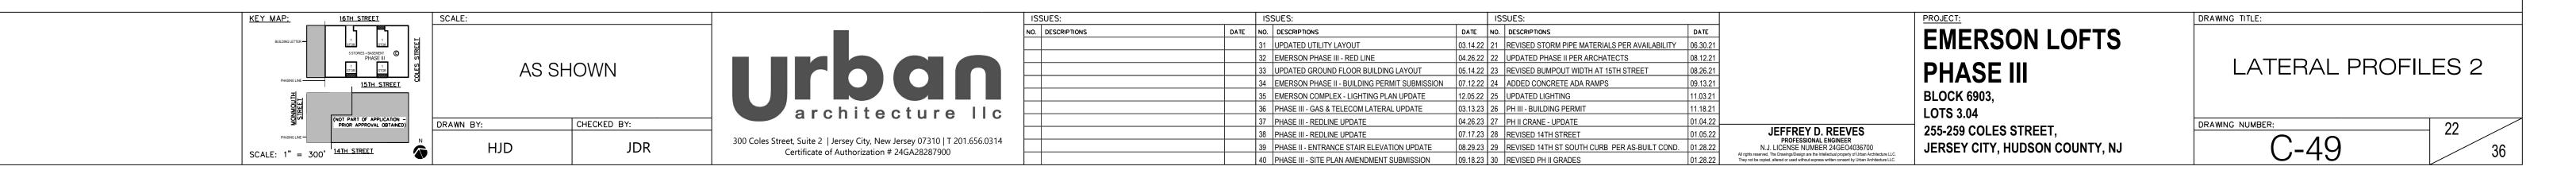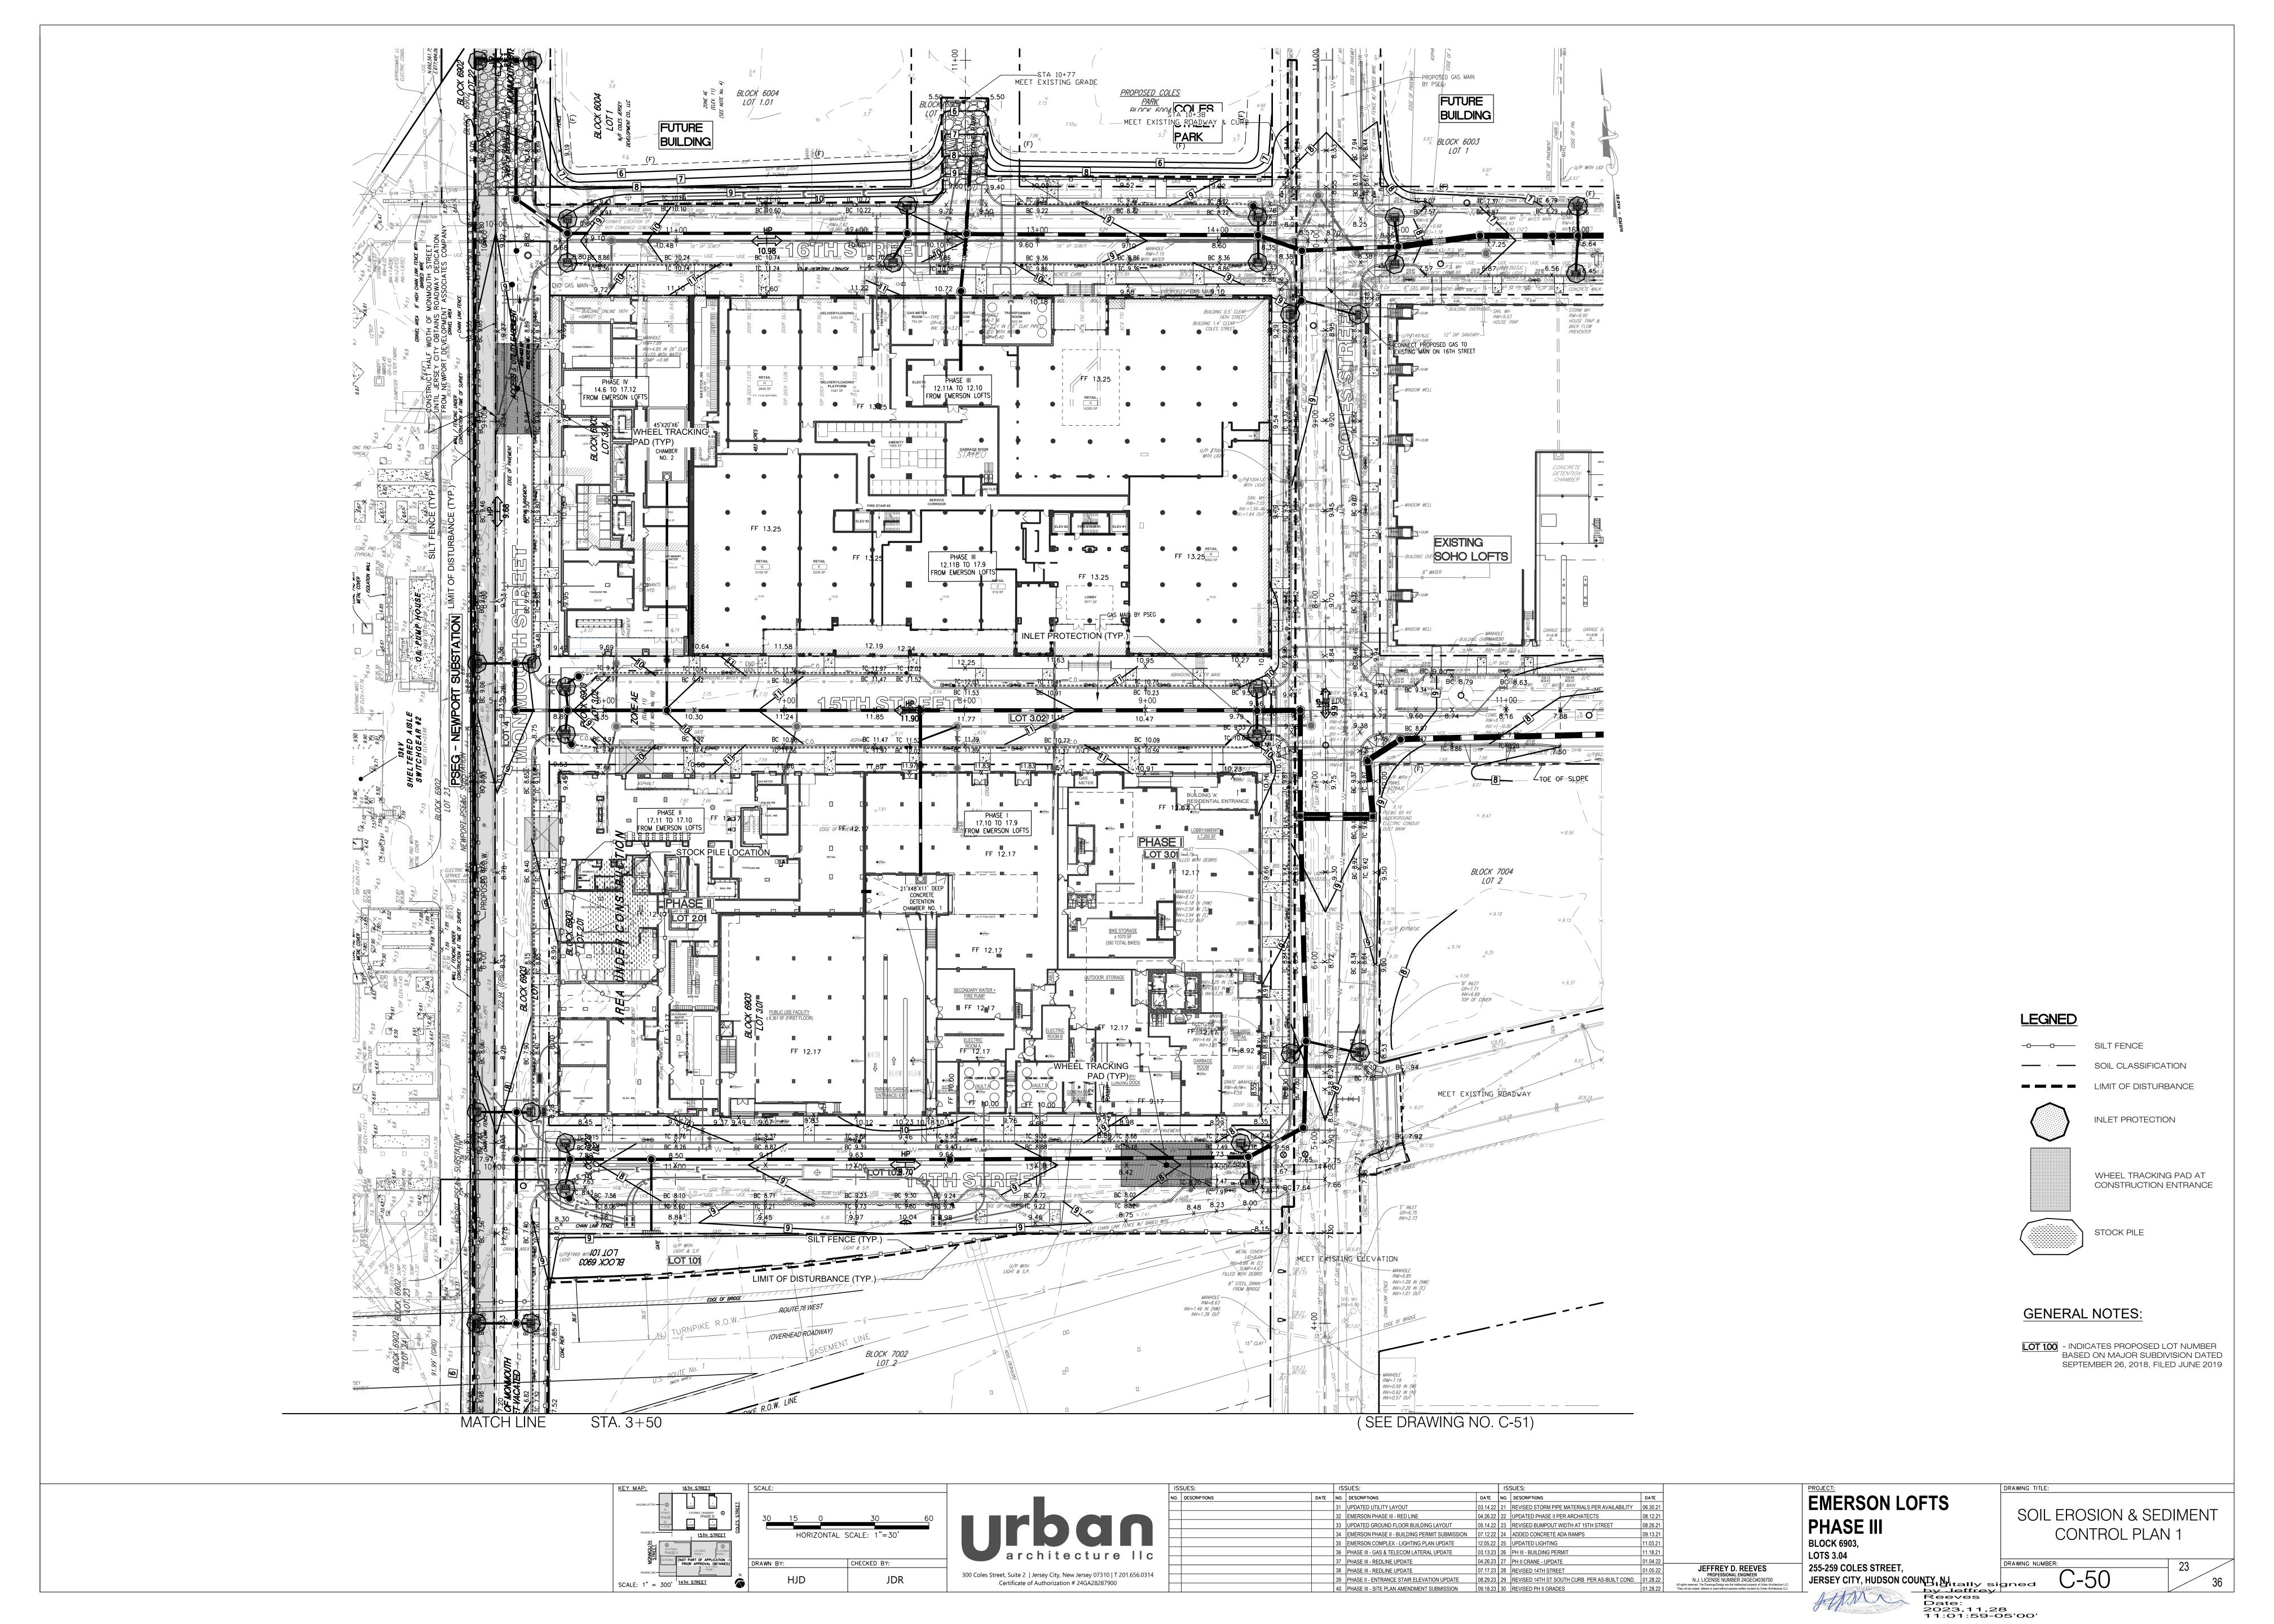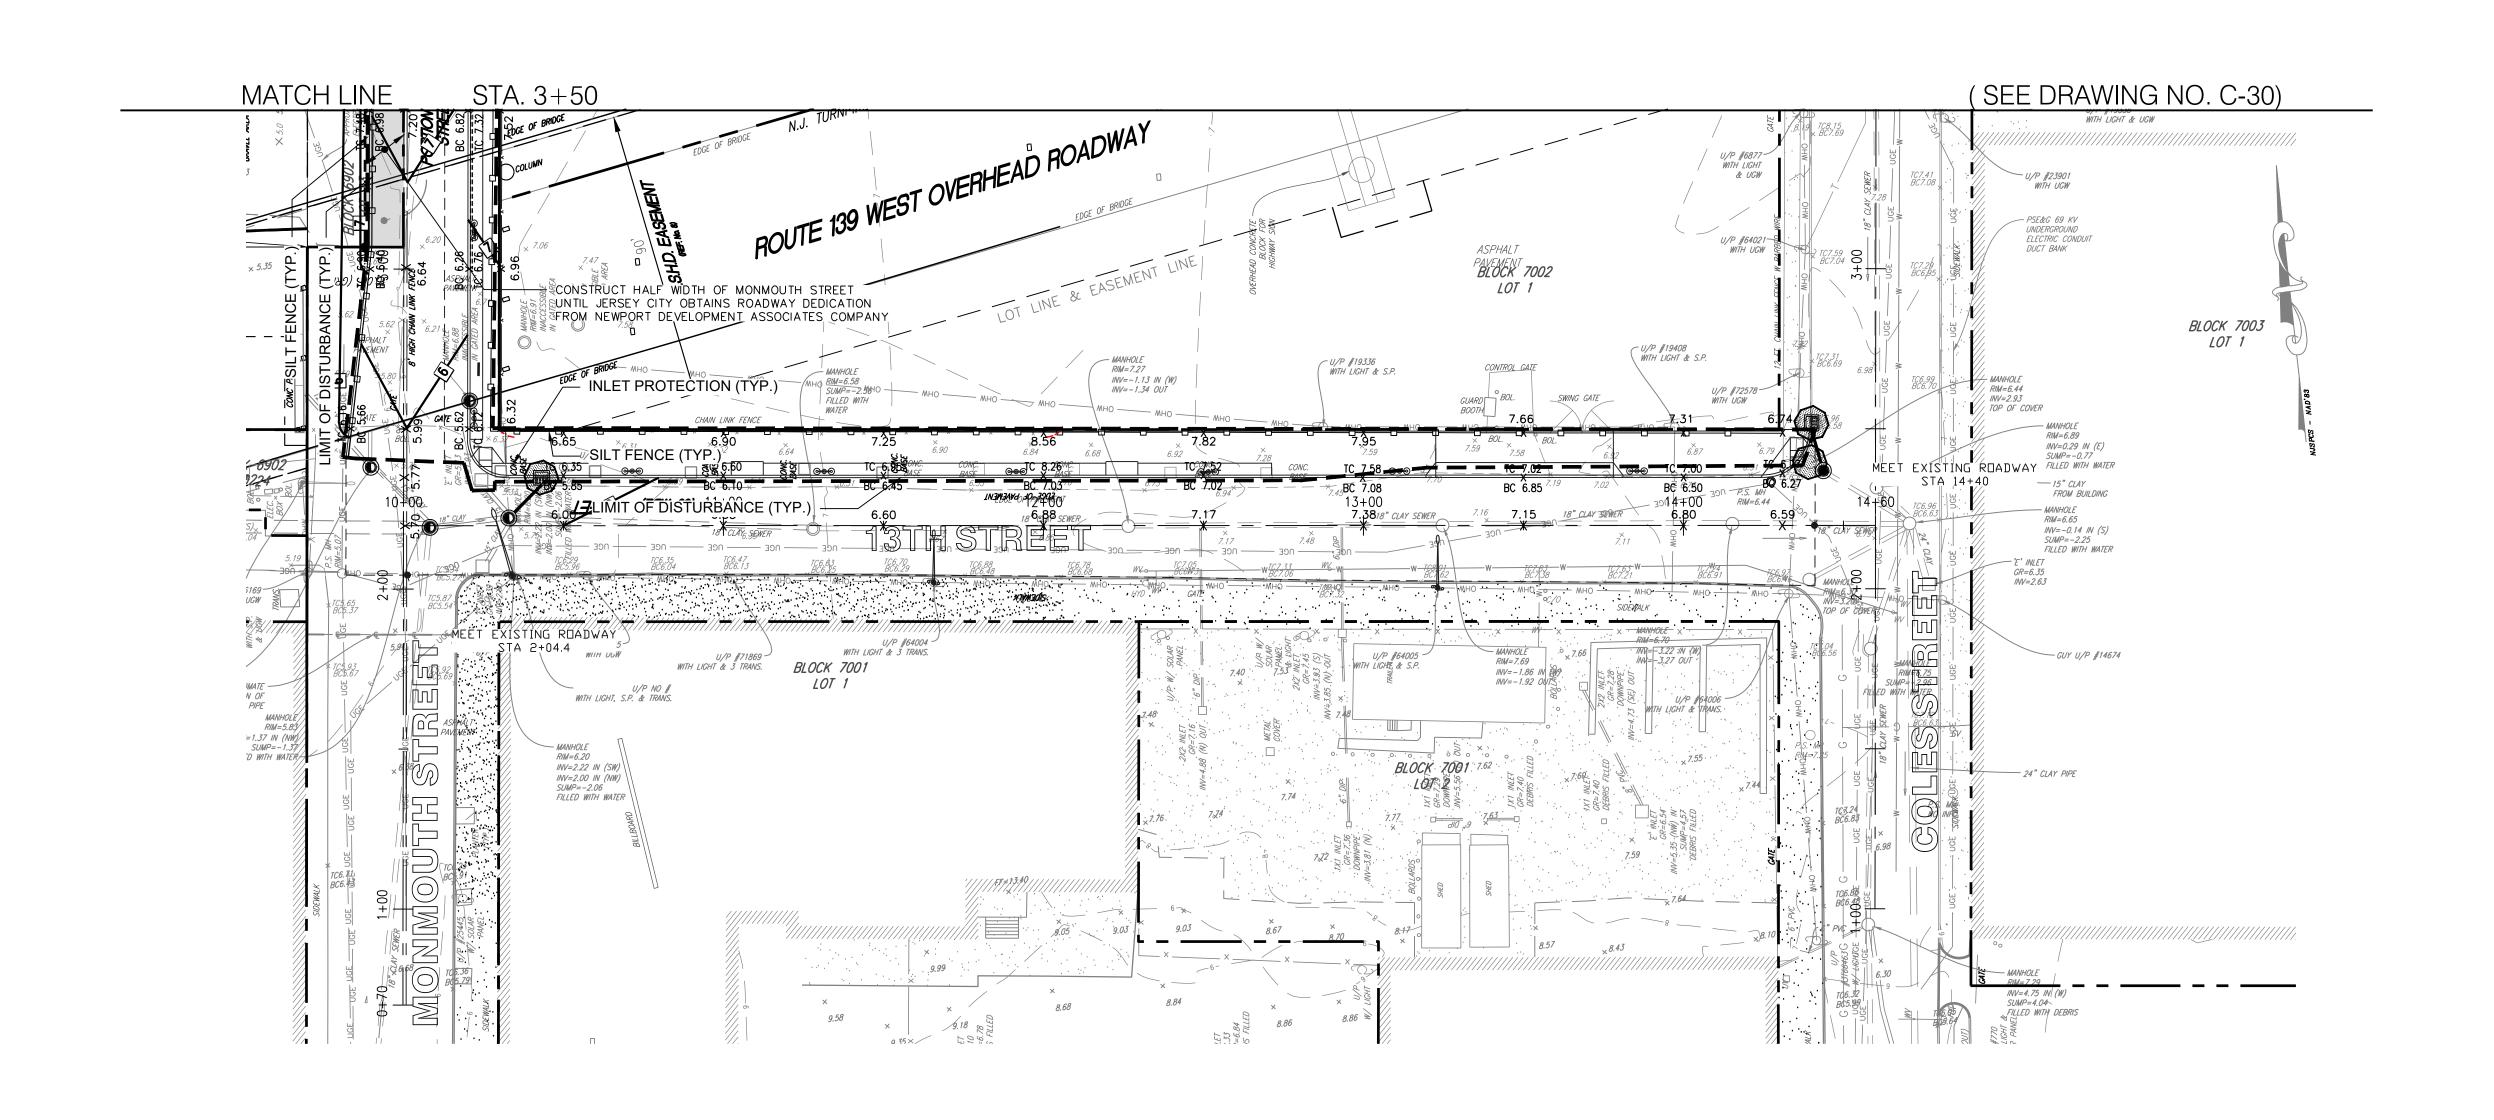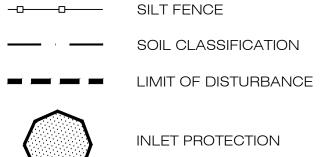
EMERSON BUILDING COMPLEX PHASE III
LATERAL PROFILES

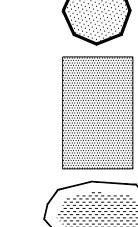













DRAWING TITLE:

WHEEL TRACKING PAD AT CONSTRUCTION ENTRANCE

GENERAL NOTES:

LOT 1.00 - INDICATES PROPOSED LOT NUMBER BASED ON MAJOR SUBDIVISION DATED SEPTEMBER 26, 2018, FILED JUNE 2019

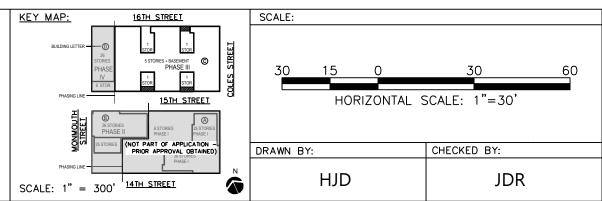STOCK PILE




300 Coles Street, Suite 2 | Jersey City, New Jersey 07310 | T 201.656.0314 Certificate of Authorization # 24GA28287900


IS:	SUES:		IS	SUES:		153	SUES:		
Ю.	DESCRIPTIONS	DATE	NO.	DESCRIPTIONS	DATE	NO.	DESCRIPTIONS	DATE	
			31	UPDATED UTILITY LAYOUT	03.14.22	21	REVISED STORM PIPE MATERIALS PER AVAILABILITY	06.30.21	
			32	EMERSON PHASE III - RED LINE	04.26.22	22	UPDATED PHASE II PER ARCHATECTS	08.12.21	
			33	UPDATED GROUND FLOOR BUILDING LAYOUT	05.14.22	23	REVISED BUMPOUT WIDTH AT 15TH STREET	08.26.21	
			34	EMERSON PHASE II - BUILDING PERMIT SUBMISSION	07.12.22	24	ADDED CONCRETE ADA RAMPS	09.13.21	
			35	EMERSON COMPLEX - LIGHTING PLAN UPDATE	12.05.22	25	UPDATED LIGHTING	11.03.21	
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			38	PHASE III - REDLINE UPDATE	07.17.23	28	REVISED 14TH STREET	01.05.22	JEFFREY D. REEVES PROFESSIONAL ENGINEER
			39	PHASE II - ENTRANCE STAIR ELEVATION UPDATE	08.29.23	29	REVISED 14TH ST SOUTH CURB PER AS-BUILT COND.	01.28.22	N.J. LICENSE NUMBER 24GEO4036700
			40	PHASE III - SITE PLAN AMENDMENT SUBMISSION	09.18.23	30	REVISED PH II GRADES	01.28.22	All rights reserved. The Drawings/Design are the Intellectual property of Urban Architecture LLC They not be copied, altered or used without express written consent by Urban Architecture LLC

EMERSON LOFTS PHASE III BLOCK 6903, LOTS 3.04 255-259 COLES STREET, JERSEY CITY, HUDSON COUNTY, NJ
Digitally signed
by Jeffrey
Reeves
Date:
2023.11.28
11:02:16-05'00'

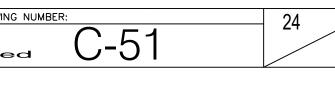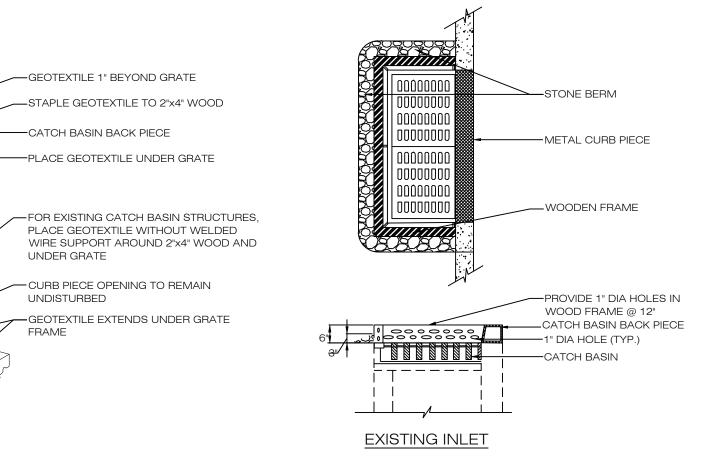SOIL EROSION & SEDIMENT CONTROL PLAN 2







NTS

NTS

NTS

NTS

NTS

1 INLET PROTECTION

—GEOTEXTILE 1" BEYOND GRATE

—CATCH BASIN BACK PIECE

UNDER GRATE

UNDISTURBED

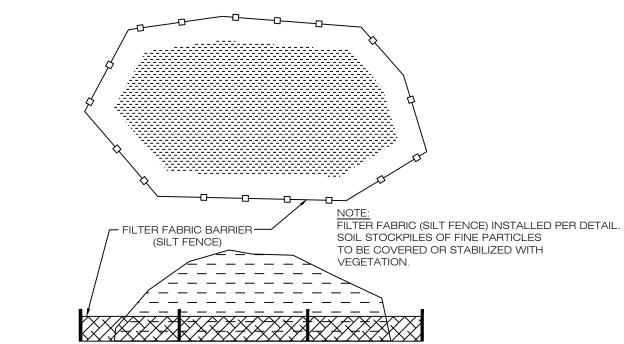
PLACE GEOTEXTILE UNDER GRATE

— CURB PIECE OPENING TO REMAIN


STAPLE GEOTEXTILE TO 2"x4" WOOD

6" MIN. CRUSHED STONE 1. PROVIDE APPROPRIATE TRANSITION BETWEEN STABILIZED ENTRANCE AND PUBLIC R.O.W. 2. "ACCESS PAD" SHALL BE COMPOSED OF 2-1/2 INCH CRUSHED STONE. VEHICLE WHEEL CLEANING BLANKET WILL BE INSTALLED WHEREVER A CONSTRUCTION ACCESS ROAD INTERSECTS ANY PAVED ROADWAY. SAID BLANKET WILL BE COMPOSED OF 1"-2" CRUSHED STONE, 6" THICK MIN, WILL BE AT LEAST 24'x50' AND SHOULD BE UNDERLAIN WITH A SUITABLE SYNTHETIC SEDIMENT FILTER FABRIC AND MAINTAINED. PUBLIC RIGHT OF WAY PERCENT SLOPE LENGTH OF STONE REQUIRED
OF ROADWAY COARSE GRAINED SOILS FINE GRAINED SOILS ENTIRE SURFACE STABILIZED WITH FABC BASE COURSE


CONSTRUCTION ENTRANCE



STOCKPILE PROTECTION

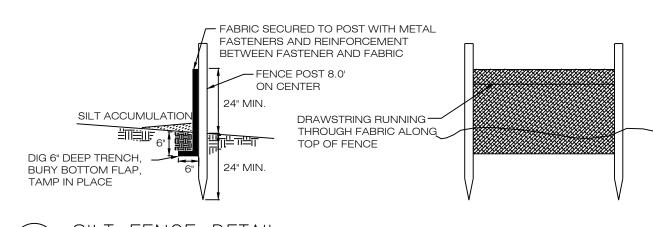

4 SILT FENCE DETAIL

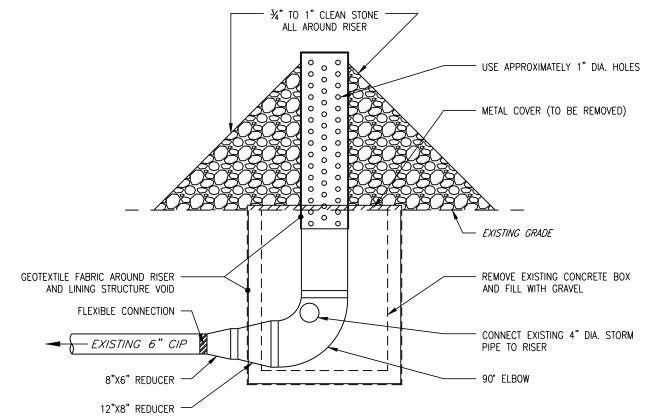

5 SEDIMENT RISER DETAIL

2017 HUDSON ESSEX PASSAIC SOIL CONSERVATION DISTRICT SOIL EROSION & SEDIMENT CONTROL NOTES 1. ALL SOIL EROSION AND SEDIMENT CONTROL PRACTICES ON THIS PLAN WILL BE CONSTRUCTED IN ACCORDANCE WITH THE "NEW JERSEY STANDARDS FOR SOIL EROSION AND SEDIMENT CONTROL" 7TH EDITION LAST REVISED DECEMBER 2017. THESE MEASURES WILL BE INSTALLED PRIOR TO ANY MAJOR SOIL DISTURBANCE OR IN THEIR PROPER SEQUENCE AND MAINTAINED UNTIL PERMANENT PROTECTION IS ESTABLISHED.

2. ALL SOIL TO BE EXPOSED OR STOCKPILED FOR A PERIOD OF GREATER THAN 14 DAYS, AND NOT UNDER ACTIVE CONSTRUCTION, WILL BE TEMPORARILY SEEDED AND HAY MULCHED OR OTHERWISE PROVIDED WITH VEGETATIVE COVER. THIS TEMPORARY COVER SHALL BE MAINTAINED UNTIL SUCH TIME WHEREBY PERMANENT RESTABILIZATION IS ESTABLISHED.

SEEDING DATES: THE FOLLOWING SEEDING DATES ARE RECOMMENDED TO BEST ESTABLISH PERMANENT VEGETATIVE COVER WITHIN MOST LOCATIONS IN THE HEPSCD: SPRING - 3/1-5/15 AND FALL - 8/15 - 10/1

4. SEDIMENT FENCES ARE TO BE PROPERLY TRENCHED AND MAINTAINED UNTIL PERMANENT VEGETATIVE COVER IS ESTABLISHED

5. ALL STORM DRAINAGE INLETS SHALL BE PROTECTED BY ONE OF THE PRACTICES ACCEPTED IN THE STANDARDS, AND PROTECTION SHALL REMAIN UNTIL PERMANENT STABILIZATION HAS BEEN ESTABLISHED. STORM DRAINAGE OUTLET POINTS SHALL BE PROTECTED AS REQUIRED BEFORE THEY BECOME FUNCTIONAL.

6. MULCH MATERIALS SHALL BE UN-ROTTED SMALL GRAIN STRAW APPLIED AT THE RATE OF 70 TO 90 POUNDS PER 1,000 SQUARE FEET AND ANCHORED WITH A MULCH ANCHORING TOOL, LIQUID MULCH BINDERS, OR NETTING TIE DOWN. OTHER SUITABLE MATERIALS MAY BE USED IF APPROVED BY THE SOIL CONSERVATION DISTRICT.

7. ALL EROSION CONTROL DEVICES SHALL BE PERIODICALLY INSPECTED, MAINTAINED AND CORRECTED BY THE CONTRACTOR. ANY DAMAGE INCURRED BY EROSION SHALL BE RECTIFIED IMMEDIATELY.

8. THE HUDSON-ESSEX-PASSAIC SOIL CONSERVATION DISTRICT WILL BE NOTIFIED IN WRITING AT LEAST 48 HOURS PRIOR TO ANY SOIL DISTURBING ACTIVITIES. FAX - (862) 333-4507 OR EMAIL -INFORMATION@HEPSCD.ORG

9. THE APPLICANT MUST OBTAIN A DISTRICT ISSUED REPORT-OF-COMPLIANCE PRIOR TO APPLYING FOR THE CERTIFICATE OF OCCUPANCY OR TEMPORARY CERTIFICATE OF OCCUPANCY FROM THE RESPECTIVE MUNICIPALITY, NJ - DCA OR ANY OTHER CONTROLLING AGENCY. CONTACT THE DISTRICT AT 862-333-4505 TO REQUEST A FINAL INSPECTION, GIVING ADVANCED NOTICE UPON COMPLETION OF THE RESTABILIZATION MEASURES. A PERFORMANCE DEPOSIT MAY BE POSTED WITH THE DISTRICT WHEN WINTER WEATHER OR SNOW COVER PROHIBITS THE PROPER APPLICATION OF SEED, MULCH, FERTILIZER OR HYDRO-SEED.

10. PAVED ROADWAYS MUST BE KEPT CLEAN AT ALL TIMES. DO NOT UTILIZE A FIRE OR GARDEN HOSE TO CLEAN ROADS UNLESS THE RUNOFF IS DIRECTED TO A PROPERLY DESIGNED AND FUNCTIONING SEDIMENT BASIN. WATER PUMPED OUT OF THE EXCAVATED AREAS CONTAINS SEDIMENTS THAT MUST BE REMOVED PRIOR TO DISCHARGING TO RECEIVING BODIES OF WATER USING REMOVABLE PUMPING STATIONS, SUMP PITS, PORTABLE SEDIMENTATION TANKS AND/OR SILT CONTROL

11. ALL SURFACES HAVING LAWN OR LANDSCAPING AS FINAL COVER ARE TO BE PROVIDED TOPSOIL PRIOR TO RE-SEEDING, SODDING OR PLANTING. A DEPTH OF 5.0 INCHES, FIRMED IN PLACE, IS REQUIRED, AS PER THE STANDARDS FOR TOPSOILING AND LAND GRADING, LAST REVISED DECEMBER 2017.

12. ALL PLAN REVISIONS MUST BE SUBMITTED TO THE DISTRICT FOR PROPER REVIEW AND APPROVAL.

13. A CRUSHED STONE WHEEL CLEANING TRACKING-PAD IS TO BE INSTALLED AT ALL SITE EXITS USING 2 ½ -1" CRUSHED ANGULAR STONE (ASTM 2 OR 3) TO A MINIMUM LENGTH OF 50 FEET AND MINIMUM DEPTH OF 6". ALL DRIVEWAYS MUST BE PROVIDED WITH CRUSHED STONE UNTIL PAVING IS COMPLETE.

14. STEEP SLOPES INCURRING DISTURBANCE MAY REQUIRE ADDITIONAL STABILIZATION MEASURES. THESE "SPECIAL" MEASURES SHALL BE DESIGNED BY THE APPLICANT'S ENGINEER AND BE APPROVED BY THE SOIL CONSERVATION DISTRICT.

15. THE HUDSON-ESSEX-PASSAIC SOIL CONSERVATION DISTRICT SHALL BE NOTIFIED, IN WRITING, FOR THE SALE OF ANY PORTION OF THE PROJECT OR FOR THE SALE OF INDIVIDUAL LOTS. NEW OWNERS' INFORMATION SHALL BE PROVIDED. ADDITIONAL MEASURES DEEMED NECESSARY BY DISTRICT OFFICIALS SHALL BE IMPLEMENTED AS CONDITIONS WARRANT.

TEMPORARY STABILIZATION SPECIFICATIONS

- APPLY GROUND LIMESTONE AT A RATE OF 90 LBS./1,000 S.F. 2. APPLY FERTILIZER (10-20-10) AT A RATE OF 14LBS./1,000 S.F. AND WORK
- INTO SOIL 4" DEEP. APPLY SEED MIXTURE: PERENNIAL RYEGRASS AT 0.90 LBS./ACRE. 4. MULCH WITH UNROTTED SALT HAY OR SMALL GRAIN STRAW IMMEDIATELY AFTER SEEDING. APPLY AT A RATE OF 90 LBS./1,000 S.F. AND SECURE BY
- APPROVED METHODS (I.E PEG AND TWINE, MULCH NETTING OR LIQUID MULCH PLANT SEED BETWEEN MARCH 1 AND MAY 15 OR BETWEEN AUGUST 15 AND OCTOBER 1, IF POSSIBLE.

PERMANENT STABILIZATION SPECIFICATIONS

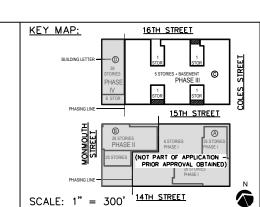
- 1. APPLY TOPSOIL TO A DEPTH OF 5 INCHES (UNSALTED) 2. APPLY GROUND LIMESTONE AT A RATE OF 90 LBS./1,000 S.F. AND WORK
- INTO SOIL 4" DEEP. 3. APPLY FERTILIZER (10-20-10) AT A RATE OF 11LBS./1,000 S.F. AND WORK
- INTO SOIL 4" DEEP.
- 4. APPLY SEED MIXTURE: HARD FESCUE SEED AT 2.7 LBS./1000 S.F. AND CREEPING RED FESCUE SEED AT 0.7 LBS./1000 S.F. AND PERENNIAL RYEGRASS SEED AT 0.25 LBS./1000 S.F. 5. MULCH WITH UNROTTED SALT HAY OR SMALL GRAIN STRAW IMMEDIATELY
- AFTER SEEDING. APPLY AT A RATE OF 90 LBS./1,000 S.F. AND SECURE BY APPROVED METHODS (I.E PEG AND TWINE, MULCH NETTING OR LIQUID MULCH 6. PLANT SEED BETWEEN MARCH 1 AND MAY 15 OR BETWEEN AUGUST 15 AND

SEQUENCE OF CONSTRUCTION

OCTOBER 1, IF POSSIBLE.

- 1. CONTACT THE HUDSON COUNTY SOIL CONSERVATION DISTRICT, IN WRITING, 48 HOURS PRIOR TO ANY LAND DISTURBANCE.
- 2. CONSTRUCT STABILIZED CONSTRUCTION ACCESS ROAD. 3. INSTALL SILT FENCE ALONG THE PROPERTY LINE
- 4. REMOVE EXISTING BITUMINOUS PAVEMENT.
- 5. CONSTRUCT FOUNDATION. 6. INSTALL UNDERGROUND UTILITIES.
- 7. INSTALL SOIL EROSION MEASURES. 8. ROUGH GRADE PROPOSED LANDSCAPE, WALKWAY AND ENTRY DRIVEWAY AND
- STABILIZE ALL CRITICAL AREAS IN ACCORDANCE WITH THE NJ STANDARDS. 9. CONSTRUCT BUILDING. 10. REMOVE AND RECONSTRUCT EXISTING SIDEWALK AND CONSTRUCT SIDEWALK
- EXTENSION.
- 11. REMOVE EXISTING FENCE.
- 12. INSTALL TOPSOIL ON ALL OF THE DISTURBED AREAS TO BE LANDSCAPED. 13. PERFORM FINAL GRADING AND INSTALL PERMANENT SEEDING AND MULCHING ON ALL DISTURBED AREAS. REMOVE THE SOIL EROSION MEASURES AND STABILIZE

DRAWING TITLE



AS SHOWN

CHECKED BY


JDR




ISSUES:		IS:	SUES:		IS:	SUES:		
NO. DESCRIPTIONS	DATE	NO.	DESCRIPTIONS	DATE	NO.	DESCRIPTIONS	DATE	
		31	UPDATED UTILITY LAYOUT	03.14.22	21	REVISED STORM PIPE MATERIALS PER AVAILABILITY	06.30.21	
		32	EMERSON PHASE III - RED LINE	04.26.22	22	UPDATED PHASE II PER ARCHATECTS	08.12.21	
		33	UPDATED GROUND FLOOR BUILDING LAYOUT	05.14.22	23	REVISED BUMPOUT WIDTH AT 15TH STREET	08.26.21	
		34	EMERSON PHASE II - BUILDING PERMIT SUBMISSION	07.12.22	24	ADDED CONCRETE ADA RAMPS	09.13.21	
		35	EMERSON COMPLEX - LIGHTING PLAN UPDATE	12.05.22	25	UPDATED LIGHTING	11.03.21	
		36	PHASE III - GAS & TELECOM LATERAL UPDATE	03.13.23	26	PH III - BUILDING PERMIT	11.18.21	
		37	PHASE III - REDLINE UPDATE	04.26.23	27	PH II CRANE - UPDATE	01.04.22	
		38	PHASE III - REDLINE UPDATE	07.17.23	28	REVISED 14TH STREET	01.05.22	JEFFREY D. REEVES
		39	PHASE II - ENTRANCE STAIR ELEVATION UPDATE	08.29.23	29	REVISED 14TH ST SOUTH CURB PER AS-BUILT COND.	01.28.22	PROFESSIONAL ENGINEER N.J. LICENSE NUMBER 24GEO4036700
		40	PHASE III - SITE PLAN AMENDMENT SUBMISSION	09.18.23	30	REVISED PH II GRADES	01.28.22	All rights reserved. The Drawings/Design are the Intellectual property of Urban Architecture They not be copied, altered or used without express written consent by Urban Architecture

EMERSON LOFTS PHASE III BLOCK 6903, LOTS 3.04 255-259 COLES STREET, JERSEY CITY, HUDSON COUNTY, NJ

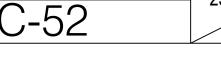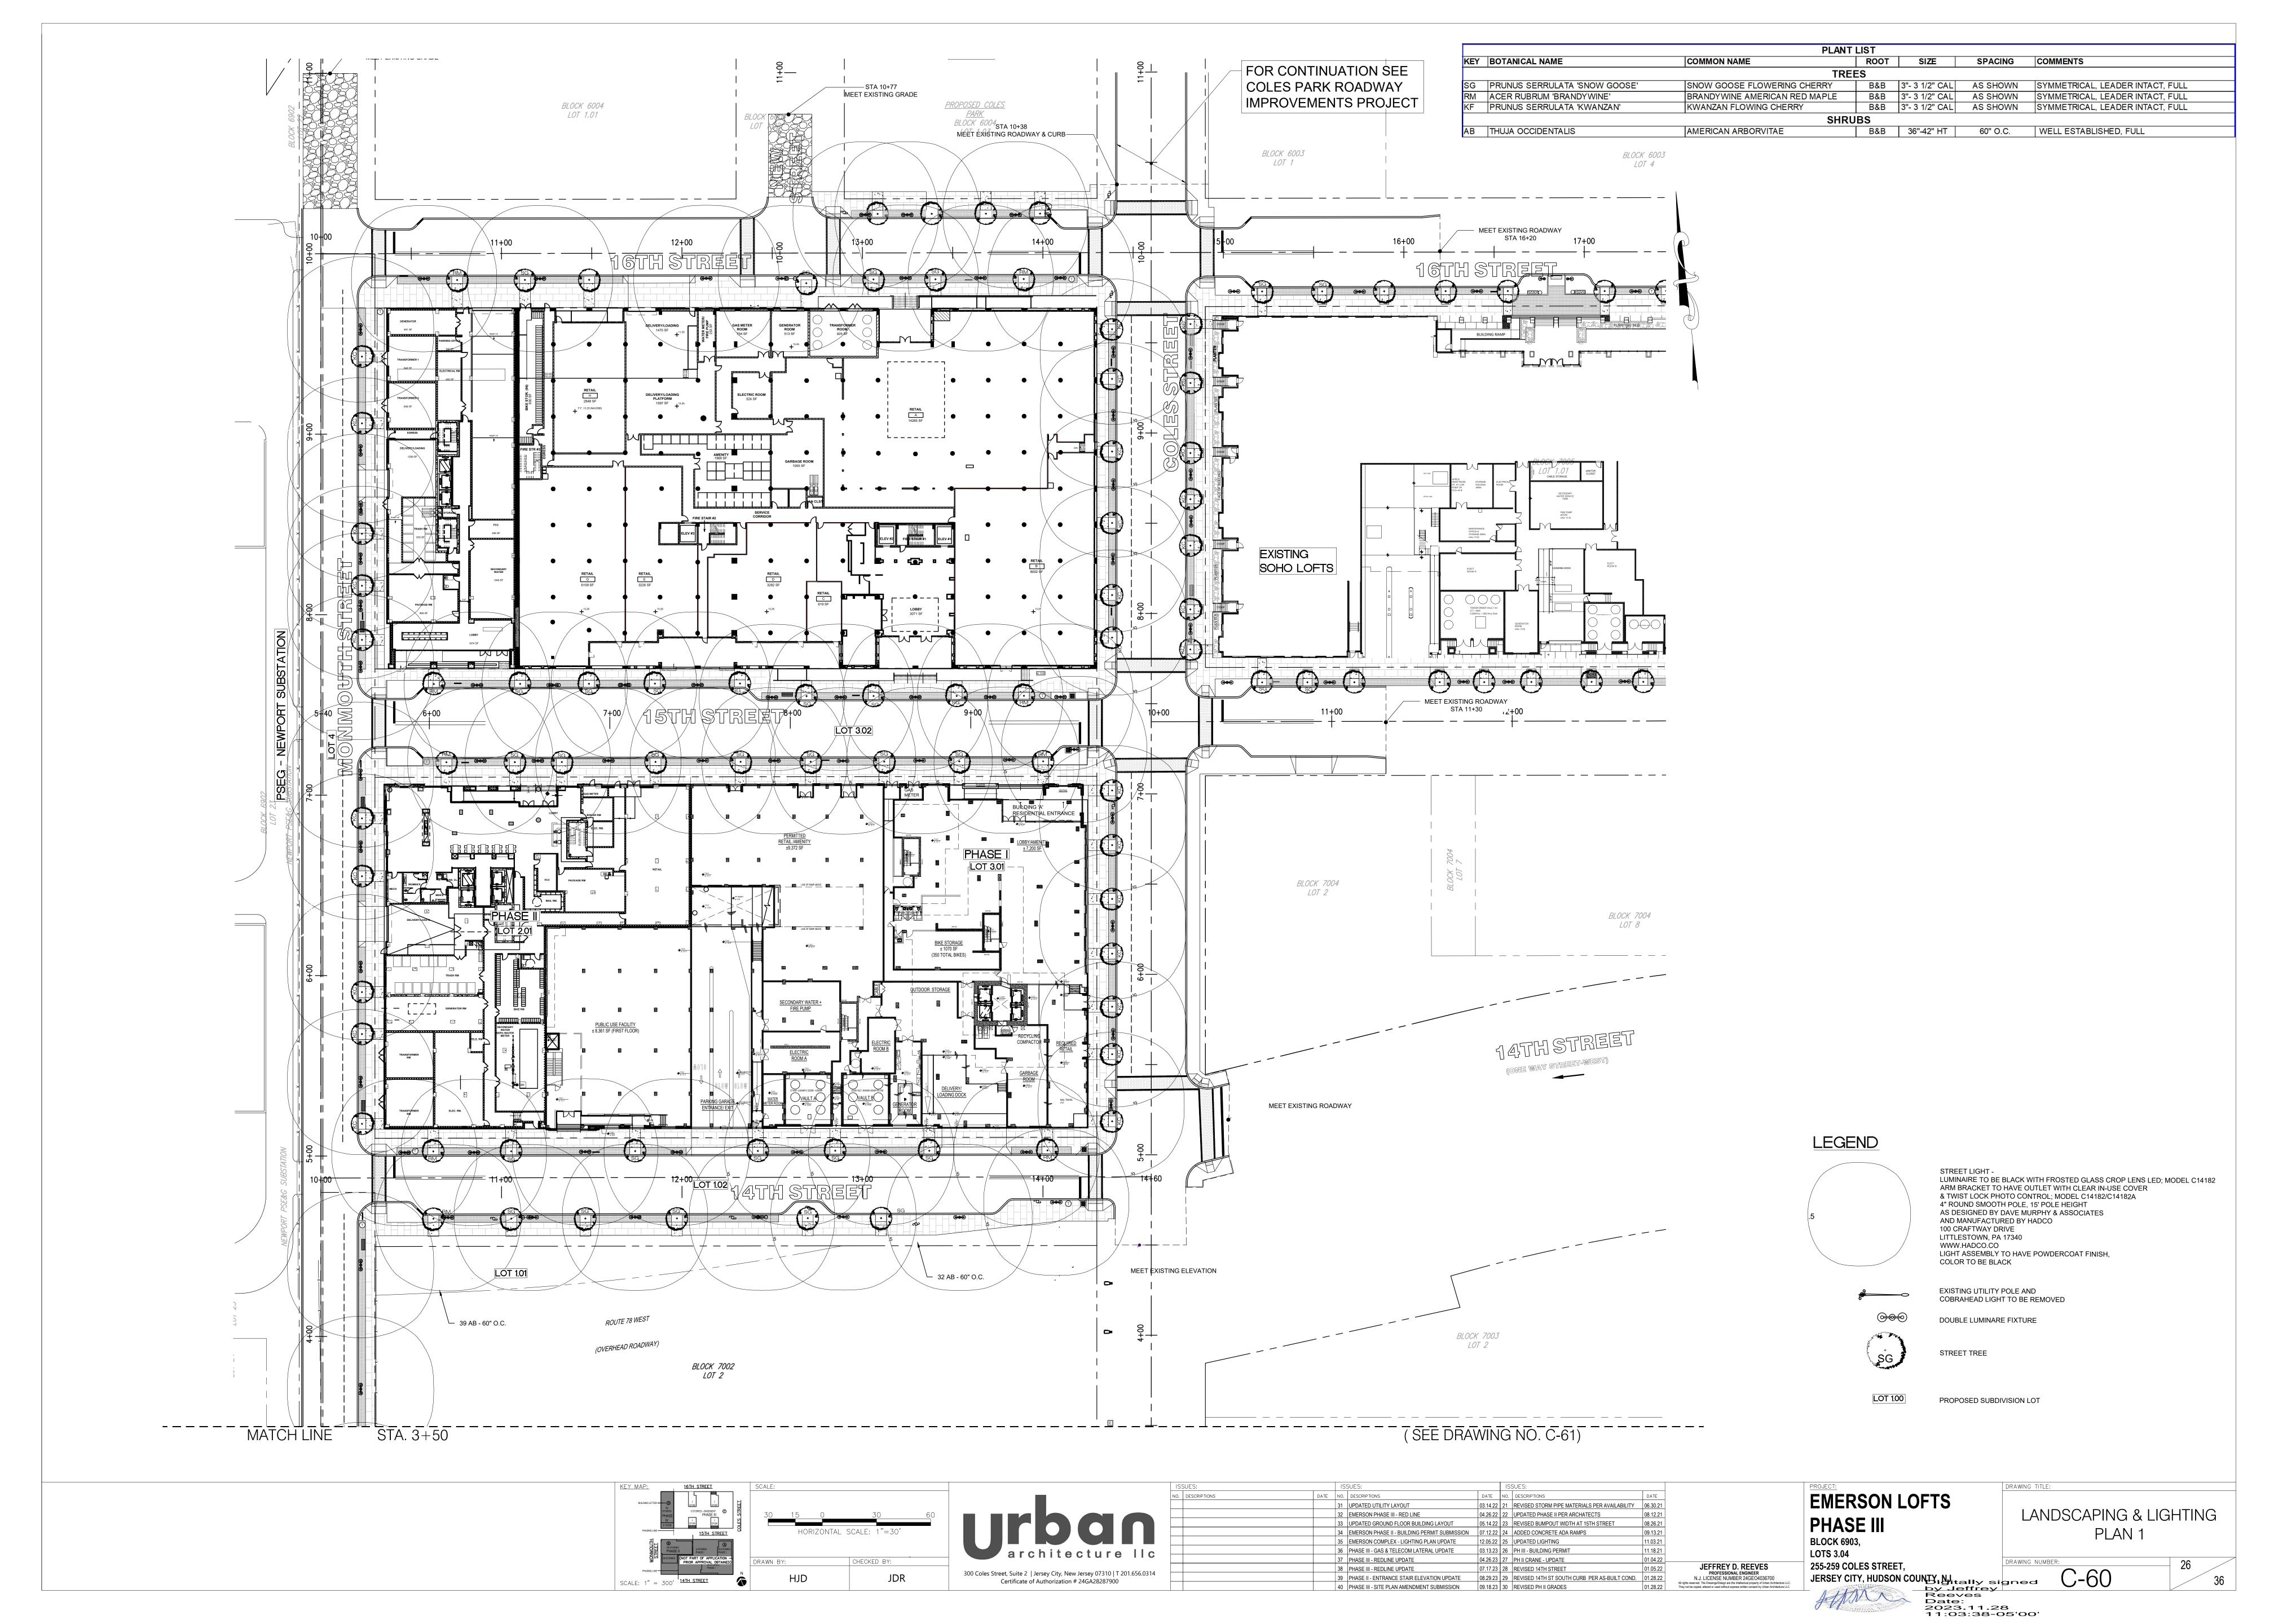
SOIL EROSION & SEDIMENT CONTROL DETAILS AND NOTES










		PLANT	LIST						
KEY	BOTANICAL NAME	COMMON NAME	ROOT	SIZE	SPACING	COMMENTS			
	TREES								
SG	PRUNUS SERRULATA 'SNOW GOOSE'	SNOW GOOSE FLOWERING CHERRY	B&B	3"- 3 1/2" CAL	AS SHOWN	SYMMETRICAL, LEADER INTACT, FULL			
RM	ACER RUBRUM 'BRANDYWINE'	BRANDYWINE AMERICAN RED MAPLE	B&B	3"- 3 1/2" CAL	AS SHOWN	SYMMETRICAL, LEADER INTACT, FULL			
KF	PRUNUS SERRULATA 'KWANZAN'	KWANZAN FLOWING CHERRY	B&B	3"- 3 1/2" CAL	AS SHOWN	SYMMETRICAL, LEADER INTACT, FULL			
	SHRUBS								
AB	THUJA OCCIDENTALIS	AMERICAN ARBORVITAE	B&B	36"-42" HT	60" O.C.	WELL ESTABLISHED, FULL			

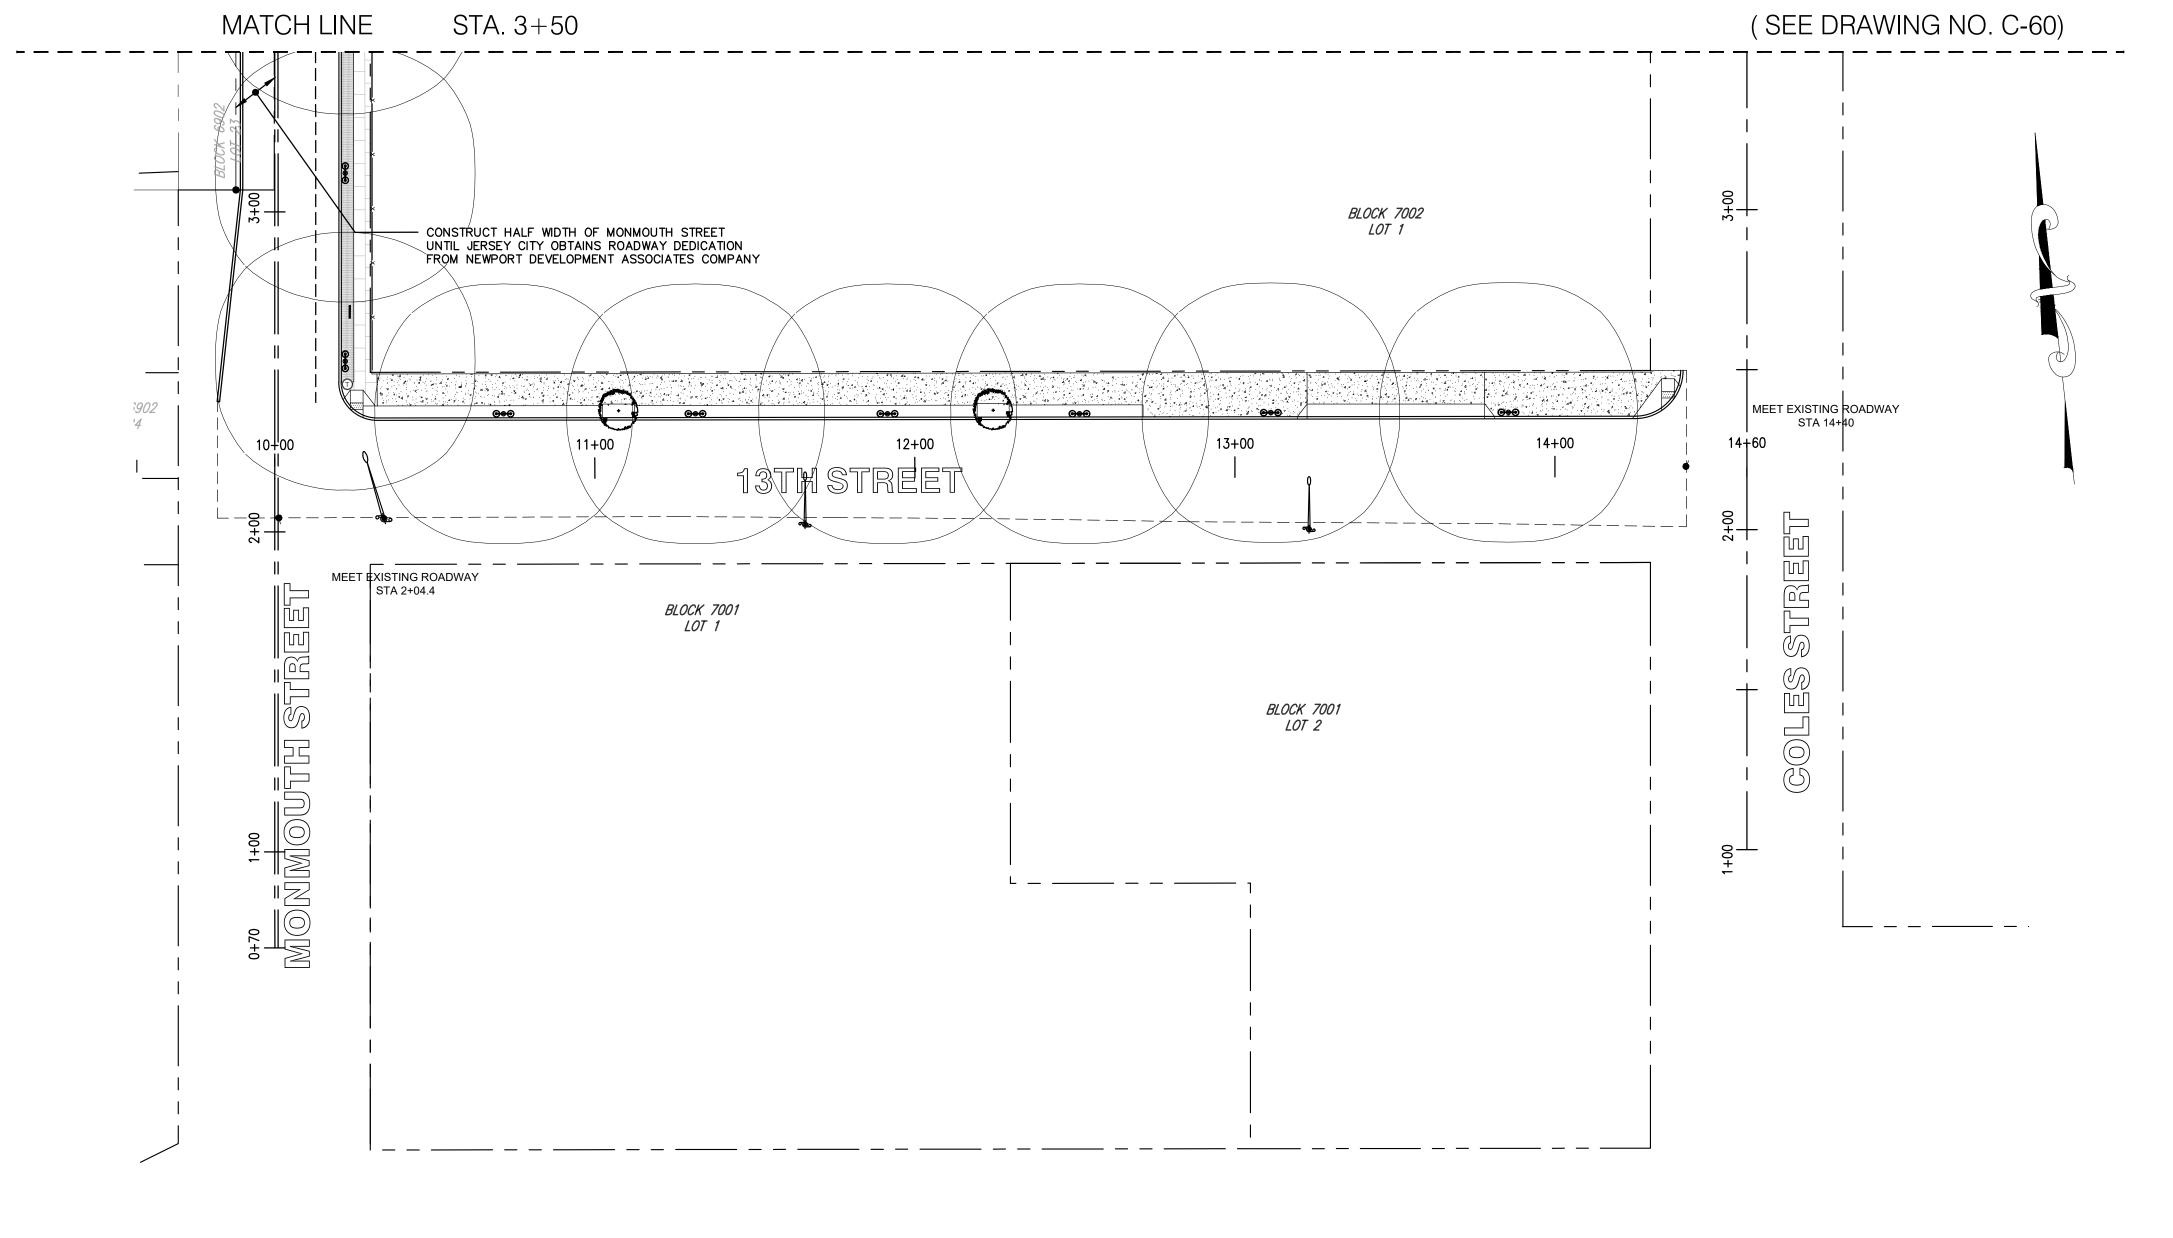




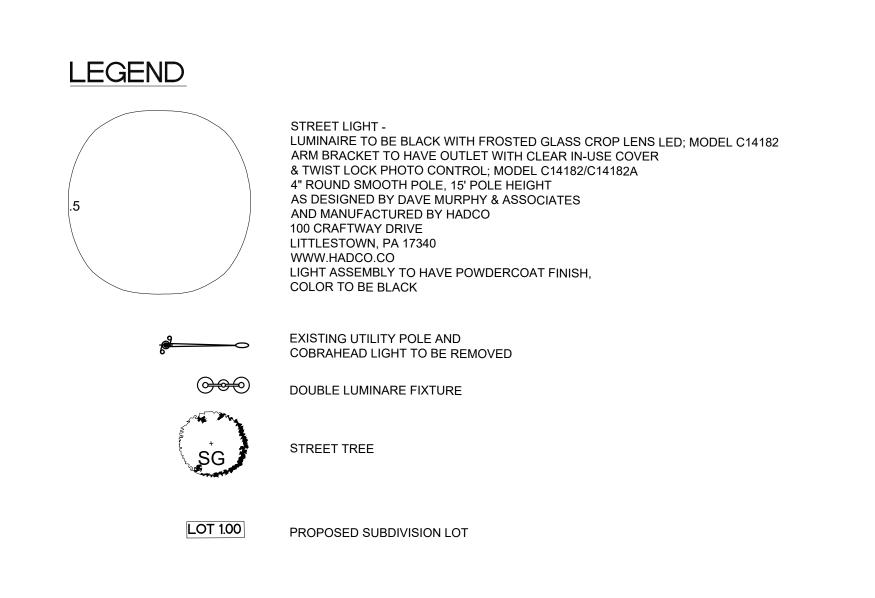


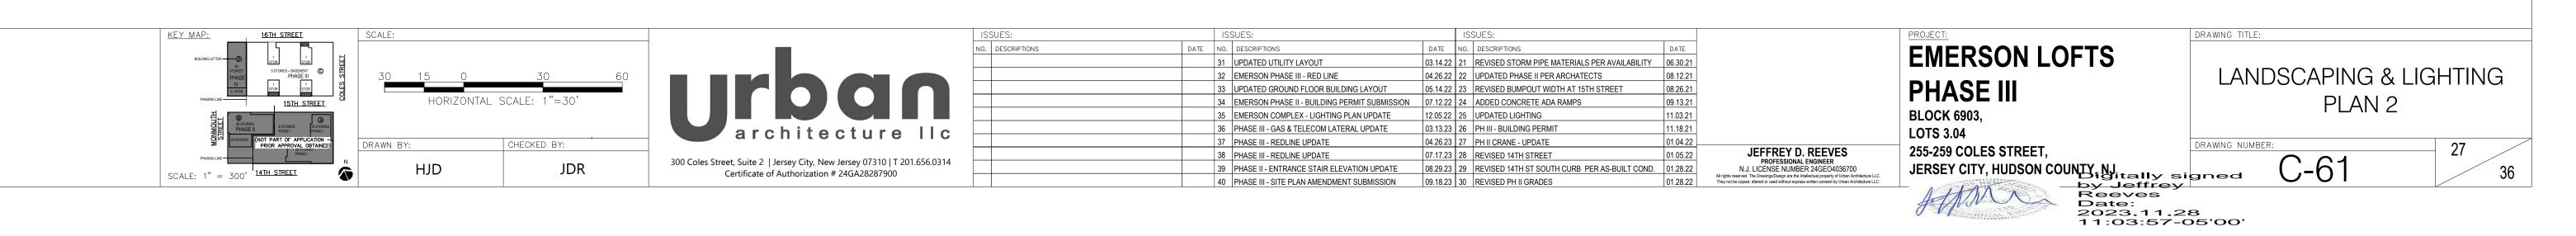

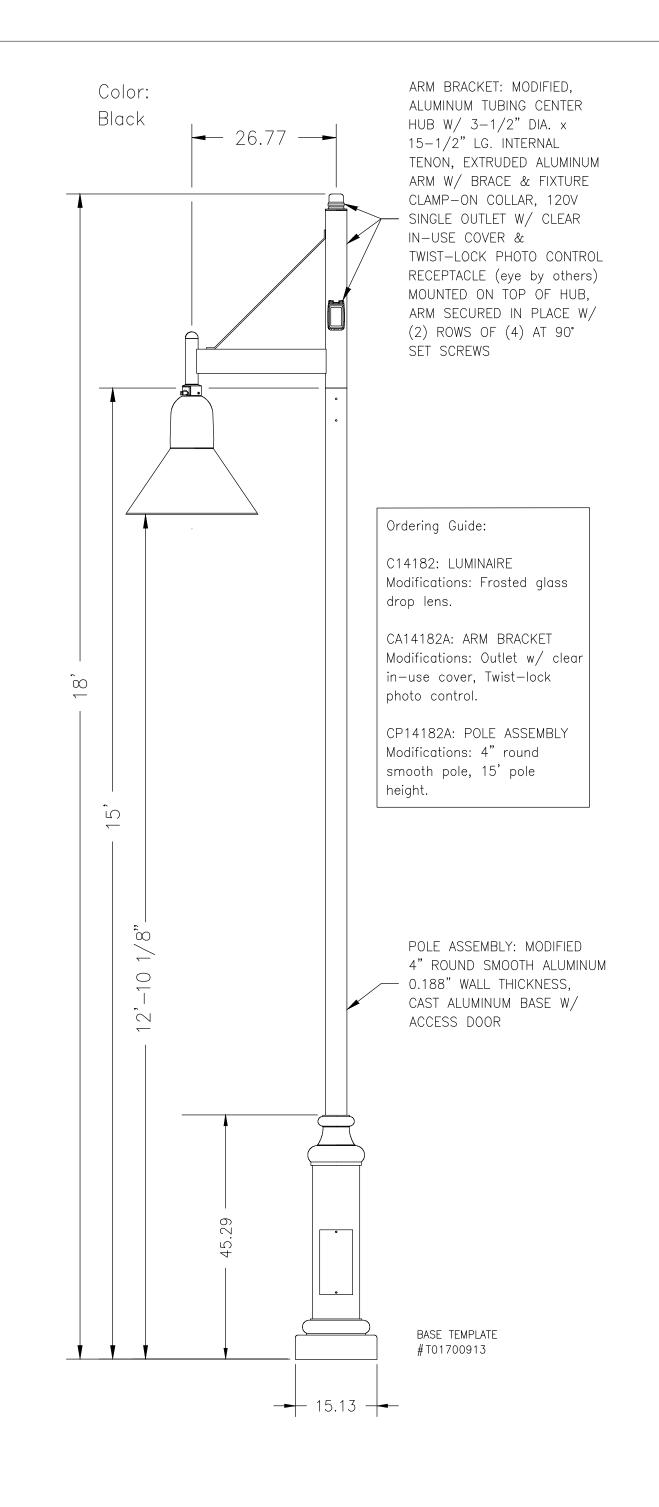

SINGLE LIGHT FIXTURE

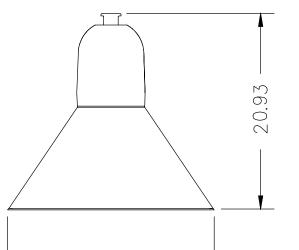

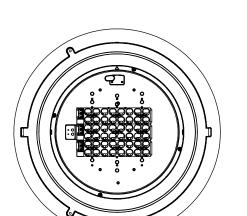

24.50

DROP LENS: FROSTED GLASS COLOR:

BLACK

NONE

OPTIONAL DIMMING:

Philips LEDgine Specifications:

- 48, 4000K (neutral) Philips Lumiled Luxeon T LEDs, typical 75 Color Rendering Index (CRI), >100,000 hours of operational life (at 25°C ambient temperature & 70% lumen maintenance), injection molded Type V optical plates, IP66 rated
- LED module.

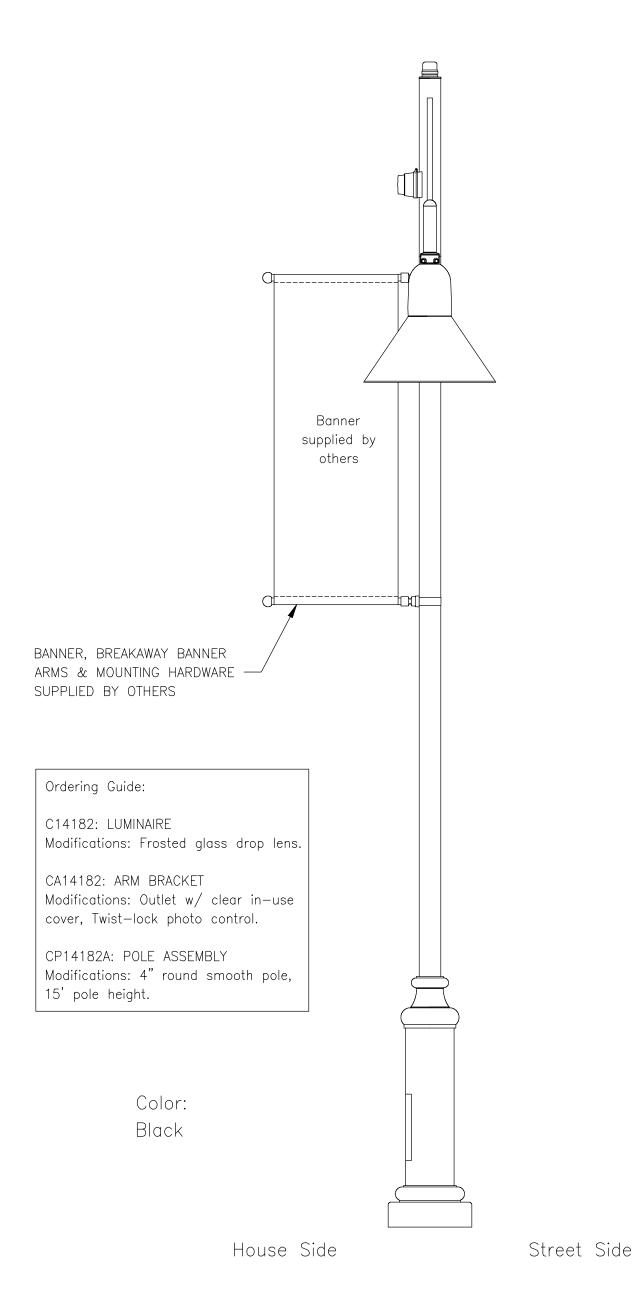
 Integral Philips Advance Xitanium LE driver, class 1, IP66 rated, 350mA, IntelliVolt 120-277 VAC, 50-60 Hz, RoHS compliant, 10kV/10kA surge suppression.

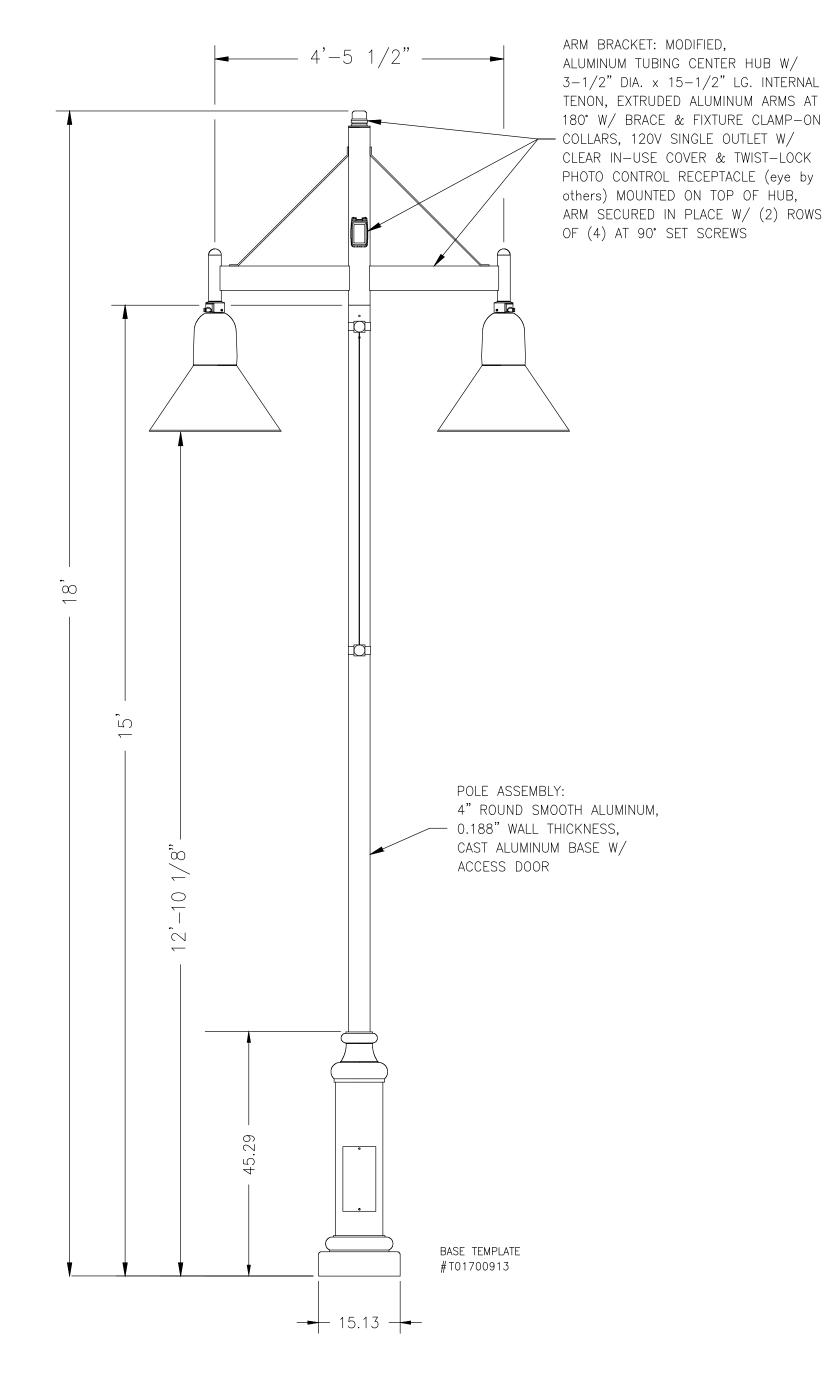
Luminaire Certifications:

 UL8750 & UL1598 compliant, ETL/cETL listed to U.S. & Canadian safety standards for wet locations, manufactured to ISO 9001:2008 standards.

NOTE: LIGHT FIXTURE AS DESIGNED BY DAVE MURPHY & ASSOCIATES.


STREET LIGHT LUMINAIRE NTS






NOTE: LIGHT FIXTURE AS DESIGNED BY DAVE MURPHY & ASSOCIATES.

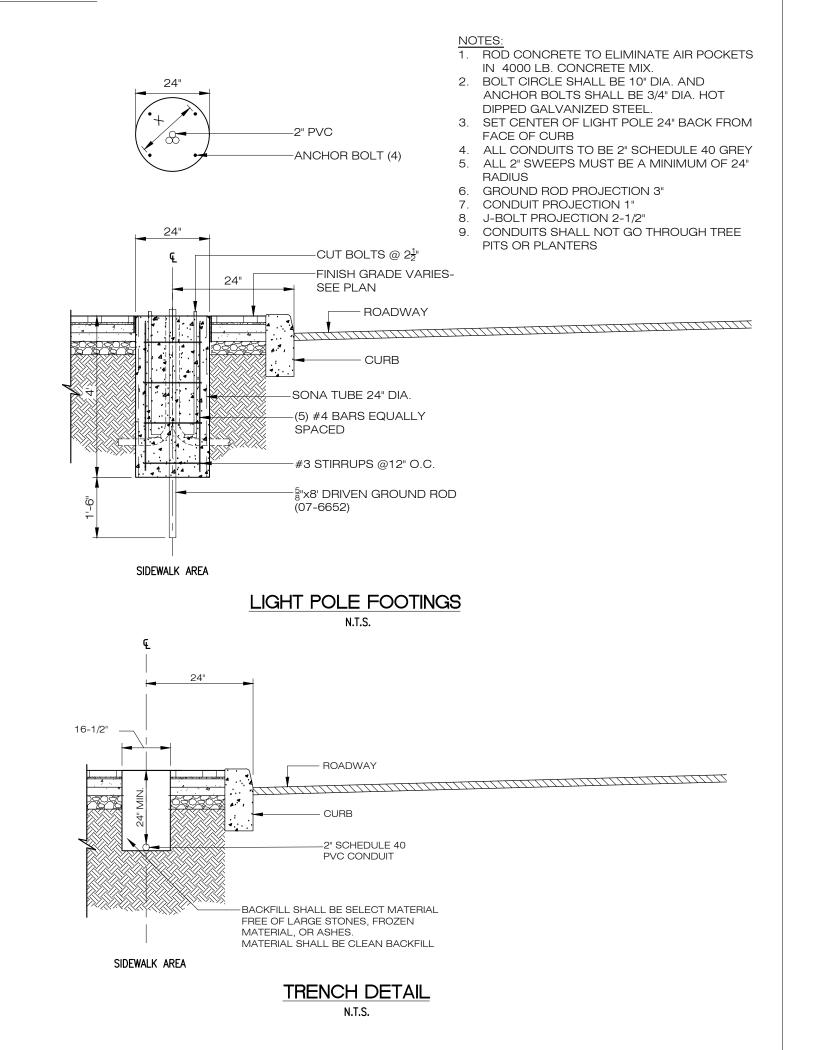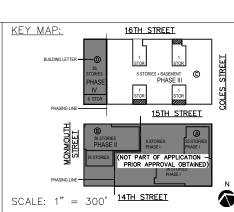DOUBLE BACK-TO-BACK LIGHT FIXTURE NTS






AS SHOWN


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HJD

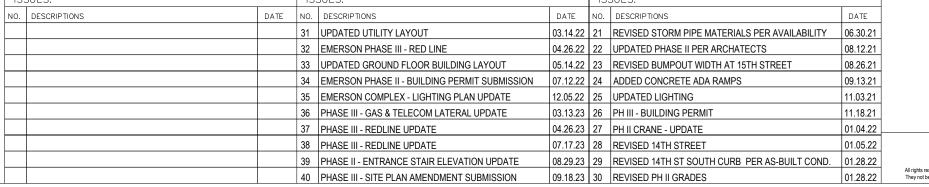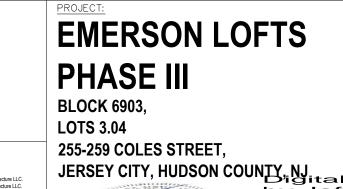JDR







DRAWING TITLE:

LIGHTING DETAILS

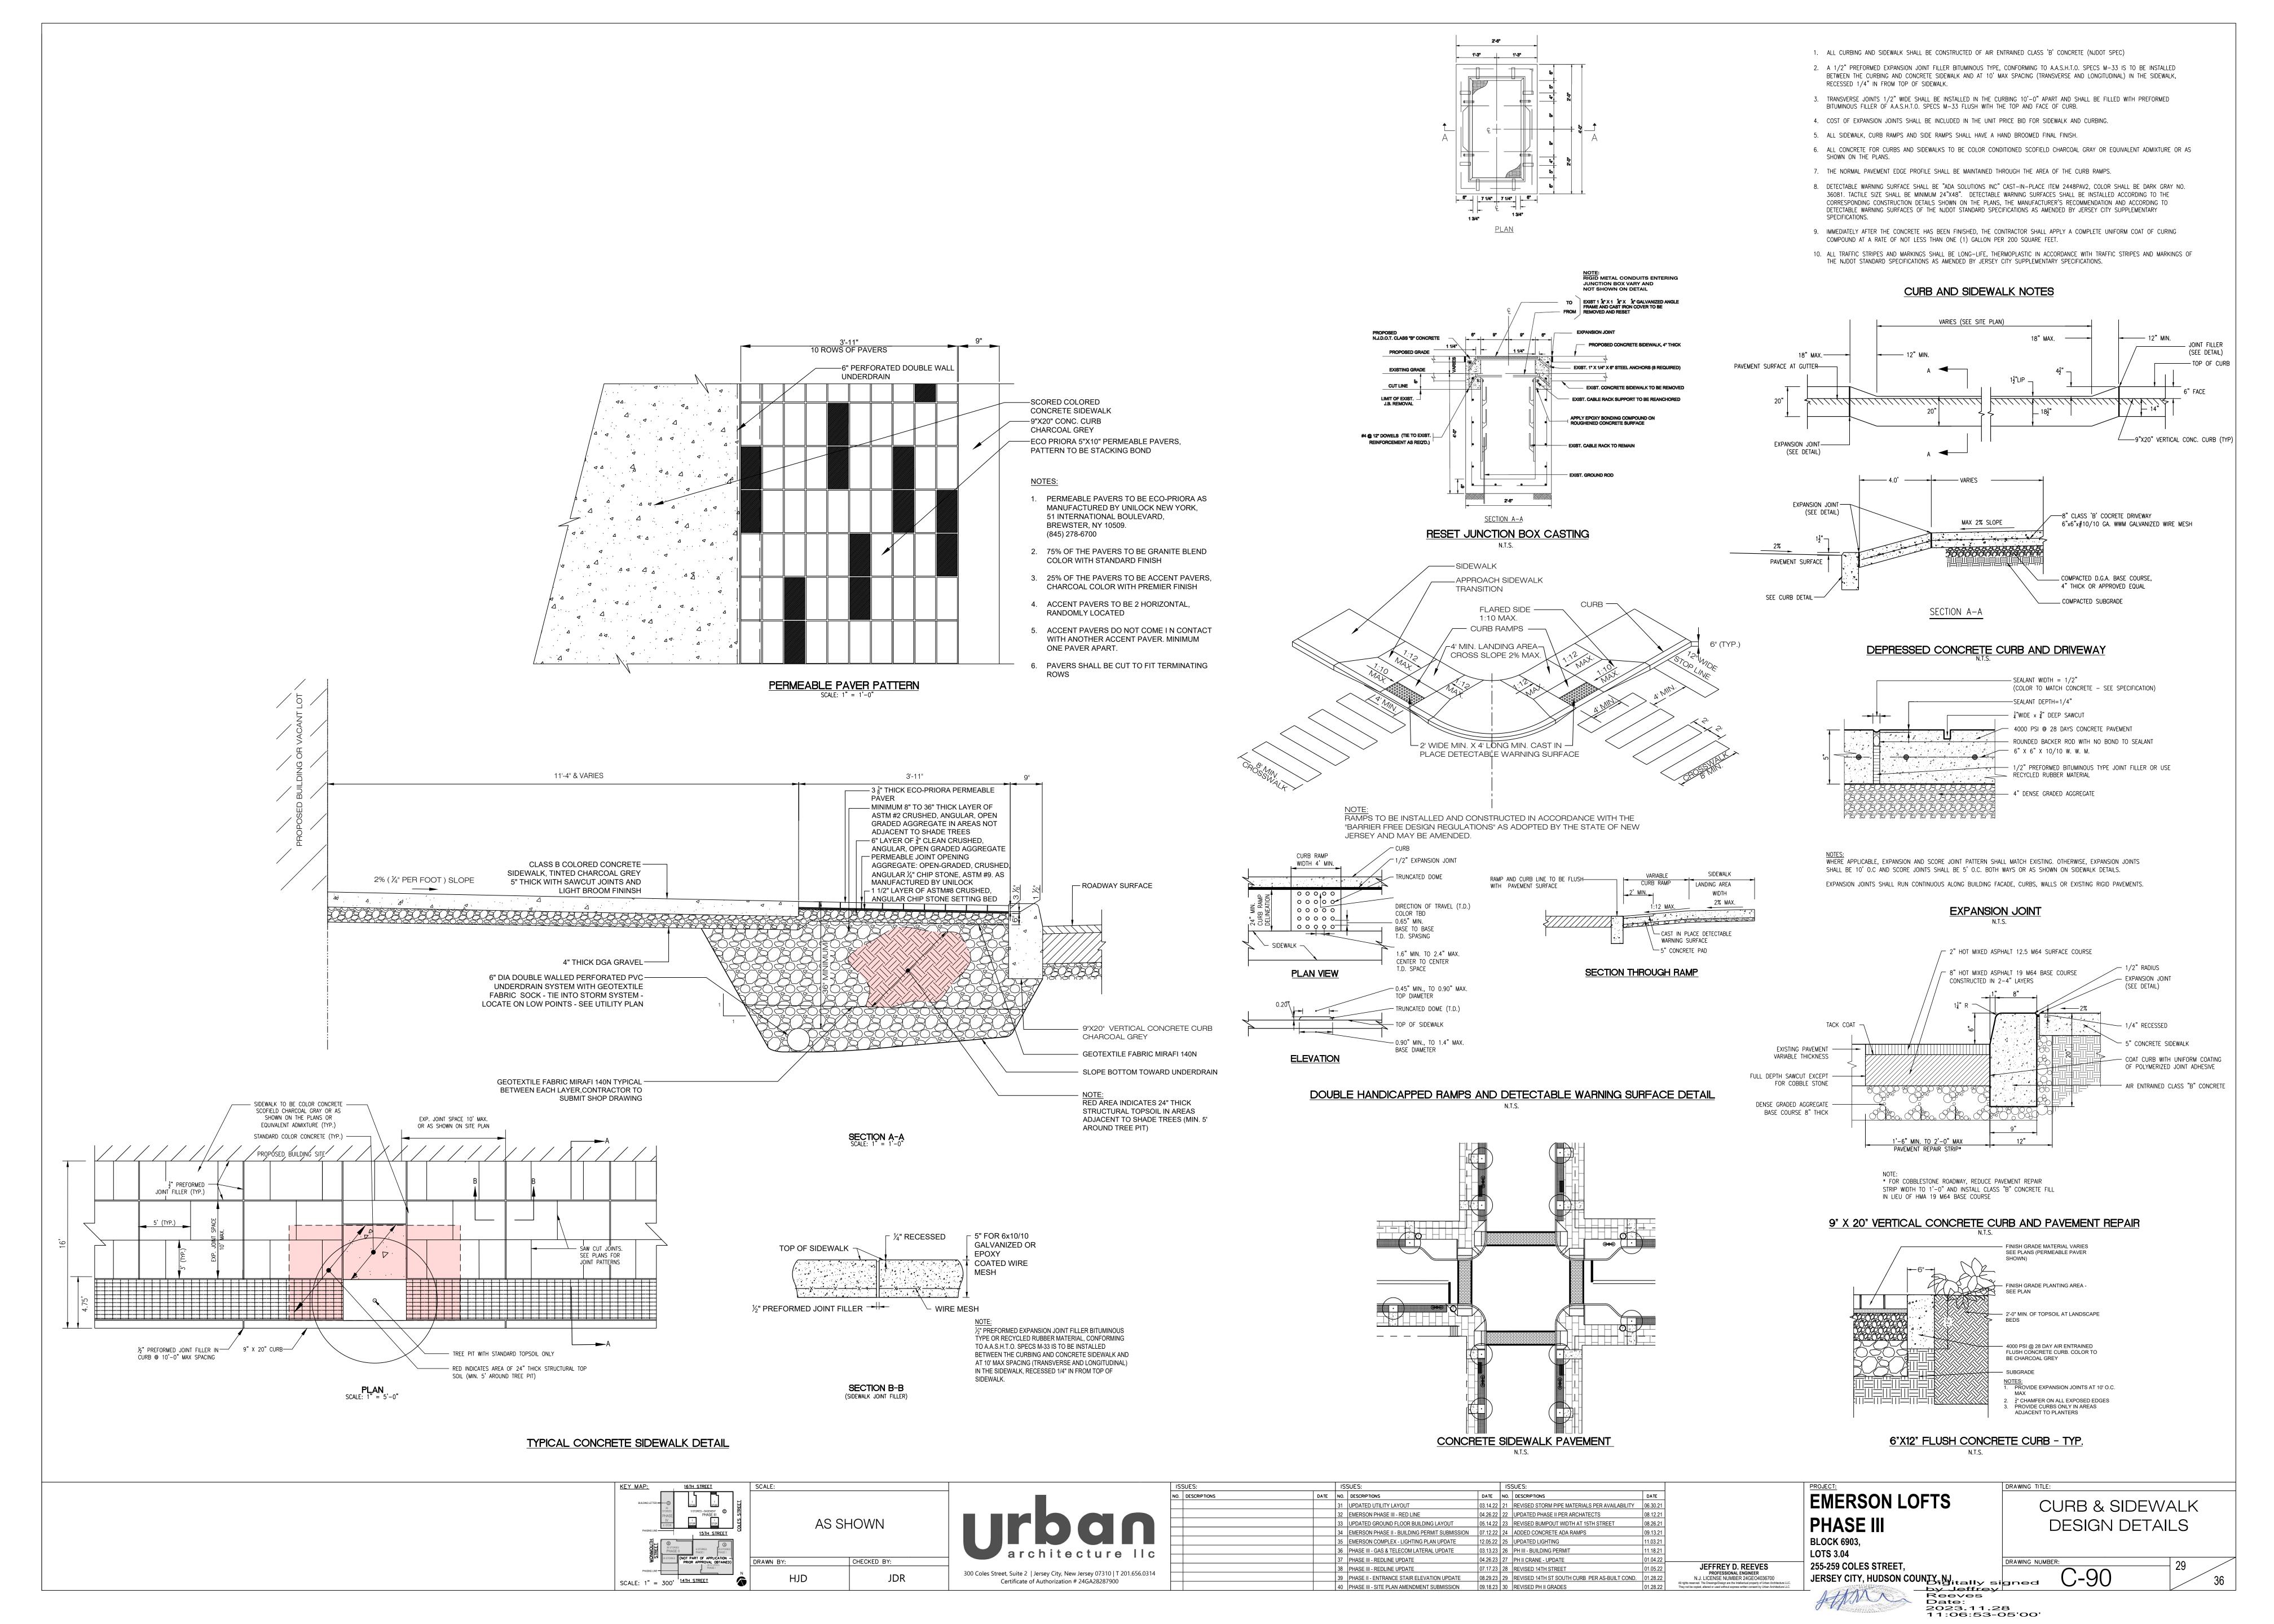
DRAWING NUMBER: 28

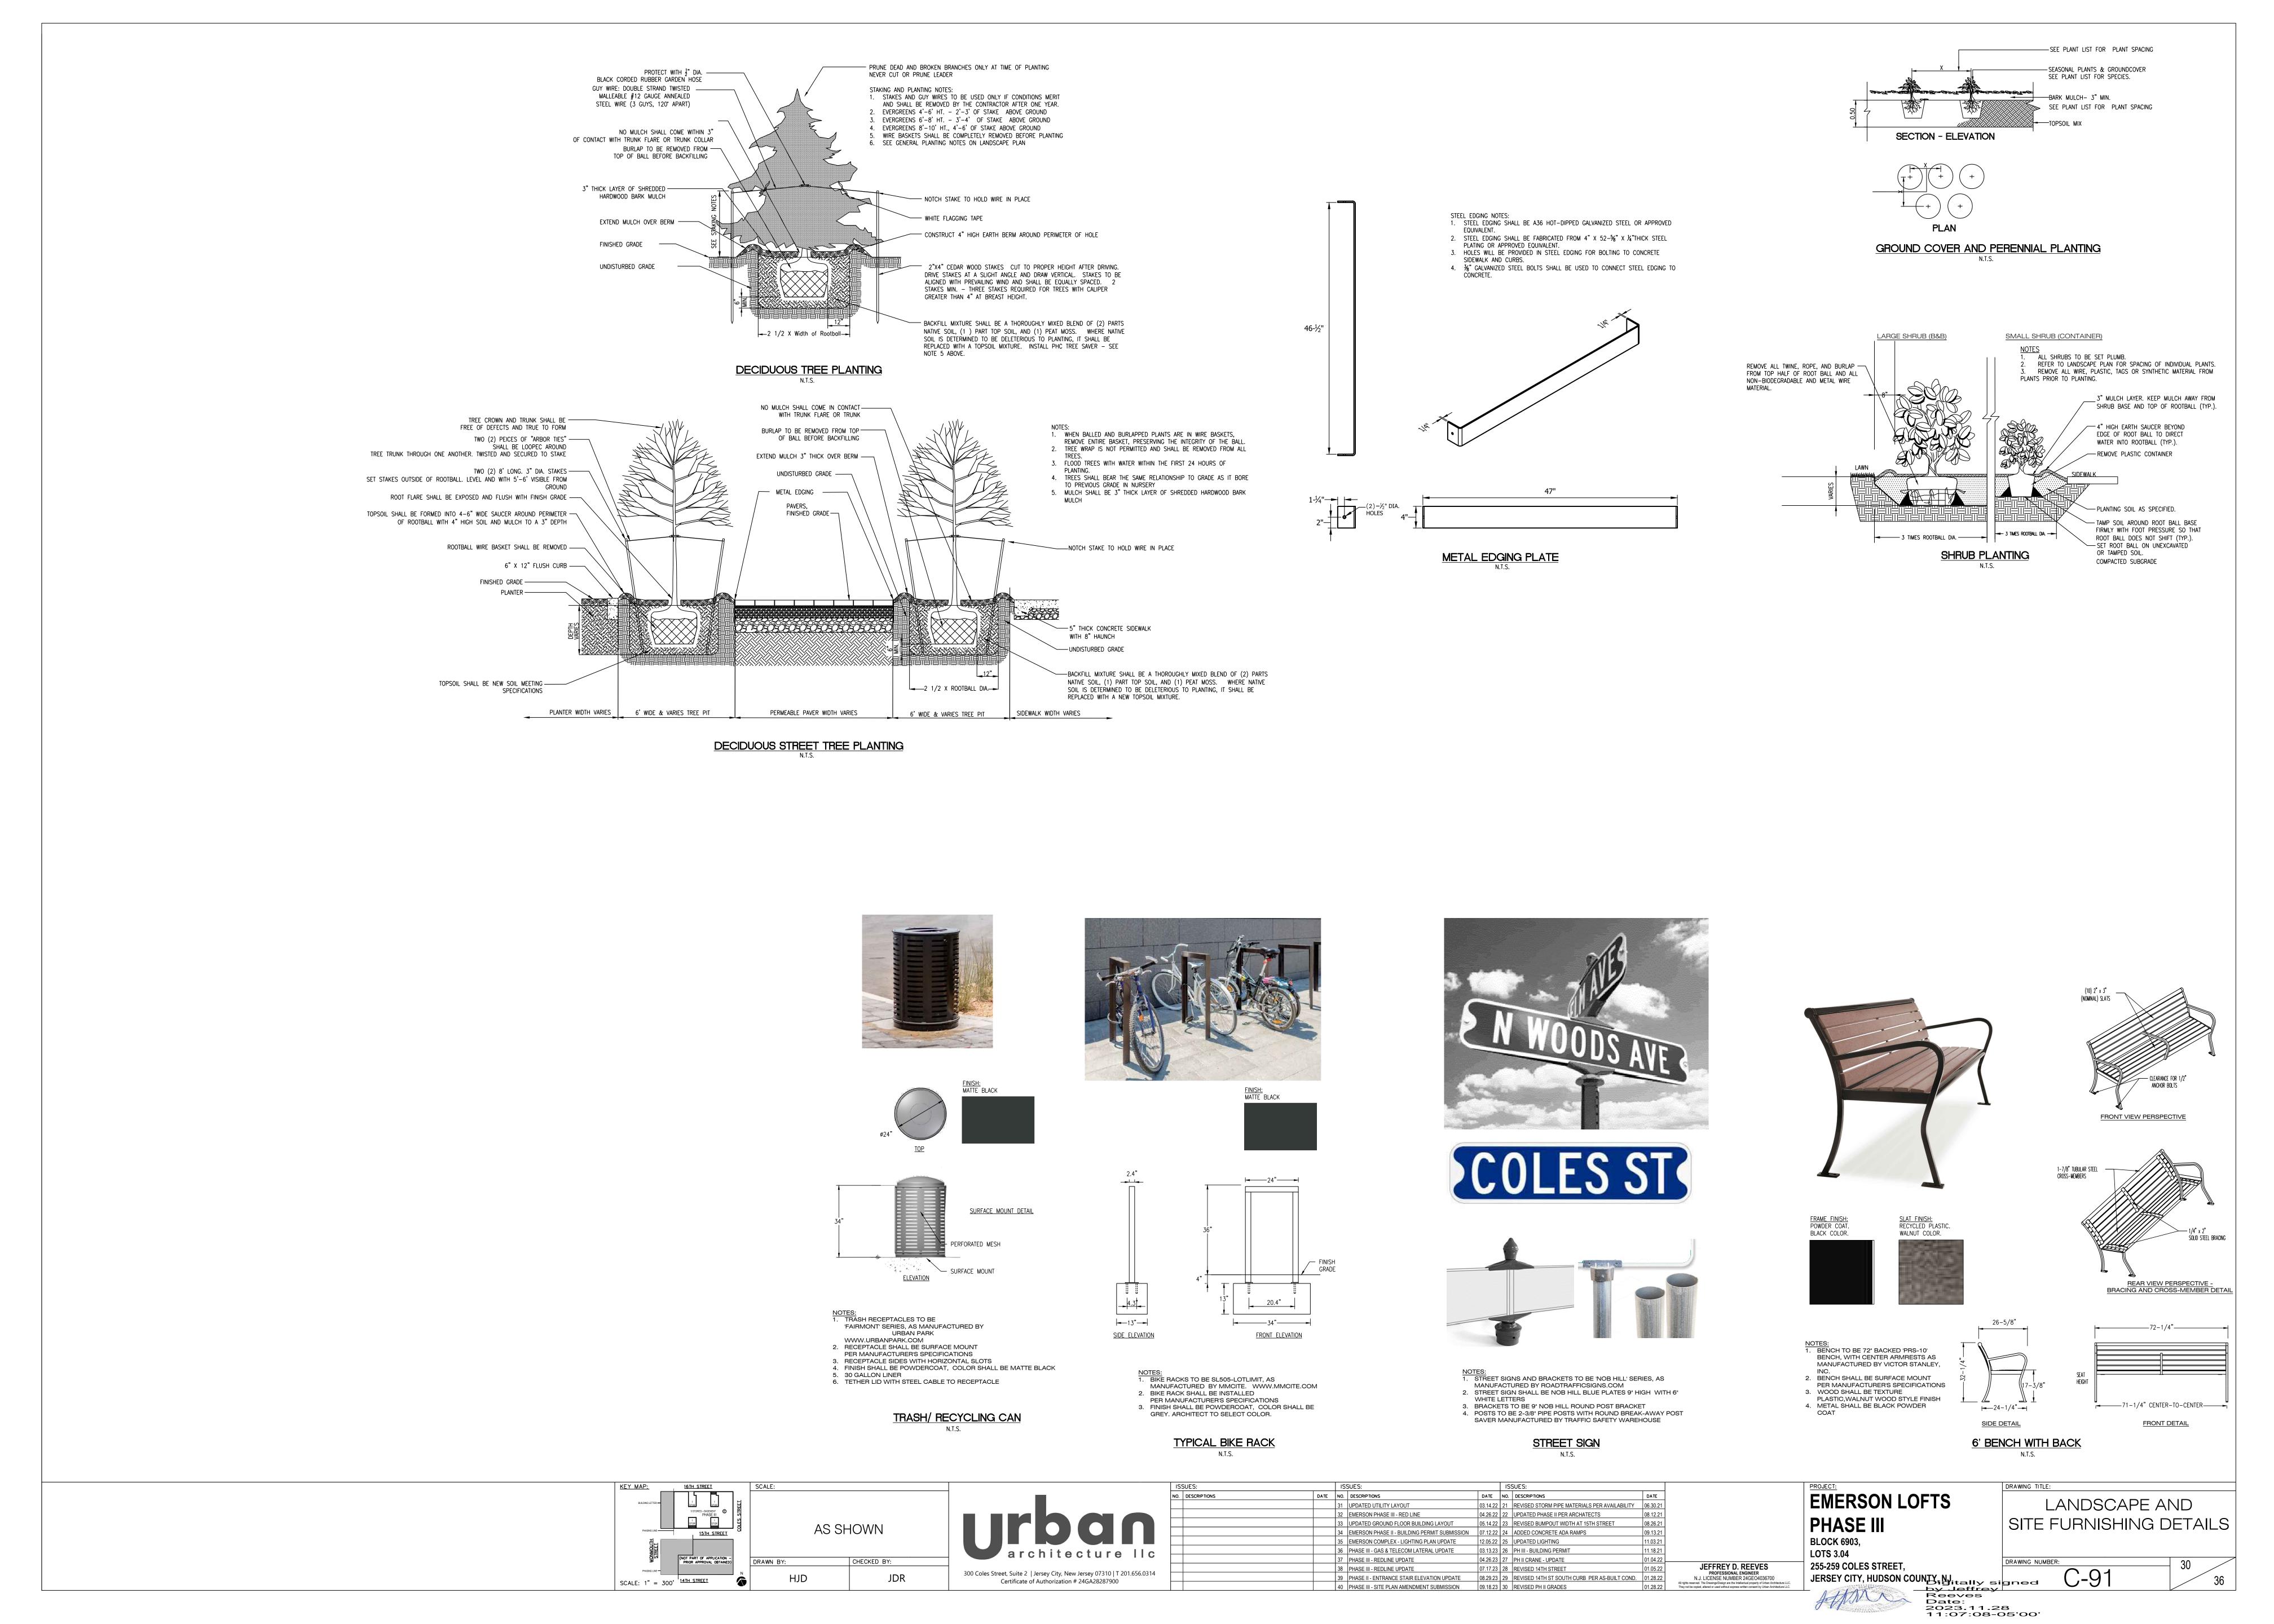
JEFFREY D. REEVES
PROFESSIONAL ENGINEER
N.J. LICENSE NUMBER 24GE04036700
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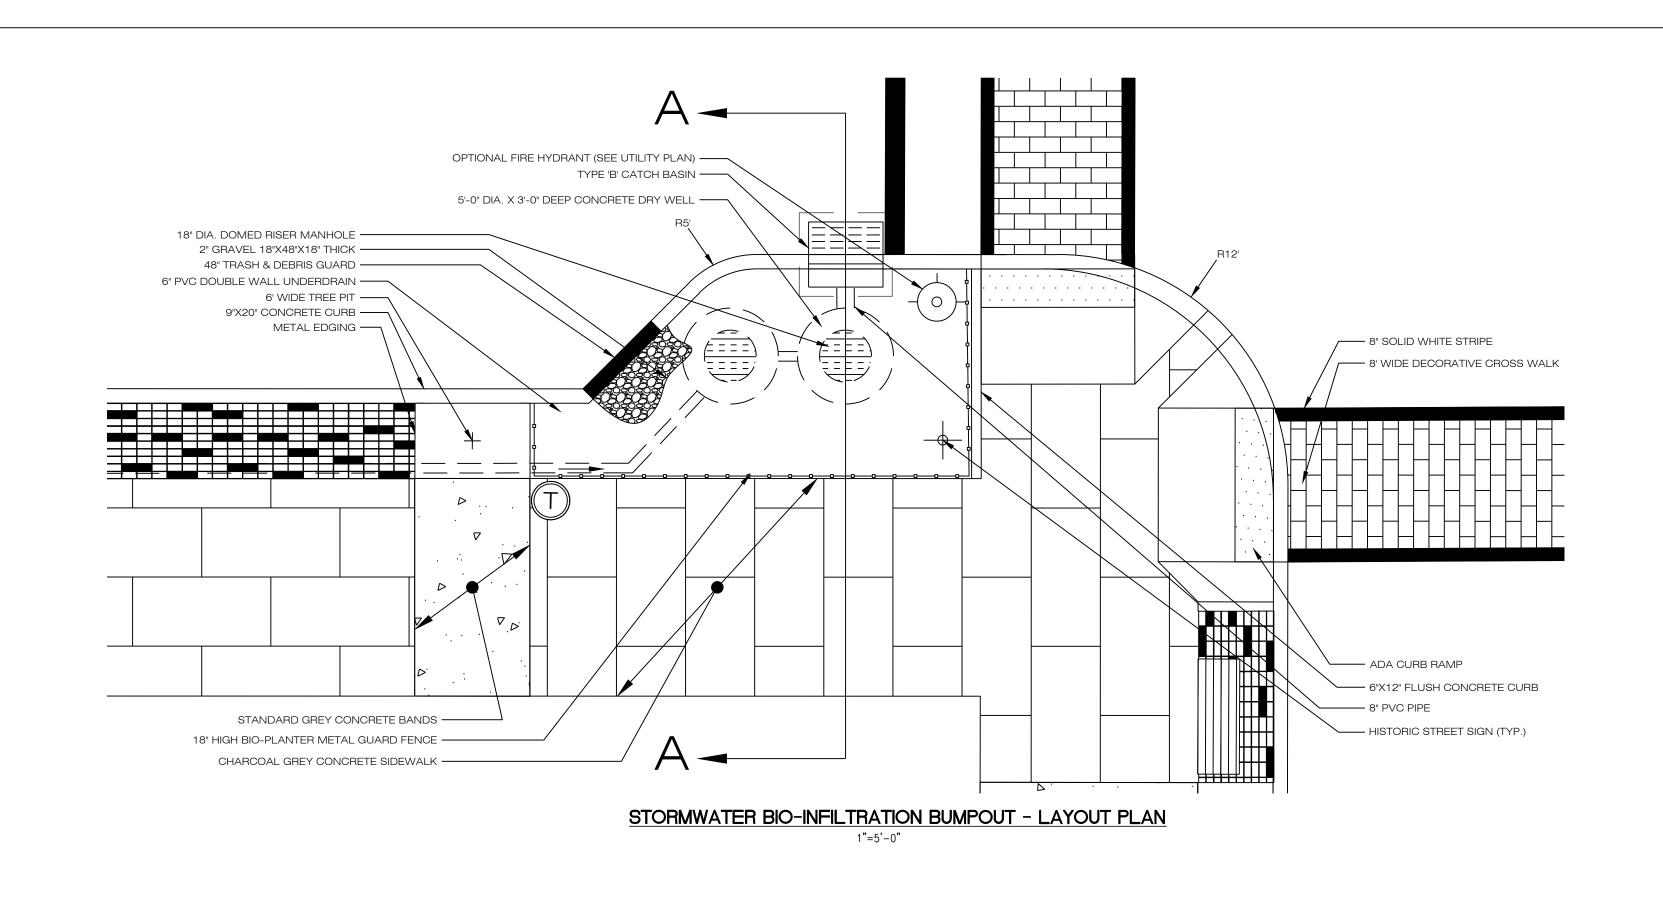
JERSEY CITY, HUDSON COUNTY, NJ


by Jeffrey

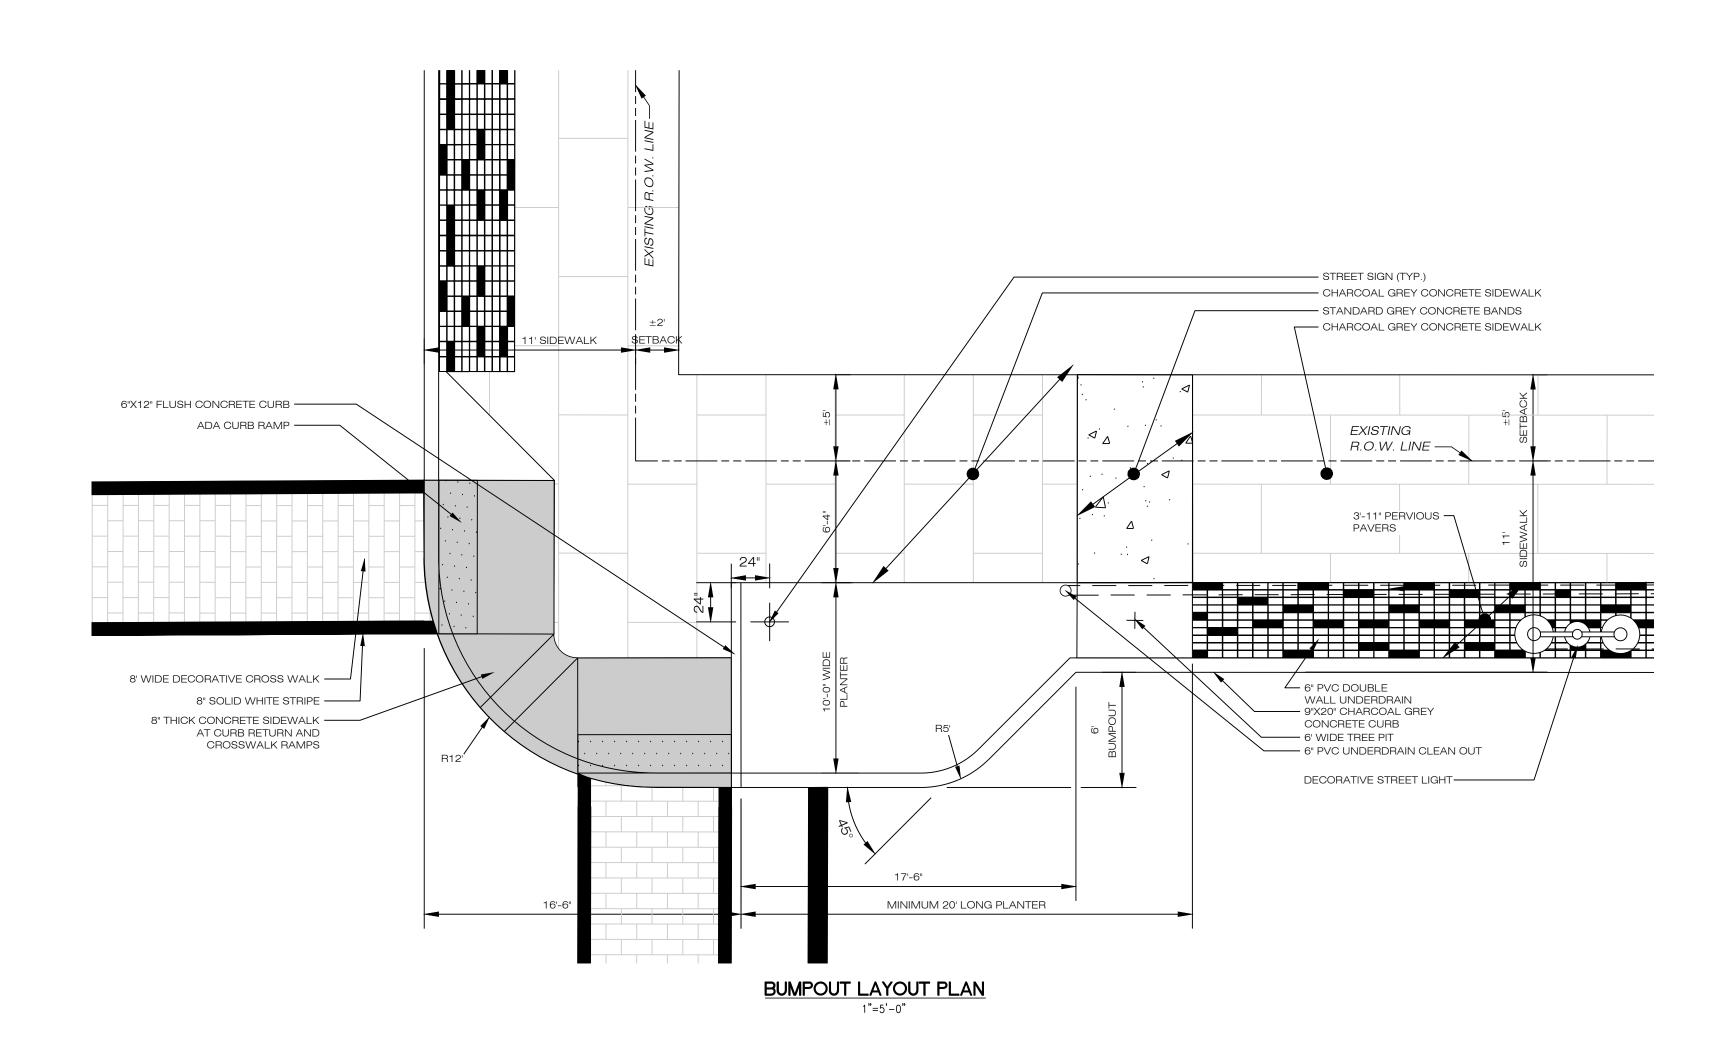Reeves
Date:
2023.11.28
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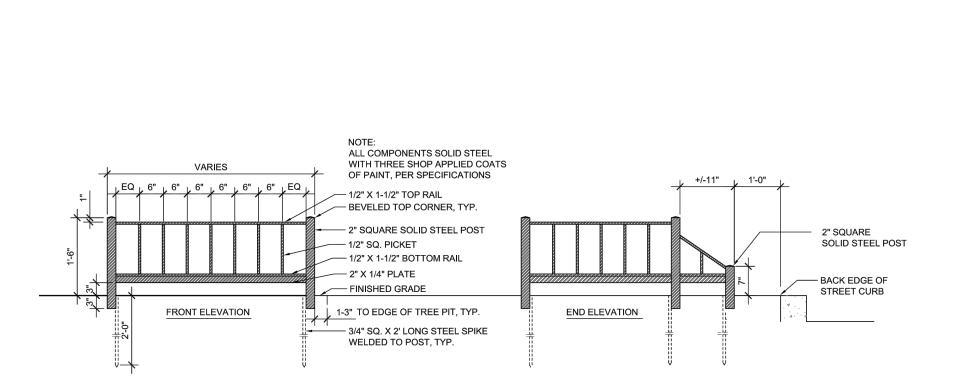


16TH STREET

15TH STREET

(NOT PART OF APPLICATION -PRIOR APPROVAL OBTAINED)

SCALE: 1" = 300' 14TH STREET



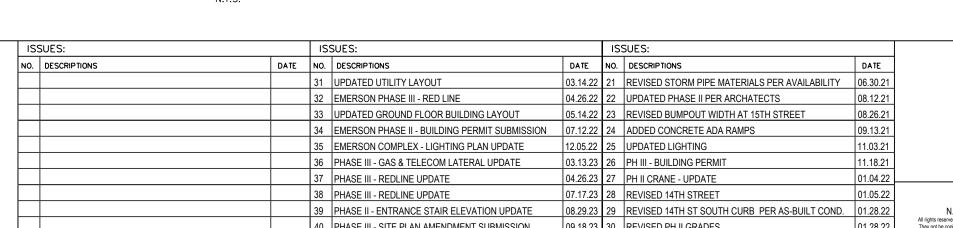
18" HIGH BIO-PLANTER METAL GUARD FENCE

CHECKED BY:

JDR

AS SHOWN





3/4" TYP. → | → 1 1/2" TYP.

16 3/4"

1. DOMED BEEHIVE GRATE SHALL BE MODEL # R-2560-C

2. CASTING TO BE PROVIDED BY CAMPBELL FOUNDRY

TWO 3/4" DIA. HOLES FOR ATTACHMENT TO DRYWELL

OVERFLOW INLET - FRAME AND BEEHIVE GRATE

2121 BROOKS AVE.

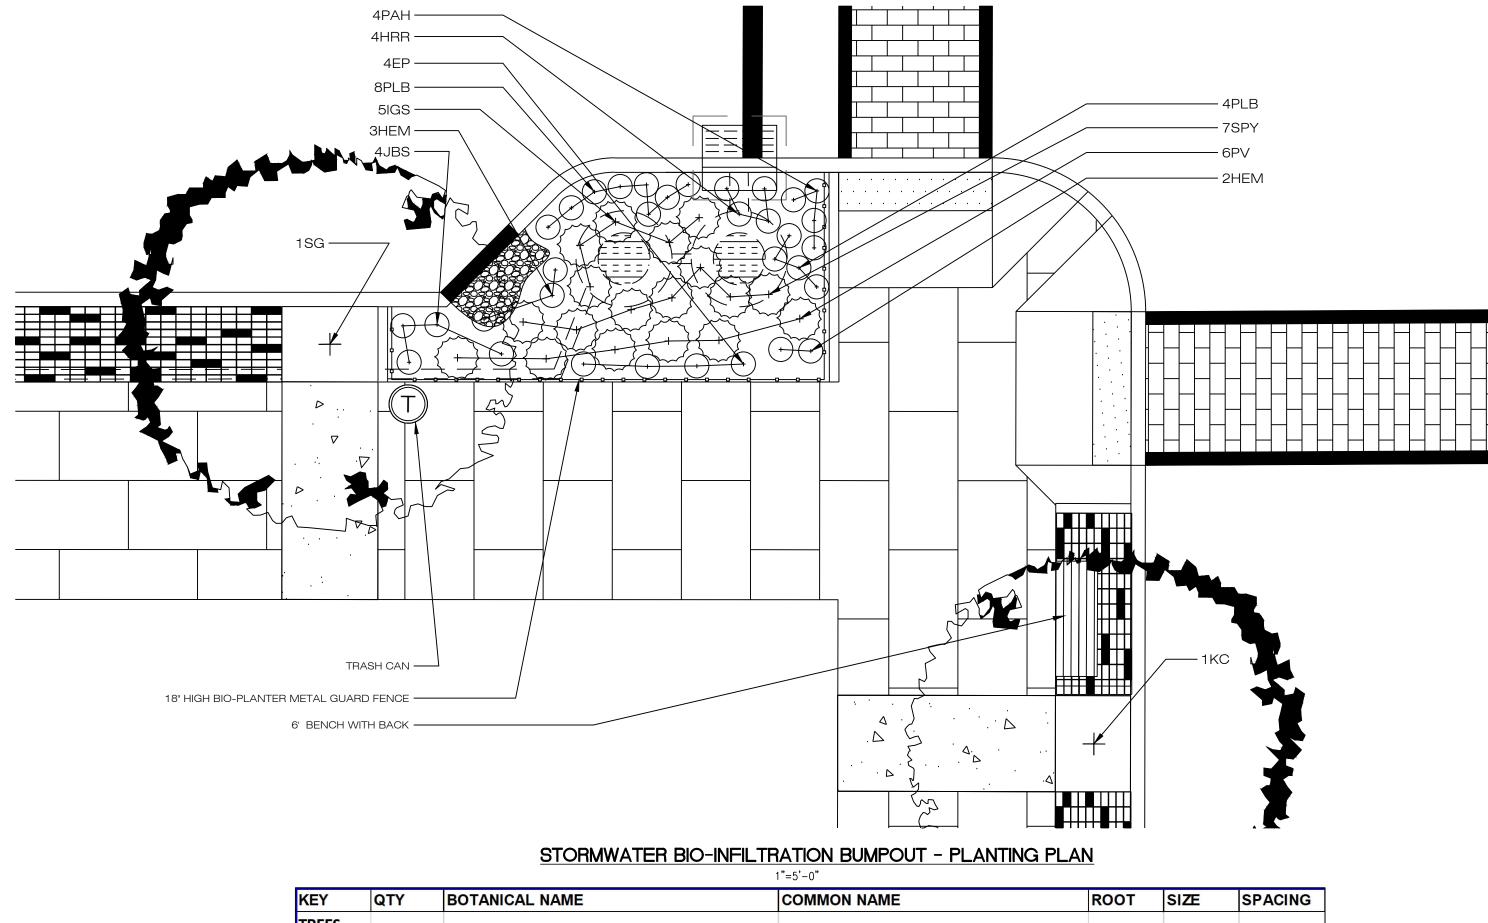
3. CASTING SHALL BE SUPPLIED WITH

NEENAH, WI 54956


TEL: 800-558-5075

WWW.NFCO.COM


AS MANUFACTURED BY NEENAH FOUNDRY COMPANY



			1"=5'-0"			
KEY	QTY	BOTANICAL NAME	COMMON NAME	ROOT	SIZE	SPACING
TREES						
KC	1	Prunus Serrulata 'Kwanzan'	Kwanzan Flowering Cherry	3"-3.5"cal	8' - 10'	Per Plan
SG	1	Prunus Serrulata 'Snow Goose'	Snowgoose Flowering Cherry	3"-3.5"cal	8' - 10'	Per Plan
SHRUBS						
IGS	5	Ilex glabra 'Shamrock'	Inkberry Holly	3 Gal	18" - 24"	Per Plan
JBS	4	Juniperus squamata 'Blue Star'	Blue Star Juniper	3 Gal	18" - 24"	Per Plan
SPY	7	Spiraea japonica 'Yan'	Double Play Gold Sparea	3 Gal	18" - 24"	Per Plan
PERENNI	ALS					
EP	6	Echinacea purpurea 'Merlot'	Merlot Coneflower	2 Gal	15" - 18"	24" O.C.
PAH	4	Pennisetum alopecuroides 'Hameln'	Hameln Fountain Grass	2 Gal	18"-24"	24" O.C.
HRR	4	Hemerocallis 'Rosy Returns'	Rosy Returns Daylily	1 Gal	15" - 18"	12" O.C.
HEM	5	Hemerocallis 'Stella d'Oro'	Stella d'Oro Daylily	1 Gal	15" - 18"	12" O.C.
PV	6	Panicum virgatum 'Shanendoah'	Switch Grass	3 Gal	18" - 24"	24" O.C.
PLB	12	Pennisetum alopecuroides 'Little Bunny'	Dwarf Fountain Grass	2 Gal	15" - 18"	18" O.C.

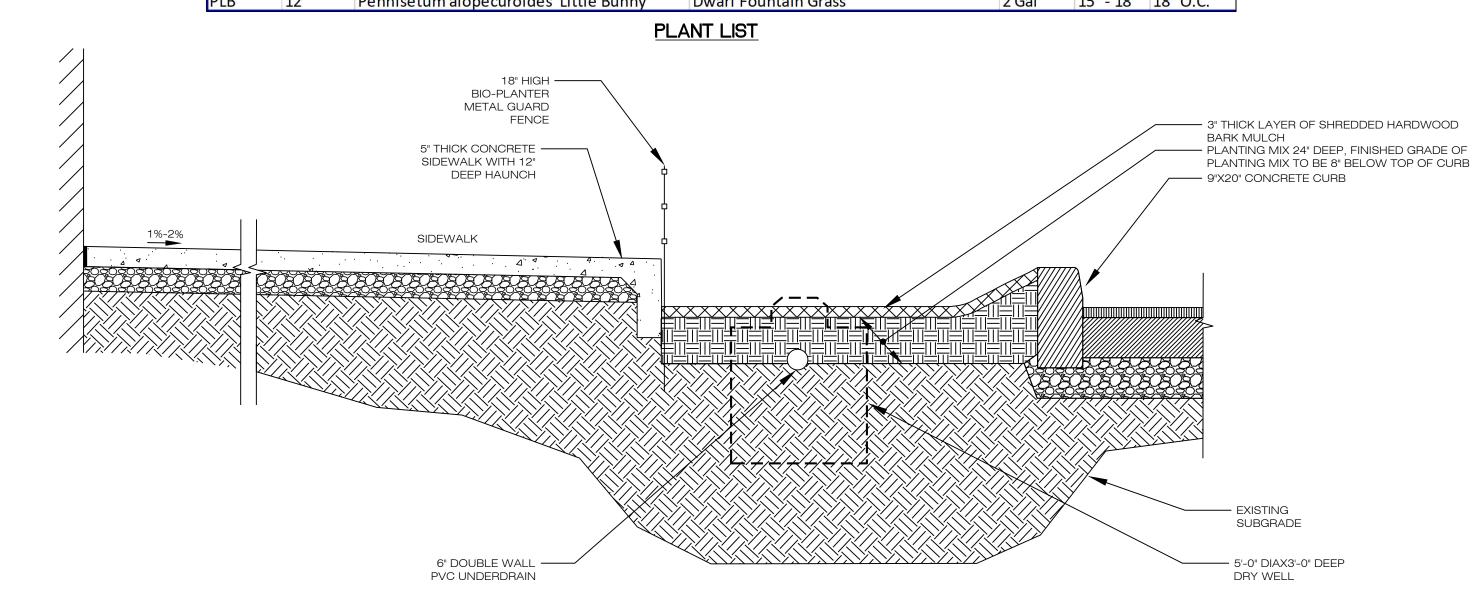

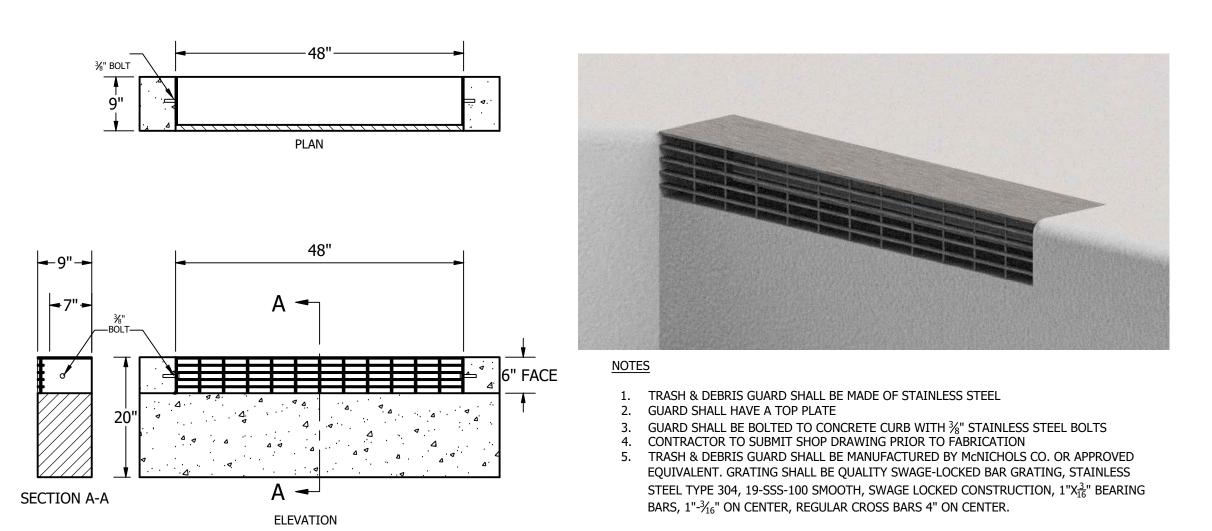STORMWATER BIO-INFILTRATION BUMPOUT - SECTION 'A' - 'A'



TRASH AND DEBRIS GUARD


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TIONS	DATE NO.	DESCRIPTIONS	DATE NO	DESCRIPTIONS	DATE		EMEDOON LOETS			
	31	UPDATED UTILITY LAYOUT	03.14.22 2	REVISED STORM PIPE MATERIALS PER AVAILABILITY	06.30.21		EMERSON LOFTS			——
	32	EMERSON PHASE III - RED LINE	04.26.22 22	UPDATED PHASE II PER ARCHATECTS	08.12.21				BIO-PI A	ANTER &
	33	UPDATED GROUND FLOOR BUILDING LAYOUT	05.14.22 23	REVISED BUMPOUT WIDTH AT 15TH STREET	08.26.21		PHASE III			
	34	EMERSON PHASE II - BUILDING PERMIT SUBMISSION	07.12.22 24	ADDED CONCRETE ADA RAMPS	09.13.21				RUMPOUT	ΓDETAILS
	35	EMERSON COMPLEX - LIGHTING PLAN UPDATE	12.05.22 2	UPDATED LIGHTING	11.03.21		BLOCK 6903,			DE I7 (ILO
	36	PHASE III - GAS & TELECOM LATERAL UPDATE	03.13.23 26	PH III - BUILDING PERMIT	11.18.21		LOTS 3.04			
	37	PHASE III - REDLINE UPDATE	04.26.23 2	PH II CRANE - UPDATE	01.04.22				DRAWING NUMBER:	24
	38	PHASE III - REDLINE UPDATE	07.17.23 28	REVISED 14TH STREET	01.05.22	JEFFREY D. REEVES PROFESSIONAL ENGINEER	255-259 COLES STREET,	F	\cap	31
	39	PHASE II - ENTRANCE STAIR ELEVATION UPDATE	08.29.23	REVISED 14TH ST SOUTH CURB PER AS-BUILT COND.	01.28.22	N.J. LICENSE NUMBER 24GEO4036700 All rights reserved. The Drawings/Design are the Intellectual property of Urban Architecture LLC.	JERSEY CITY, HUDSON COUNTY, NJ.		gned C-92	36
	40	PHASE III - SITE PLAN AMENDMENT SUBMISSION	09.18.23	REVISED PH II GRADES	01.28.22	They not be copied, altered or used without express written consent by Urban Architecture LLC.	by J	effrey		
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							11:0	7:23-0	05'00'	

STANDARD REQUIREMENTS FOR NEW SANITARY AND STORM SEWERS AND SERVICE LATERALS

- 1. BEDDING AND BACKFILL MATERIAL SHALL COMPLY WITH THE REQUIREMENT OF THE NJDOT'S STANDARD SPECIFICATION FOR ROAD AND BRIDGE CONSTRUCTION, AND THE DESIGN AND CONSTRUCTION OF URBAN STORMWATER MANAGEMENT SYSTEMS, ASCE MANUALS AND REPORTS OF ENGINEERING PRACTICE No.77, 1993, AS APPLICABLE.
- 2. ALL SEWER SERVICE CONNECTIONS 6-INCHES IN SIZE OR SMALLER MUST BE MADE DIRECTLY TO THE SEWER MAIN AND ALL CONNECTIONS 8-INCHES IN SIZE OR LAGER MUST BE MADE TO A MANHOLE. WHERE A CONNECTION TO A MANHOLE IS REQUIRED, MANHOLE BENCH AND CHANNEL MAY REQUIRE
- 3. THE JCMUA REQUIRES THAT SEWER SERVICE CONNECTIONS TO BE RE-USED BE TELEVISED TO VERIFY THEIR INTEGRITY AND THAT THE PIPE IS FREE FROM
- 4. EACH BUILDING CONNECTION REQUIRES A CURB CLEANOUT. T-WYE CLEANOUTS WHICH ENABLE CLEANING IN BOTH DIRECTIONS SHALL BE INSTALLED ON BOTH
- THE STORM AND SANITARY LATERAL. 5. PROPOSED SEWER LATERAL CONNECTION TO JCMUA'S SEWER MAIN SHALL BE MADE ABOVE HORIZONTAL CENTER LINE OF PIPE.

ANY DEFECTS.

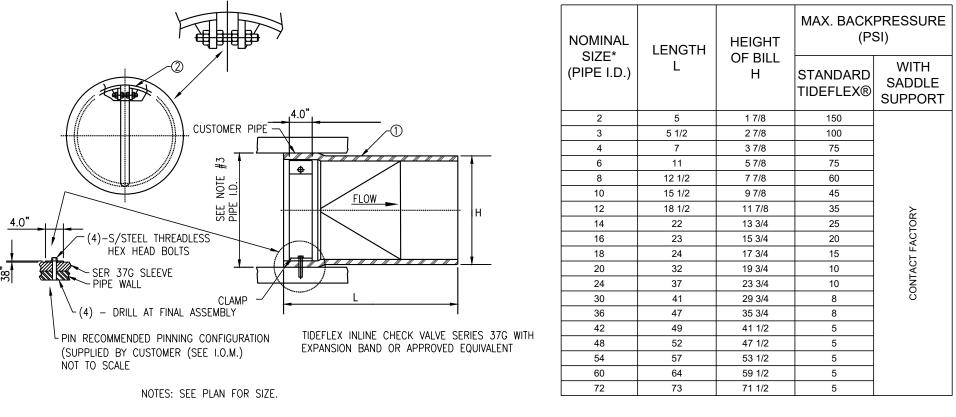- 6. THE SIZE, MATERIAL, DEPTH, CONDITION, DIRECTION OF FLOW AND ANY OTHER RELEVANT CONDITIONS OF THE EXISTING JCMUA SEWER TO WHICH YOU PLAN TO CONNECT MUST BE FIELD VERIFIED BY DEVELOPER TO DETERMINE IF SAID CONNECTION IS PHYSICALLY POSSIBLE AND PRACTICAL. IN ADDITION, MANHOLE INVERTS AND RIM ELEVATIONS MUST BE SHOWN ON PLANS. THIS VERIFICATION IS TO BE INCLUDED ON THE PLANS FOR THE PROJECT.
- 7. CIRCULAR HOLE SAWS WHICH ARE APPROXIMATELY SIZED OR HAND DRILLS MUST BE USED TO MAKE THE OPENINGS IN THE EXISTING SEWER TO RECEIVE THE LATERALS. JACKHAMMERS, SLEDGEHAMMERS AND OTHER UNSUITABLE TOOLS OR MACHINERY WHICH MAY DAMAGE THE JCMUA'S SEWER MAIN ARE NOT
- ALLOWED TO BE USED TO MAKE THE LATERAL OPENINGS. ALL DEBRIS MUST BE REMOVED AND NOT ALLOWED TO FALL INTO PIPE. 8. A DETAIL OF ANY PROPOSED MANHOLE OR CATCH BASIN SHOWING ALL DIMENSIONS IN ADDITION TO RIM, GRATE AND INVERT ELEVATIONS OF THE STRUCTURE AND ALL PIPES CONNECTED TO THE STRUCTURE MUST BE SHOWN ON PLANS. REFER TO JCMUA STANDARD DETAIL DRAWINGS FOR MANHOLES AND CATCH
- 9. PROPOSED MANHOLES CONSTRUCTED IN THE PUBLIC R.O.W. ON EXISTING OR PROPOSED JCMUA SEWERS SHALL BE AS MANUFACTURED BY CAMPBELL FOUNDRY CO. PATTERN #1012B OR EQUAL WITH OUTSIDE COVER DIAMETER OF 31¾" INCHES. THE LETTERS "JCMUA" AND "SANITARY" OR "STORM" SHALL BE CAST IN THE COVER. MANHOLE FRAMES SHALL BE CAMPBELL FOUNDRY CO. PATTERN #1012B (FOR 30-INCH OPENING). REFER TO THE JCMUA'S STANDARD DETAIL FOR MANHOLE FRAMES AND COVERS.
- 10. STORM INLETS WHICH ARE CONNECTED DIRECTLY TO JCMUA COMBINED SEWER MUST BE FURNISHED WITH A SUMP AND TRAP AS PER JCMUA STANDARD DETAILS.
- 11. THE JCMUA HAS A COMBINED SEWER SYSTEM WHICH SURCHARGES DURING WET-WEATHER PERIODS RESULTING IN POSSIBLE SEWAGE BACK-UPS THROUGH PLUMBING FIXTURES (SINKS, TOILETS, FLOOR DRAINS, ETC.) BELOW STREET LEVEL. THIS POSSIBILITY MUST BE ADDRESSED DURING THE DESIGN/CONSTRUCTION PHASE.
- 12.A DROP MANHOLE CONNECTION SHALL BE USED WHERE THERE IS A DIFFERENCE IN ELEVATION OF TWO (2) FEET OR GREATER BETWEEN THE INVERT OF A SANITARY OR COMBINED INLET PIPE TO MANHOLE AND THE CROWN OF THE OUTLET PIPE FROM MANHOLE. REFER TO JCMUA'S STANDARDS DETAIL FOR DROP MANHOLE CONNECTION WHICH MUST BE SHOWN ON SITE PLAN IF REQUIRED.
- 13. TEST PITS MUST BE PERFORMED AT THE DEVELOPER'S EXPENSE DURING THE <u>DESIGN</u> PHASE OF THE PROJECT TO ENSURE THAT PROPOSED SEWERS AND SEWER SERVICES MAY BE CONSTRUCTED AS PROPOSED WITHOUT CONFLICTING WITH OTHER UNDERGROUND UTILITIES OR STRUCTURES.
- 14. ALL EXISTING SEWER MAINS AND SANITARY LATERALS TO BE ABANDONED MUST BE FILLED WITH CONCRETE SLURRY OR REMOVED FROM THE GROUND. CATCH BASINS AND MANHOLES MUST BE REMOVED FROM THE GROUND. CONNECTIONS MUST BE CUT AND SEALED AT THE MAIN AND PRECAUTIONS MUST BE UNDERTAKEN BY THE CONTRACTOR TO ENSURE CONCRETE AND OTHER MATERIALS DO NOT ENTER THE MAIN AND CREATE OBSTRUCTION(S).
- 15. ALL PROPOSED INLETS/CATCH BASINS MUST BE CONSTRUCTED WITH A BICYCLE SAFE GRATE AND CAMPBELL FOUNDRY CO. TYPE 'N' CURBPIECE WHERE REQUIRED.
- 16. PROPOSED WATER SERVICES REQUIRE THE REVIEW AND APPROVAL OF THE DIVISION OF WATER ENGINEERING.
- 17. THE CONTRACTOR IS RESPONSIBLE FOR OBTAINING PERMITS FOR STREET OPENINGS FROM THE JERSEY CITY ENGINEERING DEPARTMENT LOCATED AT 13-15 LINDEN AVENUE EAST, 2ND FLOOR, JERSEY CITY, N.J. AND ALL OTHER APPLICABLE PERMITS FROM AGENCIES HAVING JURISDICTION.



LIFTING HOLE REF

DIMENSIONS IN INCHES

THE GASKET IS LOCATED AS AN

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▽ △ ▽ △ ⋅ 寸

INTEGRAL PART OF THE MANHOLE

A-LOK & Z-LOC GASKETS SHALL

C-923

A-LOK GASKET

TYPICAL A-LOK CONNECTION FOR SANITARY MANHOLES

MEET THE REQUIREMENTS OF ASTM

PREFERED METHOD TIDEFLEX 37G INLINE BACKFLOW PREVENTOR

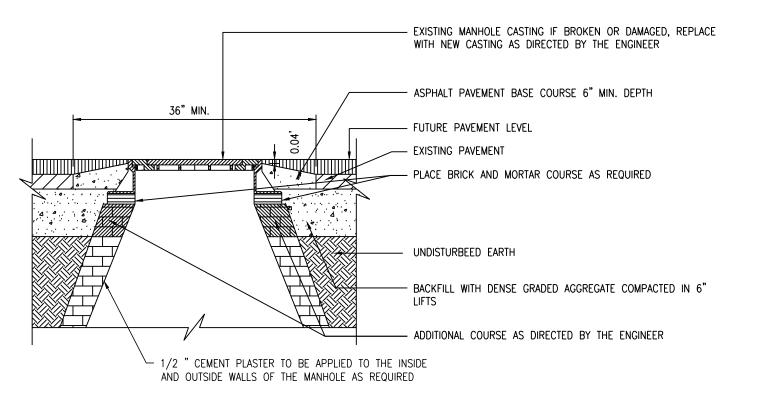
CMP AND ATTACHING HARDWARE BY OTHERS CONTRACTOR TO

INSERT DEPTH


ALTERNATE METHOD

FLAP GATE BACKFLOW PREVENTOR

PROVIDE CAULKING TYPE SEAL AS



RESET MANHOLE CASTING

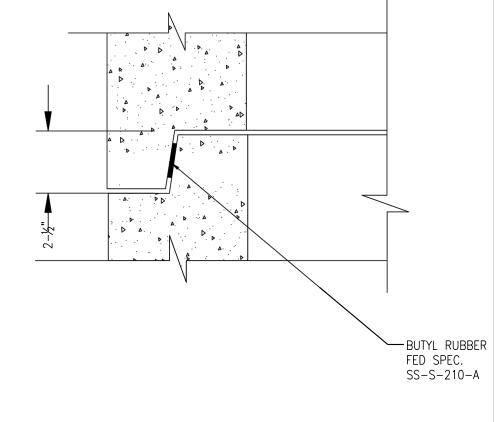


PRECAST WALL JOINT DETAIL

COPOLYMER POLYPROPLENE PLASTIC 1/2 " GRADE 60 STEEL REINFORCEMENT -

- 1. STEEL REINFORCED PLASTIC MANHOLE STEPS SHALL BE DROP FRONT DESIGN OR APPROVED EQUAL.
- 2. THE PORTION TO BE IMBEDDED IN THE CONCRETE SHALL BE COATED WITH COAL TAR PITCH OR OTHER APPROVED MATERIAL AND SHALL BE IN
- ACCORDANCE WITH THE LATEST O.S.H.A. STANDARDS (3" MINIMUM IMBEDMENT) 3. ALL MANHOLE STEPS TO MEET OR EXCEED ASTM AND O.S.H.A. REQUIREMENTS
- 4. FOR ROADWAY LOCATIONS STEPS SHALL BE ORIENTED TO ALLOW VIEWING OF

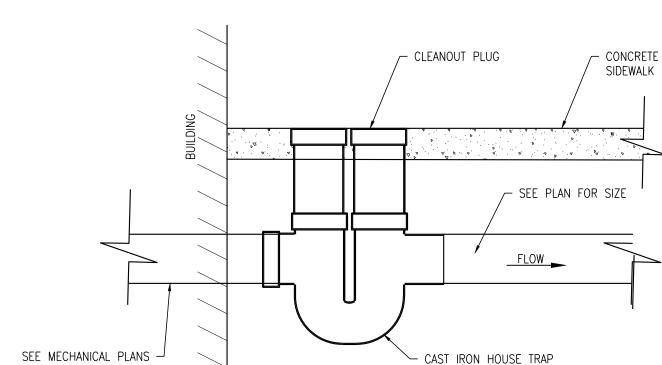ONCOMING TRAFFIC WHEN EXITING STRUCTURE.




1. IF TRAP IS 36" OR MORE BELOW SIDEWALK ELEVATION, CONSTRUCT A

HOUSE TRAP

- 2. CHAMBER SHALL BE A STANDARD 4' DIA. MANHOLE WITH ACCESS MANHOLE
- 3. NO CHANBER REQUIRED IF HOUSE TRAP IS LOCATED INSIDE THE BUILDING.

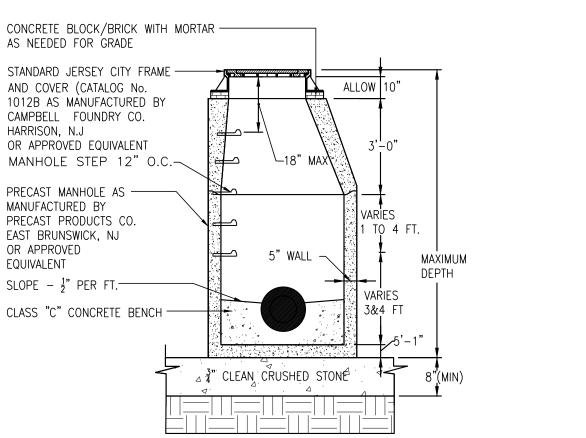POLYPROPLENE MANHOLE STEP



NOTES:

AS NEEDED FOR GRADE

CAMPBELL FOUNDRY CO.

OR APPROVED EQUIVALENT

PRECAST MANHOLE AS -

PRECAST PRODUCTS CO.

EAST BRUNSWICK, NJ

SLOPE $-\frac{1}{2}$ PER FT.

CLASS "C" CONCRETE BENCH -

MANUFACTURED BY

OR APPROVED

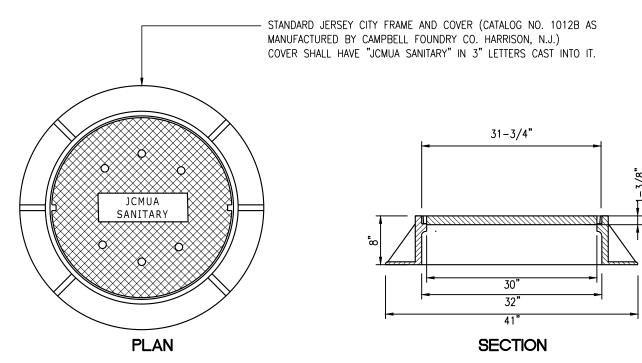
EQUIVALENT

HARRISON, N.J

STANDARD JERSEY CITY FRAME -AND COVER (CATALOG No. 1012B AS MANUFACTURED BY

MANHOLE STEP 12" O.C.

- 1. PRECAST MANHOLE SECTIONS TO BE IN ACCORDANCE WITH LATEST ASTM DESIGNATION MINIMUM COMPRESSION STRENGTH TO BE 4000 PSI
- 2. A-LOK CONNECTION OR FLEXIBLE RUBBER BOOT SHALL BE USED FOR CONNECTION OF PVC PIPE TO MANHOLE.
- 3. PRECAST CHANNELS SHALL NOT BE USED FOR BENDS GREATER THAN 45°. POURED CONCRETE LONG RADIUS CHANNELS SHALL BE CONSTRUCTED.
- 4. MANHOLE INSIDE DIAMETER SHALL BE 4 FT FOR UP TO 18" DIA. PIPE. STANDARD PRECAST SANITARY MANHOLE




1. MATERIAL: GRAY CAST IRON, ASTM A48-83, CLASS 35B.


5. CASTINGS SUPPLIED WITHOUT SURFACE COATING.

4. COVER SHALL HAVE NON-PENETRATING PICK HOLES AND SIX ¾" VENTS.

- 2. AASHTO HS25 HIGHWAY LOADING. 3. BEARING SURFACE AT SEAT OF COVER AND FRAME SHALL BE MACHINED FOR UNIFORM FIT.

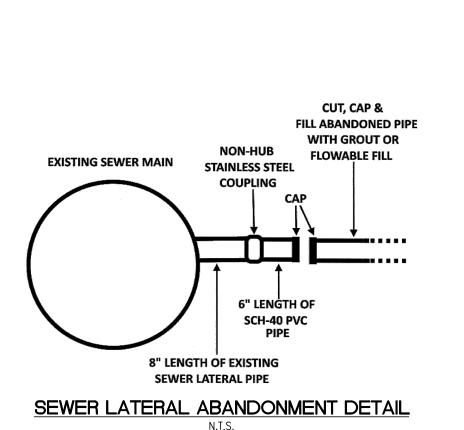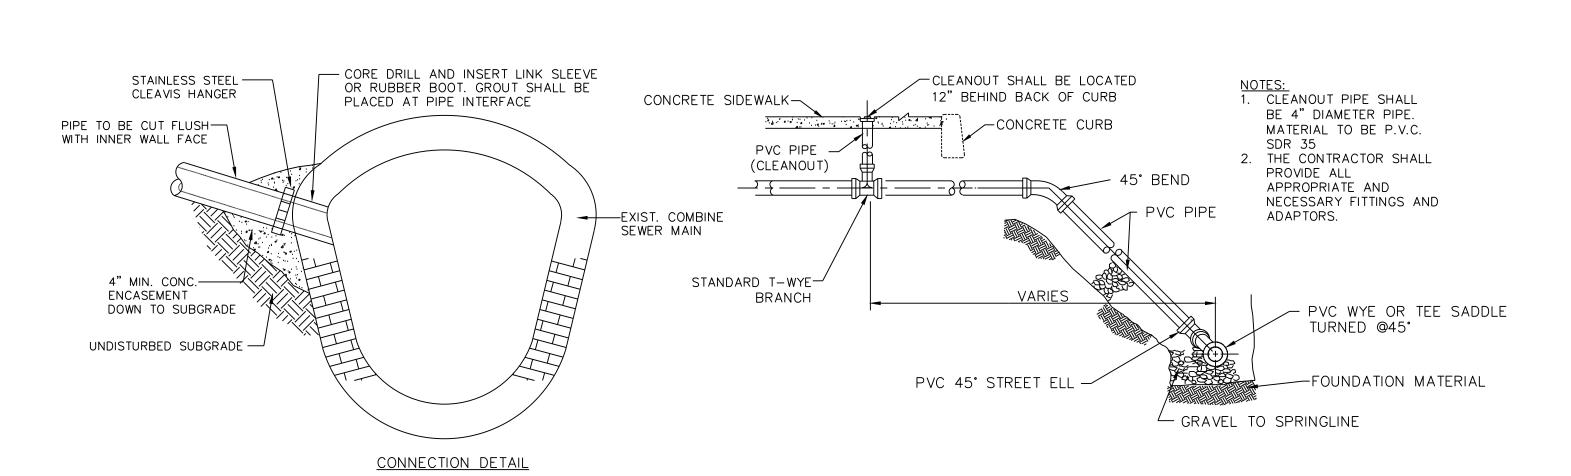SANITARY SEWER MANHOLE CASTING







. FOR MAJOR UTILITY WORK, REPAIR WIDTH AND LENGTH (MILLING AND PAVING) TO A MINIMUM OF 12" PAST TRENCH OPENING OR AS DETERMINED BY THE ENGINEER OR AS SHOWN ON THE PLANS 2. ALL MATERIALS AND WORK SHALL

PARTS LIST

2 SEAT

5 COVER

6 HINGE ARM

7 PIVOT LUG

8 BOLT/NUT

9 HINGE PINE

10 BUSHING

12 SPRING RING

— STANDARD MANHOLE

- INLET SANITARY LINE

— DROP NOT TO

INTERFERE WITH

LADDER RUNGS

DROP PIPE TO

EXTEND TO CHANNEL

SANITARY SEWER

COVER & RIM

1 3 CLEAN CRUSHED STONE

4'-0" DIA. MIN

2. CHANNEL DEPTH MUST BE 80% OF SEWER MAIN

AVOID CONFLICT WITH EACH OTHER.

3. LADDER RUNGS AND PIPING SHOULD BE PLACED TO

4. FOR 8" DIAMETER INLET PIPE USE 6" SDR DROP PIPE.

5. FOR 12" DIAMETER INLET PIPE AND LARGER USE 8" SDR

INSIDE-DROP MANHOLE

1. SLOPE BENCH TO CHANNEL.

3 RETAINER RIN

TO BE FÜRNISHED

BY CUSTOMER

NOTES: SEE PLAN FOR SIZE.

MANHOLE STEPS -

MANUFACTURED BY RELINER

OR EQUAL SECURED WITH

STAINLESS STEEL STRAPS -

SECURED TO STRUCTURE WITH

STAINLESS FASTENERS

STAINLESS FASTENERS

PVC DROP PIPE -

CONCRETE BENCH -

NOTES:

DROP PIPE.

INSIDE DROP BOWL -

NAME

FRAME

HEX. HD. 4 BOLT/NUT

HEX. HD.

WASHER

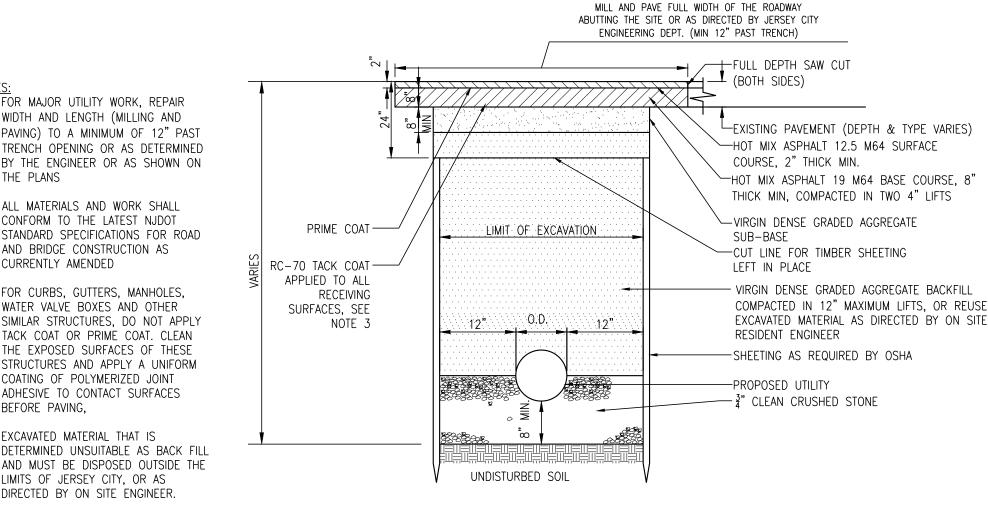
CURRENTLY AMENDED 3. FOR CURBS, GUTTERS, MANHOLES, WATER VALVE BOXES AND OTHER SIMILAR STRUCTURES, DO NOT APPLY TACK COAT OR PRIME COAT. CLEAN THE EXPOSED SURFACES OF THESE STRUCTURES AND APPLY A UNIFORM COATING OF POLYMERIZED JOINT ADHESIVE TO CONTACT SURFACES

CONFORM TO THE LATEST NJDOT


AND BRIDGE CONSTRUCTION AS

4. EXCAVATED MATERIAL THAT IS DETERMINED UNSUITABLE AS BACK FILI AND MUST BE DISPOSED OUTSIDE THE LIMITS OF JERSEY CITY, OR AS DIRECTED BY ON SITE ENGINEER.


BEFORE PAVING,



TYPICAL TRENCH

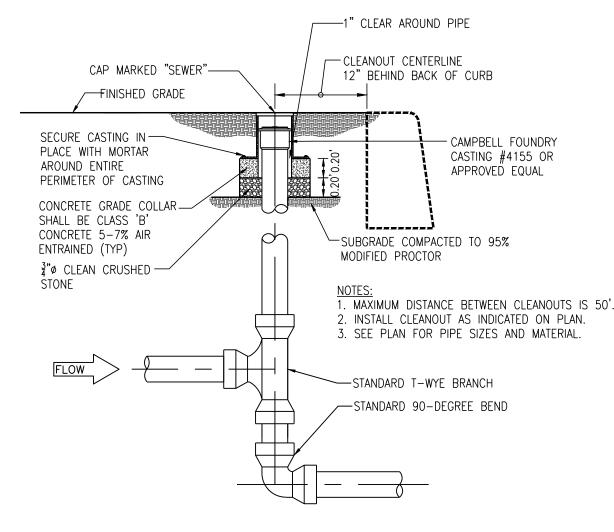

SANITARY DROP CLEANOUT

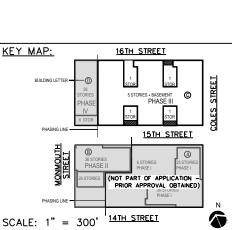

AS SHOWN CHECKED BY: JDR



SUES:			ISSUES:			SUES:		
DESCRIPTIONS	DATE	NO.	DESCRIPTIONS DATE NO. DESCRIPTIONS		DESCRIPTIONS	DATE		
		31	UPDATED UTILITY LAYOUT	03.14.22	21	REVISED STORM PIPE MATERIALS PER AVAILABILITY	06.30.21	
		32	EMERSON PHASE III - RED LINE	04.26.22	22	UPDATED PHASE II PER ARCHATECTS	08.12.21	
		33	UPDATED GROUND FLOOR BUILDING LAYOUT	05.14.22	23	REVISED BUMPOUT WIDTH AT 15TH STREET	08.26.21	
		34	EMERSON PHASE II - BUILDING PERMIT SUBMISSION	07.12.22	24	ADDED CONCRETE ADA RAMPS	09.13.21	
		35	EMERSON COMPLEX - LIGHTING PLAN UPDATE	12.05.22	25	UPDATED LIGHTING	11.03.21	
		36	PHASE III - GAS & TELECOM LATERAL UPDATE	03.13.23	26	PH III - BUILDING PERMIT	11.18.21	
		37	PHASE III - REDLINE UPDATE	04.26.23	27	PH II CRANE - UPDATE	01.04.22	
		38	PHASE III - REDLINE UPDATE	07.17.23	28	REVISED 14TH STREET	01.05.22	JE
		39	PHASE II - ENTRANCE STAIR ELEVATION UPDATE	08.29.23	29	REVISED 14TH ST SOUTH CURB PER AS-BUILT COND.	01.28.22	N.J. LIC
		40	PHASE III - SITE PLAN AMENDMENT SUBMISSION	09.18.23	30	REVISED PH II GRADES	01.28.22	All rights reserved. The Dr They not be copied, altere

EMERSON LOFTS PHASE III BLOCK 6903, LOTS 3.04 **255-259 COLES STREET,**

DRAWING TITLE SANITARY SEWER DETAILS DRAWING NUMBER:

FFREY D. REEVES . 01.28.22 PROFESSIONAL ENGINEER
N.J. LICENSE NUMBER 24GE04036700
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JERSEY CITY, HUDSON COUNTY, NJ.

by Jeffrey

Doeses Date: 2023.11.28 11:07:38-05'00'

DRAWN BY

Certificate of Authorization # 24GA28287900

WATER DISTRIBUTION SYSTEM STANDARDS

- WATER MAINS SHALL BE PRESSURE CLASS 350 (WITH WALL CLASS 54) CEMENT LINED, DUCTILE IRON PIPE WITH MECHANICAL JOINTS AND SHALL BE IN CONFORMANCE WITH A.N.S.I. STANDARD A21.5-1976 (A.W.W.A. C151-76). ALL WATER MAINS WILL BE AT LEAST 8" IN DIAMETER. TEN (10") AND 14" DIAMETER MAINS SHALL NOT BE USED.
- 2. GATE VALVE SHALL BE IN CONFORMANCE WITH A.N.S.I./A.W.W.A. C509 BY MUELLER COMPANY A2362 RESILIENT WEDGE GATE VALVES, 2"-12". VALVES SHALL BE NON-RISING STEM, MECHANICAL JOINT SHALL BE FURNISHED WITH A (2") SQUARE OPERATING NUT SHALL OPEN BY TURNING TO THE RIGHT. GATE VALVES (16") AND OVER SHALL BE FURNISHED WITH BY-PASS. VALVE SHALL BE 100% SOLID HEAT CURED EPOXY COATED HOLIDAY-FREE IN THE WATERWAY.
- 3. BUTTERFLY VALVES SHALL BE IN CONFORMANCE WITH A.N.S.I./A.W.W.A. STANDARD C504-80. BUTTERFLY VALVES SHALL BE CLASS 1508, MECHANICAL JOINT, WITH RUBBER SEAT MOUNTED ON THE DISC, SHALL BE FURNISHED WITH A (2") INCH SQUARE OPERATING NUT AND SHALL OPEN BY TURNING TO THE RIGHT. THE VALVE SHALL BE 100% SOLID HEAT CURED EPOXY COATED HOLIDAY-FREE IN THE WATERWAY. THE USE OF BUTTERFLY VALVES WILL NOT BE PERMITTED IN MAINS (16") AND UNDER.
- 4. VALVES BOXES SHALL BE JERSEY CITY "STANDARD" AS MANUFACTURED TYLER UNION6855 SERIES, OR APPROVED EQUIVALENT. BOXES SHALL HAVE A MINIMUM OF 8-1/4 INCH DIAMETER AND SHALL BE AN ADJUSTABLE SCREW TYPE WITH THE BOX EXTENDING FROM THE SURFACE TO (3") INCHES ABOVE THE VALVE BONNET BASE. VALVE BOX SHALL BE CAST IRON WITH A STANDARD COAL TAR FOUNDRY DIP WITH CAST IRON WATER DROP COVER AND THE WORD "WATER" CAST IN COVER. VALVE BOX COVER SHALL BE INSTALLED FLUSH WITH THE EXISTING
- 5. CONCRETE FOR VALVE SEATS AND THRUST BLOCKS SHALL HAVE A MINIMUM 28-DAY STRENGTH OF 3000 PSI.
- 6. SELECT GRANULAR BACKFILL MATERIAL SHALL BE SOIL AGGREGATE TYPE I-6 (POROUS FILL, CLEAN SAND, GRAVEL OR STONE) OBTAINED FROM DRY SOURCES AND SHALL BE FREE FROM STUMPS, BRUSH, WEEDS, ROOTS, RUBBISH, WOOD AND OTHER MATERIAL THAT MAY DECAY. GRADUATION SHALL CONFORM TO TABLE 901-2, FOR TYPE I-6 IN ARTICLE 901.09 OF THE (N.J.D.O.T.) NEW JERSEY DEPARTMENT OF TRANSPORTATION STANDARD SPECIFICATIONS. BACKFILL MATERIAL SHALL BE PLACED AND COMPACTED IN TWELVE (12") INCH LIFTS.
- 7. TIE RODS SHALL BE THREE QUARTER (3/4) INCH DIAMETER THREADED STEEL BARS. RODS SHALL HAVE A MINIMUM YIELD STRESS OF 36,000 PSI. THRUST BLOCKS AND TIE RODS SHALL BE INSTALLED AT ALL BENDS AND FITTINGS.
- 8. COUPLINGS SHALL BE DRESSER STYLE NUMBER 153 FOR PIPE SIZES THROUGH (30") INCH DIAMETER. FOR LARGER DIAMETER PIPE, DRESSER STYLE NUMBER 38 STEEL COUPLINGS SHALL BE USED.
- 9. SHEETING, SHORING AND BRACING SHALL BE CLOSED VERTICAL SHEETING. TONGUE AND GROOVE WHICH IS BRACED TO PREVENT THE CAVE-IN OF TRENCHES. ALL LABOR EQUIPMENT, MATERIALS AND METHODS OF CONSTRUCTION SHALL CONFORM TO THE REQUIREMENTS OF
- THE UNITED STATES OCCUPATIONAL SAFETY AND HEALTH ADMINISTRATION. MATERIALS FOR SHEETING SHALL BE TONGUE AND GROOVE WOODEN PLANKS AND TIMBER OR STEEL CONFOMING TO THE REQUIREMENTS OF
- 10. BROKEN STONE FOUNDATION CUSHION SHALL BE PLACED IN THOSE AREAS WHERE THE SITE ENGINEER HAS DEEMED THE SOIL CONDITIONS INFERIOR. BROKEN STONE SHALL CONFORM TO ARTICLE 901.03 OF THE STANDARD SPECIFICATIONS AS CURRENTLY AMENDED. THE SIZE OF BROKEN STONE SHALL BE AS SHOWN ON THE PLANS OR AS DIRECTED BY THE SITE ENGINEER FOR SIZE NUMBER 2. 4. 5. OR 6 AS SHOWN IN TABLE 901-1. STANDARD SIZES OF COARSE AGGREGATES OF THE NEW JERSEY DEPARTMENT OF TRANSPORTATION STANDARD
- 11. FILTER CLOTH SHALL BE PLACED IN THOSE AREAS WHERE THE SITE ENGINEER HAS DEEMED THE SOIL CONDITIONS INFERIOR. 12. AFTER THE SITE ENGINEER HAS INSPECTED THE COMPLETED INSTALLATION OF VALVES, AND WATER MAIN, AND BEFORE BACKFILLING THE

THE UNITED STATES OCCUPATIONAL SAFETY AND HEALTH ADMINISTRATION TIMBER SHALL BE A MINIMUM OF 3" THICK.

- EXCAVATIONS, THE CONTRACTOR SHALL FURNISH ALL LABOR, MATERIALS AND EQUIPMENT REQUIRED TO PRESSURE TEST THE PIPE. THE PIPE SHALL BE PRESSURIZED TO 1.5 X THE WORKING PRESSURE FOR A PERIOD OF TWO (2) HOURS. THERE SHALL BE NO PRESSURE DROP IN ANY VARIATIONS. THE VALVED SECTION OF PIPE SHALL BE FILLED WITH WATER SLOWLY, AND THE TEST PRESSURE SHALL BE APPLIED BY MEANS OF A PUMP CONNECTED TO THE PIPE IN A MANNER SATISFACTORY TO THE SITE ENGINEER. BEFORE APPLYING THE TEST PRESSURE, AIR SHALL BE EXPELLED COMPLETELY FROM THE PIPE BY INSTALLING CORPORATION COCKS AT SUCH POINTS SO THAT THE AIR CAN BE EXPELLED AS THE LINE IS FILLED WITH WATER. IF THE JOINTS LEAK, REPAIRS OR REPLACEMENTS SHALL BE MADE. TESTING SHALL BE IN CONFORMANCE WITH A.W.W.A. STANDARD C600-77.
- 13. THE CONTRACTOR SHALL DISINFECT ALL WATER MAINS IN ACCORDANCE WITH A.W.W.A. STANDARD FOR "DISINFECTING WATER MAINS" DESIGNATION C-601. COMMERCIAL PRODUCTS SUCH AS "HTH", "PERCHLARON", AND "MAXOXHLOR" MAY BE USED IN FLAKE OR CRYSTAL FORM BUT IN NO INSTANCE WILL TABLETS BE PERMITTED TO BE USED IN THE DISINFECTION OF WATER MAINS.
- THE CHLORINE DOSAGE SHALL INITIALLY PRODUCE 50 PPM RESIDUAL TO THE WATER AND MAINTAIN A MINIMUM RESIDUAL OF 25 PPM AFTER 24 HOURS. AFTER SATISFACTORY DISINFECTION OF THE TEST SECTION, THE LINE SHALL BE CONTINUOUSLY FLUSHED UNTIL THE RESULTANT CHLORINE RESIDUAL EQUALS ONE PPM OR THE RESIDUAL OF THE SYSTEM, WHICHEVER IS GREATER. AFTER FINAL FLUSHING AND BEFORE THE WATER MAIN IS PLACED IN SERVICE SAMPLES SHALL BE COLLECTED FROM EACH END OF THE MAIN AND TESTED FOR BACTERIOLOGIC QUALITY. IF THE INITIAL DISINFECTION FAILS TO PRODUCE SATISFACTORY SAMPLES, DISINFECTION SHALL BE REPEATED UNTIL SATISFACTORY SAMPLES HAVE BEEN OBTAINED.
- 14. AIR RELEASE VALVES SHALL BE INSTALLED AT THE HIGH POINTS OF THE WATER MAINS.

SPECIFICATIONS.

- 15. ALL WATER MAINS SHALL BE AT LEAST 8" IN DIAMETER. TEN (10") AND 14" DIAMETER MAINS SHALL NOT BE USED.
- 16. THRUST BLOCKS AND TIE RODS SHALL BE INSTALLED AT ALL BENDS AND FITTINGS OR MEGALUG RESTRAINT JOINT.
- 17. FOR EITHER NEW CONSTRUCTION OR RELOCATION THE FOLLOWING SHALL BE REQUIRED:
- A. HYDRANTS SHALL BE LOCATED NO CLOSER THAN 20 FEET FROM THE POINT OF TANGENCY OR CURVATURE AT INTERSECTIONS. B. ALL ONE PIECE FIRE HYDRANTS NOT MANUFACTURED BY MUELLER CO. MODEL NO. A-423 THAT ARE TO BE RELOCATED SHALL BE REMOVED AND DELIVERED TO THE JERSEY CITY DIVISION OF WATER DISTRIBUTION. A NEW HYDRANT WILL BE SUPPLIED BY THE CITY C. HYDRANTS SHALL BE NO CLOSER THAN TEN (10') FEET FROM THE EDGE OF A RESIDENTIAL DRIVEWAY OR (20') FEET FROM THE EDGE OF COMMERCIAL DRIVEWAY. IN THE CASE WHERE DRIVEWAYS ARE EXPANDED OR NEWLY CONSTRUCTED, THE OWNER SHALL BE RESPONSIBLE FOR THE RELOCATION OF AN EXISTING HYDRANT IF ABOVE REQUIREMENTS ARE VIOLATED. D. ALL SINGLE GATED HYDRANTS ON (16") INCH OR LARGER MAINS SHALL REQUIRE A NEW VALVE AT THE BASE OF THE RELOCATED

E. NEW GATE VALVES AND BOXES ARE REQUIRED AT THE BASE OF RELOCATED HYDRANTS WHEN MORE THAN (10') FEET OF PIPE IS

- 18. ALL FIRE HYDRANTS SHALL BE TWO (2) PIECE "JERSEY CITY STANDARD" HYDRANTS, AS MANUFACTURED MUELLER CO. MODEL NO. A-423. 19. EXISTING WATER SERVICE LINES SHALL BE SHUT-OFF AND CAPPED AT THE MAIN PRIOR TO THE INSTALLATION OF NEW WATER SERVICES.
- 20. WATER MAINS TO BE ABANDONED SHALL BE CUT AND PLUGGED WITH REQUIRED FITTINGS, RODS AND CONCRETE AS CLOSE TO THE EXISTING MAIN IN SERVICE AS POSSIBLE.

PRIOR TO NEW SERVICE TAP THE JERSEY CITY WATER DEPARTMENT SHALL INSPECT AND CERTIFY THE ABANDONED SERVICES.

- 21. ALL VALVES SHALL BE OPERATED BY SUEZ WATER PERSONNEL. THE CONTRACTOR SHALL NOT BE PERMITTED TO OPERATE ANY VALVES. THE CONTRACTOR SHALL NOTIFY SUEZ WATER AT (201) 239-1108, AND IN WRITING AT 233 COLES STREET JERSEY CITY, NT 07310, FIVE (5) DAYS IN ADVANCE OF VALVE OPERATING REQUIREMENTS.
- 22. FAILURE TO COMPLY WITH THE ABOVE REQUIREMENTS WILL RESULT IN THE IMMEDIATE SHUTDOWN OF THE PROJECT.

REQUIREMENTS FOR FIRE AND DOMESTIC WATER LINE AND METER INSTALLATIONS

HOWEVER, ONLY ONE WATER BILL WILL BE ISSUED FOR THE FACILITY.

TAP IS MADE.

- 1. ALL FIRE SERVICE APPLICATIONS AND ALL DOMESTIC SERVICE APPLICATIONS TWO (2) INCHES AND LARGER MUST BE SUBMITTED TO THE JCMUA'S BUREAU OF WATER ENGINEERING FOR APPROVAL. FIVE (5) SETS OF PLANS SHALL BE SUBMITTED FOR APPROVAL. ALL PLANS SHALL BE SIGNED AND SEALED BY A PROFESSIONAL ENGINEER OR REGISTERED ARCHITECT LICENSED TO PRACTICE IN NEW
- 2. SUBMITTED PLANS SHALL BE STANDARD ENGINEERING DRAWINGS, SIZE 24 INCHES X 36 INCHES. INCLUDED SHALL BE A SITE PLAN SHOWING ADJACENT STREET WITH WATER MAIN, SERVICE, AND DETAILS INDICATED. ALSO INCLUDED SHALL BE A KEY MAP SHOWING GENERAL LOCATION WITHIN THE CITY.
- 3. INDICATED ON THE SUBMITTED PLANS SHALL BE THE SIZE OF TAP, LOCATION OF TAPPING AND THE CURB GATE VALVES. DETAILED METER SET-UP, AND SIZE OF FACILITY'S METER. ALSO INDICATED ON THE PLANS SHALL BE THE TYPE OF OCCUPANCY OF THE FACILITY RECEIVING THE WATER SERVICE. (I.E. HOSPITAL, WAREHOUSE, APARTMENTS BUILDING, ECT.)
- 4. ALL EXISTING WATER SERVICE LINES TO BE ABANDONED SHALL BE CUT AND CAPPED AT THE MAIN, IN ACCORDANCE WITH JCMUA STANDARDS, AND INSPECTED WITHIN 24 HOURS AFTER INSTALLATION OF NEW TAP. THE MAXIMUM OF ONE (1) TAP SHALL BE MADE FOR BOTH DOMESTIC AND FIRE SERVICE PER FACILITY. THE TAP SHALL BE THE MAXIMUM OF ONE (1) SIZE SMALLER THAN THE CITY'S WATER MAIN. NO TAPPING SHALL BE DONE BY ANYONE EXCEPT BY SUEZ WATER UNLESS SPECIFICALLY APPROVED BY JCMUA. 5. ONLY ONE DOMESTIC/FIRE SERVICE IS ALLOWED FOR EACH FACILITY. APPLICANT MAY INSTALL CHECK METERS ON INDIVIDUAL BRANCH CONNECTIONS DOWNSTREAM OF DOMESTIC METER SETUP WHERE THERE IS MORE THEN ONE OWNER/TENANT FOR A FACILITY.
- 6. A SOLID DUCTILE IRON TAPPING SLEEVE SUCH AS MUELLER H-615 TAPPING SLEEVE OR APPROVED EQUIVALENT SHALL BE UTILIZED FOR ALL TAPS 2-INCHES AND LARGER. THE TAPPING SLEEVE SHALL PASS PRESSURE TESTING BASED ON AWWA STANDARDS BEFORE
- 7. FOR ALL SERVICES INCLUDED HEREIN, TWO (2) GATE VALVES ARE REQUIRED THAT ARE TO BE INSTALLED BY THE APPLICANT; A TAPPING VALVE, LOCATED AT THE TAP AND CURB VALVE, LOCATED IN THE SIDEWALK BEFORE THE METER. TAPPING GATES SHALL BE FURNISHED OPENED RIGHT. TAPPING AND CURB VALVES SHALL BE DOUBLE DISC GATE VALVES OR A-2362 RESILIENT WEDGE GATE VALVES AS MANUFACTURED BY MUELLER CO. OR APPROVED EQUIVALENT AND MEET AWWA STANDARDS. THE WET TAP UP TO 12 INCHES SHALL BE PERFORMED BY SUEZ WATER.
- 8. FOR TAPS OFF MAINS SIXTEEN (16) INCHES AND LARGER, THE CONTRACTOR SHALL FURNISH AND INSTALL AN ADDITIONAL GATE VALVE ADJACENT TO THE TAPPING VALVE. NO TAPS SHALL BE PERMITTED ON MAINS LARGER THAN TWENTY (20) INCHES UNLESS

THERE IS NO ALTERNATIVE WATER SOURCE, AND SPECIAL WRITTEN APPROVAL IS ISSUED BY THE JCMUA.

- 9. VALVE BOX PARTS FOR ALL VALVES SHALL BE PROVIDED BY THE CONTRACTOR. ALL TAPPING GATE VALVES LARGER THAN 2-INCHES AND ALL CURB VALVES/STOPS REGARDLESS OF SIZE REQUIRE A VALVE BOX WITH THE WORD "WATER" CAST IN THE COVER. BURIED CORPORATION VALVES/ STOPS SHALL BE USED AT THE TAP FOR CLASS K COPPER SERVICES 2-INCHES AND SMALLER.
- 10.ALL SERVICE PIPES, SIZES 2-INCHES THROUGH 12-INCHES, SHALL BE PRESSURE CLASS 350 PSI, THICKNESS CLASS 54 CEMENT-LINED DUCTILE IRON PIPE WITH MECHANICAL JOINTS.
- 11. THE APPLICANT SHALL INSTALL THE METER INSIDE THE BUILDING. IF THE BUILDING LINE IS IN EXCESS OF 75 FT. FROM THE MAIN, THE APPLICANT SHALL PLACE THE METER IN A PIT NEAR THE SIDEWALK OR STREET IN CLOSE PROXIMITY TO THE TAP. 12.FOR A REGULAR FIRE SUPPRESSION SYSTEM, A COMBINED REDUCED PRESSURE DETECTOR ASSEMBLY (WATTS 909 RPDA*) SHALL BE INSTALLED ON THE MAIN FIRE SERVICE LINE AND A REDUCED PRESSURE BACKFLOW PREVENTOR ON THE BYPASS (AMES 400SS OR WATTS 909*). ON THE LIMITED FIRE SUPPRESSION SYSTEM, A FIRE LINE DETECTOR CHECK WITH A SINGLE CHECK VALVE (AMES 1000DCV*) SHALL BE INSTALLED ON THE MAIN FIRE LINE AND A REDUCED PRESSURE BACKFLOW PREVENTER (WATTS 909*) SHALL BE INSTALLED DOWNSTREAM OF THE BYPASS. ALL FIRE SERVICES MUST HAVE OS&Y VALVES INSTALLED. THE FIRE UNIT SHALL BE
- SENSUS METERS WITH TOUCHPAD AND RADIO READ CAPABILITIES. THE SAME RADIO MXU UNIT SHALL BE USED FOR A COMBINED 13.FOR DOMESTIC SERVICE, AN APPROVED REDUCED PRESSURE BACKFLOW PREVENTER (AMES 4000SS OR WATTS 909*) IS REQUIRED WHEN THE JCMUA DETERMINES THAT THERE IS A CROSS-CONNECTION HAZARD AND THE FACILITY PRESENTS A THREAT TO THE CITY'S DISTRIBUTION SYSTEM WATER QUALITY IN ACCORDANCE WITH THE PLUMBING SUB CODE OF THE NEW JERSEY STATE UNIFORM CONSTRUCTION CODE, NJAC 5:23-3.15 AND THE NEW JERSEY SAFE DRINKING WATER ACT NJAC 7:10-10 PHYSICAL CONNECTIONS

FURNISHED WITH A 5/8 INCH x INCH METERED BYPASS. BYPASS METERS SHALL BE JERSEY CITY STANDARD SINGLE DISPLACEMENT

SCHOOL, CHEMICAL PLANT, FACTORY, AND A FACILITY WITH SEWAGE EJECTORS. 14.ALL METERS SIZES 2 INCHES THROUGH 6 INCHES SHALL BE SINGLE COMPOUND METERS AND ALL METERS 8 INCHES AND LARGER

AND CROSS CONNECTIONS CONTROL BY CONTAINMENT. SOME SERVICES, WHICH REQUIRE SUCH DEVICES INCLUDE: A HOSPITAL,

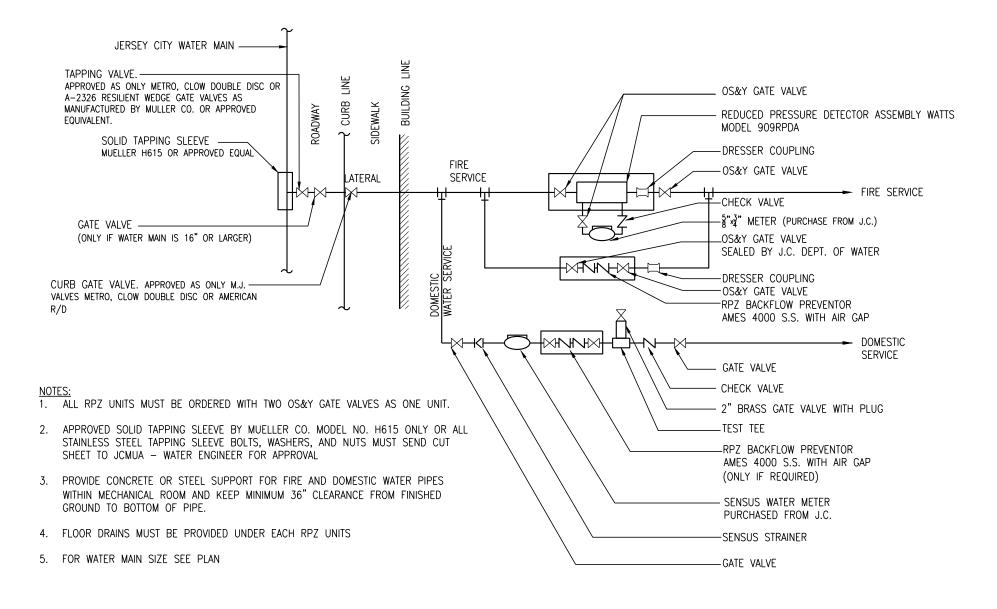
- 15.ALL METERS SHALL BE ADEQUATELY RESTRAINED WITH METAL BRACKETS FASTENED TO THE FLOOR OR WALL OR OTHER APPROVED MEANS SUCH AS UNIFLANGES WHERE INTERNAL PIPE PRESSURE AND FLOW WARRANT SUCH RESTRAINTS. METERS, DETECTOR CHECKS, AND VALVES MAY BE SEATED ON CONCRETE BLOCK AND TAPERED SHIMS TO PROVIDE ADEQUATE SUPPORT. METERS SHALL BE
- 16.ALL METER INSTALLATIONS IN METER PIT OR VAULT SHALL BE PRE-APPROVED BY JCMUA AND HAVE PROPER ACCESS OPENINGS
- FOR METER READING AND REPLACEMENT. 17.EACH COMPOUND METER SHALL HAVE STRAINER INSTALLED ON THE INLET SIDE IMMEDIATELY BEFORE THE METER. ALL STRAINERS
- 18.ALL METERS 2" AND LARGER SHALL BE FURNISHED WITH SENSUS ECR/WP REMOTE TOUCH PAD MODULES AND RADIO MXU UNITS
- 19.REMOTE TOUCH PAD MODULE WIRE SHALL BE CONNECTED TO THE METER REGISTER UTILIZING A GEL CAP FOR WATERTIGHT SEALING OF ALL TERMINAL CONNECTIONS, TOUCH PADS MAY BE WALL MOUNTED OR LID MOUNTED WHERE A METER PIT IS UTILIZED. TOUCH PADS ARE TO BE INSTALLED ON EXTERIOR BUILDING WALL FACING THE STREET AND LOCATED AS CLOSE AS POSSIBLE TO STREET. THE RADIO MXU UNIT MUST BE INSTALLED WITH MOUNTING BRACKET AND LIKEWISE IS TO BE INSTALLED IN PROXIMITY TO STREET.
- 20.ALL INSTALLATIONS OF EQUIPMENT AND COMPONENTS SHALL BE PERFORMED IN ACCORDANCE WITH MANUFACTURER'S RECOMMENDATIONS.
- 21.ALL METERS INCLUDING TOUCH PAD MODULES, AND RADIO MXU UNITS SHALL BE PURCHASED THROUGH THE PERMIT CLERK AT JCMUA OFFICE. APPROVED PLANS MUST BE SUBMITTED TO THE PERMIT CLERK FOR ISSUANCE OF REQUIRED PERMITS.
- 22.AFTER OBTAINING THE REQUIRED PERMITS (STREET OPENING, TAP, AND METER) THE APPLICANT SHALL CALL JCMUA AT (201) 239-1108 TO SCHEDULE THE TAP. THE EXCAVATION SHALL BE COMPLETED TWENTY-FOUR (24) HOURS PRIOR TO THE SCHEDULED TAP, AND VERIFIED BY JCMUA OR ITS AUTHORIZED AGENT BEFORE THE TAP WILL BE INSTALLED. EXCAVATION SHALL BE CONSTRUCTED IN ACCORDANCE WITH OSHA REQUIREMENTS FOR SHEETING AND SAFETY.
- 23.UPON COMPLETION OF THE INSTALLATION, THE APPLICANT SHALL SUBMIT THREE (3) SETS OF "AS BUILT" PLANS, TO THE JCMUA'S BUREAU OF WATER ENGINEERING. THE JCMUA WILL AUTHORIZE SUPPLY WATER UPON ACCEPTANCE OF THE "AS BUILT" DRAWINGS.
- * SPECIFIED MODEL OR APPROVED EQUIVALENT.

SHALL BE DUPLEX COMPOUND MANIFOLD METERS.


INSTALLED APPROXIMATELY 36" ABOVE FLOOR GRADE.

FOR BOTH TYPES OF READING CAPABILITIES

MUST BE PURCHASED FROM JCMUA OR ITS AUTHORIZED AGENT.



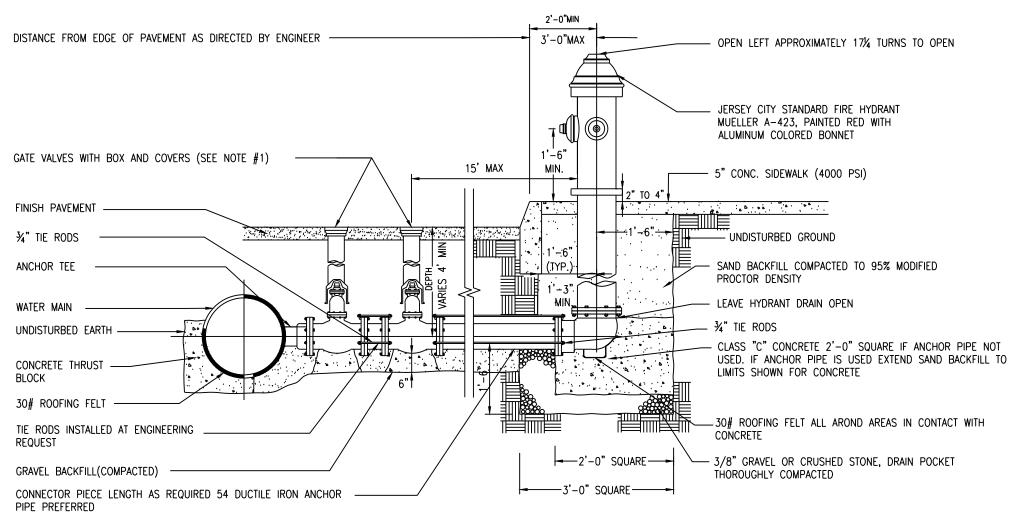COMBINED WATER SYSTEM SOURCE: JERSEY CITY STANDARD DETAIL



1. DOUBLE GATE VALVE REQUIRED WHEN EXISTING WATER MAIN IS 16" DIAMETER OR LARGER.

2. $5-\frac{1}{4}$ " MAIN VALVE OPENING.

3. (2) 2-3/8" HOSE NOZZLES GA 8-289 WITH 11/2" PENTAGON NUTS ON THE HOSE NOZZLE CAPS.

4. (1) 4-¼" PUMPER NOZZLE GA 4-497 WITH A 1½" PENTAGON NUT ON THE PUMPER NOZZLE CAP.

5. 1½" PENTAGON OPERATING NUT OPENS LEFT. 6. 5" MJ SHOE.


FIRE HYDRANT SOURCE: JERSEY CITY STANDARD DETAIL

THRUST BLOCK NOTES:


- 1. BEARING AREA FOR THRUST BLOCKS ARE BASED ON THE UNDISTURBED SOIL WITH BEARING CAPACITY OF 1000 LBS. PER SQUARE FOOT. FOR SOIL OF LESS BEARING CAPACITY THE AREAS SHALL BE ADJUSTED ACCORDINGLY (FIGURE 14, ASCE "PIPELINE
- DESIGN FOR WATER AND WASTEWATER, 1975")
- 2. ALL CONCRETE FOR THRUST BLOCKS SHALL BE NJDOT, CLASS C. 3. DIMENSIONS OF THRUST BLOCKS SHALL BE APPROXIMATELY SQUARE, AND THE TRUST BLOCKS SHALL BE POURED FROM FITTING SUCH THAT THEY BEAR ON THE UNDISTURBED WALL OF THE TRENCH.
- 4. THE TABULATED CONTACT BEARING AREAS LISTED ARE FOR HORIZONTAL AND DOWNWARD THRUST ONLY, AND ARE NOT ACCEPTABLE FOR UPWARD THRUST.
- 5. SIZE AND BEARING AREA FOR THRUST BLOCKS SHALL CONFORM TO "CURRENT AWWA STANDARDS" AND SHALL BE DESIGNATED ON THE PLANS.
- 6. TIDE RODS MUST BE COATED IN BITUMASTIC.
- 7. THRUST BLOCKS AND TIE RODS SHALL BE INSTALLED AT EACH BEND AND HYDRANT. 8. TRENCH MUST BE FULLY RESTORED. SEE ROADWAY TRENCH DETAILS.

THRUST BLOCK TABLE										
METER (d) OF PIPE (INCHES)	UP TO 22.5° BEND	UP TO 45° BEND	UP TO 90° BEND	TEES AND PLUGS	DEAD END TEE AND 90° BEND					
	22.5°	45.0°	90.0°	d						
CONTACT BEARING AREA OF THRUST BLOCK WITH UNDISTURBED EARTH (SQUARE FEET)										
4		1.2	2.1	1.5	A: 1.5 B: 0.6					
6	1.2	2.4	4.5	3.3	A: 3.3 B: 1.2					
8	2.1	4.2	8.1	5.7	A: 5.7 B: 2.4					
10	3.3	6.9	12.6	8.7	A: 8.7 B: 3.9					
12	5.1	9.9	18.0	12.6	A: 12.6 B: 5.4					
16	8.7	17.4	32.1	22.5	A: 22.5 B 9.6					
20	13.8	27.0	50.1	35.4	A: 35.4 B: 14.7					
24	19.8	39.0	72.0	51.0	A: 51.0 B: 21.0					

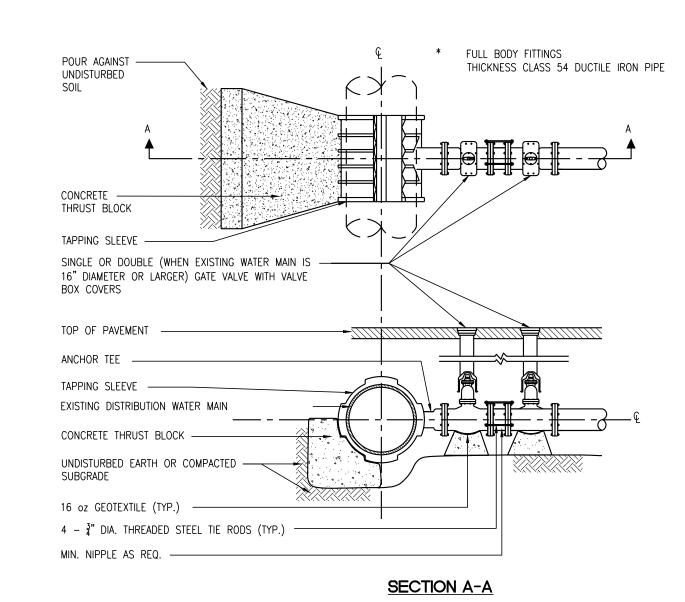THRUST BLOCKS SOURCE: JERSEY CITY STANDARD DETAIL



WATER MAIN CONNECTION

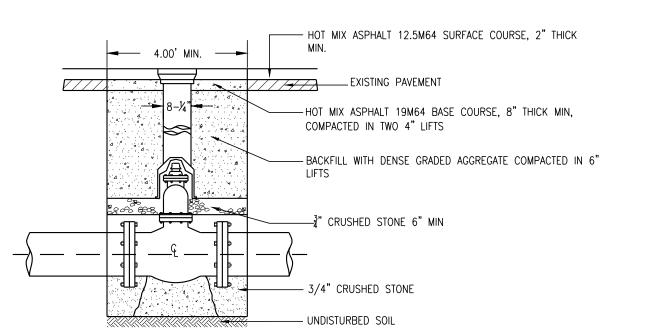



1. BOXES SHALL BE JERSEY CITY STANDARDS MANUFACTURED BY TYLER UNION AND SHALL BE A TWO PIECE ADJUSTABLE SCREW TYPE WITH THE WORD "WATER" CAST IN THE COVER OR

- 2. BOX MUST BE PLUMB AND CENTERED OVER VALVE
- 3. BOX MUST NOT BEAR ON VALVE TUBE, PIPE OR STOP
- 4. INTERMEDIATE BOX SECTIONS MAY BE REQUIRED ON DEEP VALVE SETTINGS


WATER MAIN VALVE AND BOX SOURCE: JERSEY CITY STANDARD DETAIL

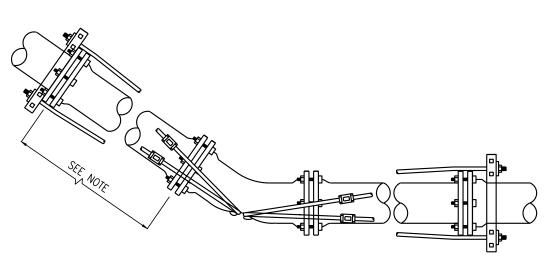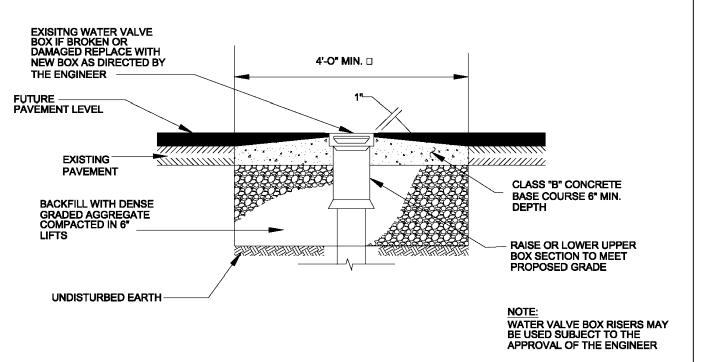IN THE ASSEMBLIES OF RODS AND CLAMPS SHOWN, RODS RUN FROM A LUG ON THE FITTING (OR A CLAMP BEHIND THE HUB OF A BELL) TO A CLAMP AGAINST A FACE OF A BELL. NOTE THAT THIS ARRANGEMENT ANCHORS ONLY ONE JOINT. THE STABILITY OF THE JOINT WHERE THE CLAMP IS AGAINST THE FACE OF THE BELL DEPENDS ON HAVING SOIL ABOVE A RELATIVELY LONG PIECE OF PIPE ON BOTH SIDES OF THE JOINT. CONSEQUENTLY, IF THE DISTANCE BETWEEN THE FIRST AND SECOND JOINTS IS LESS THAN 12 FEET, THE SECOND JOINT SHOWN SHALL BE ANCHORED BY A CLAMP BEHIND THE HUB OF THE BELL AND RODS TO A CLAMP AT THE FACE OF THE NEXT BELL.





RESET WATER VALVE BOX

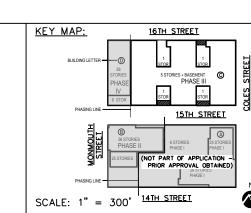

AS SHOWN CHECKED BY: JDR



SUE 2:			1220F2;			SUES:		
DESCRIPTIONS	DATE	NO.	DESCRIPTIONS	DATE	NO.	DESCRIPTIONS	DATE	
		31	UPDATED UTILITY LAYOUT	03.14.22	21	REVISED STORM PIPE MATERIALS PER AVAILABILITY	06.30.21	
		32	EMERSON PHASE III - RED LINE	04.26.22	22	UPDATED PHASE II PER ARCHATECTS	08.12.21	
		33	UPDATED GROUND FLOOR BUILDING LAYOUT	05.14.22	23	REVISED BUMPOUT WIDTH AT 15TH STREET	08.26.21	
		34	EMERSON PHASE II - BUILDING PERMIT SUBMISSION	07.12.22	24	ADDED CONCRETE ADA RAMPS	09.13.21	
		35	EMERSON COMPLEX - LIGHTING PLAN UPDATE	12.05.22	25	UPDATED LIGHTING	11.03.21	
		36	PHASE III - GAS & TELECOM LATERAL UPDATE	03.13.23	26	PH III - BUILDING PERMIT	11.18.21	
		37	PHASE III - REDLINE UPDATE	04.26.23	27	PH II CRANE - UPDATE	01.04.22	
		38	PHASE III - REDLINE UPDATE	07.17.23	28	REVISED 14TH STREET	01.05.22	JEF
		39	PHASE II - ENTRANCE STAIR ELEVATION UPDATE	08.29.23	29	REVISED 14TH ST SOUTH CURB PER AS-BUILT COND.	01.28.22	PI N.J. LICE
		40	PHASE III - SITE PLAN AMENDMENT SUBMISSION	09.18.23	30	REVISED PH II GRADES	01.28.22	All rights reserved. The Draw They not be copied, altered of
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EMERSON LOFTS PHASE III BLOCK 6903, LOTS 3.04 EFFREY D. REEVES 255-259 COLES STREET, PROFESSIONAL ENGINEER
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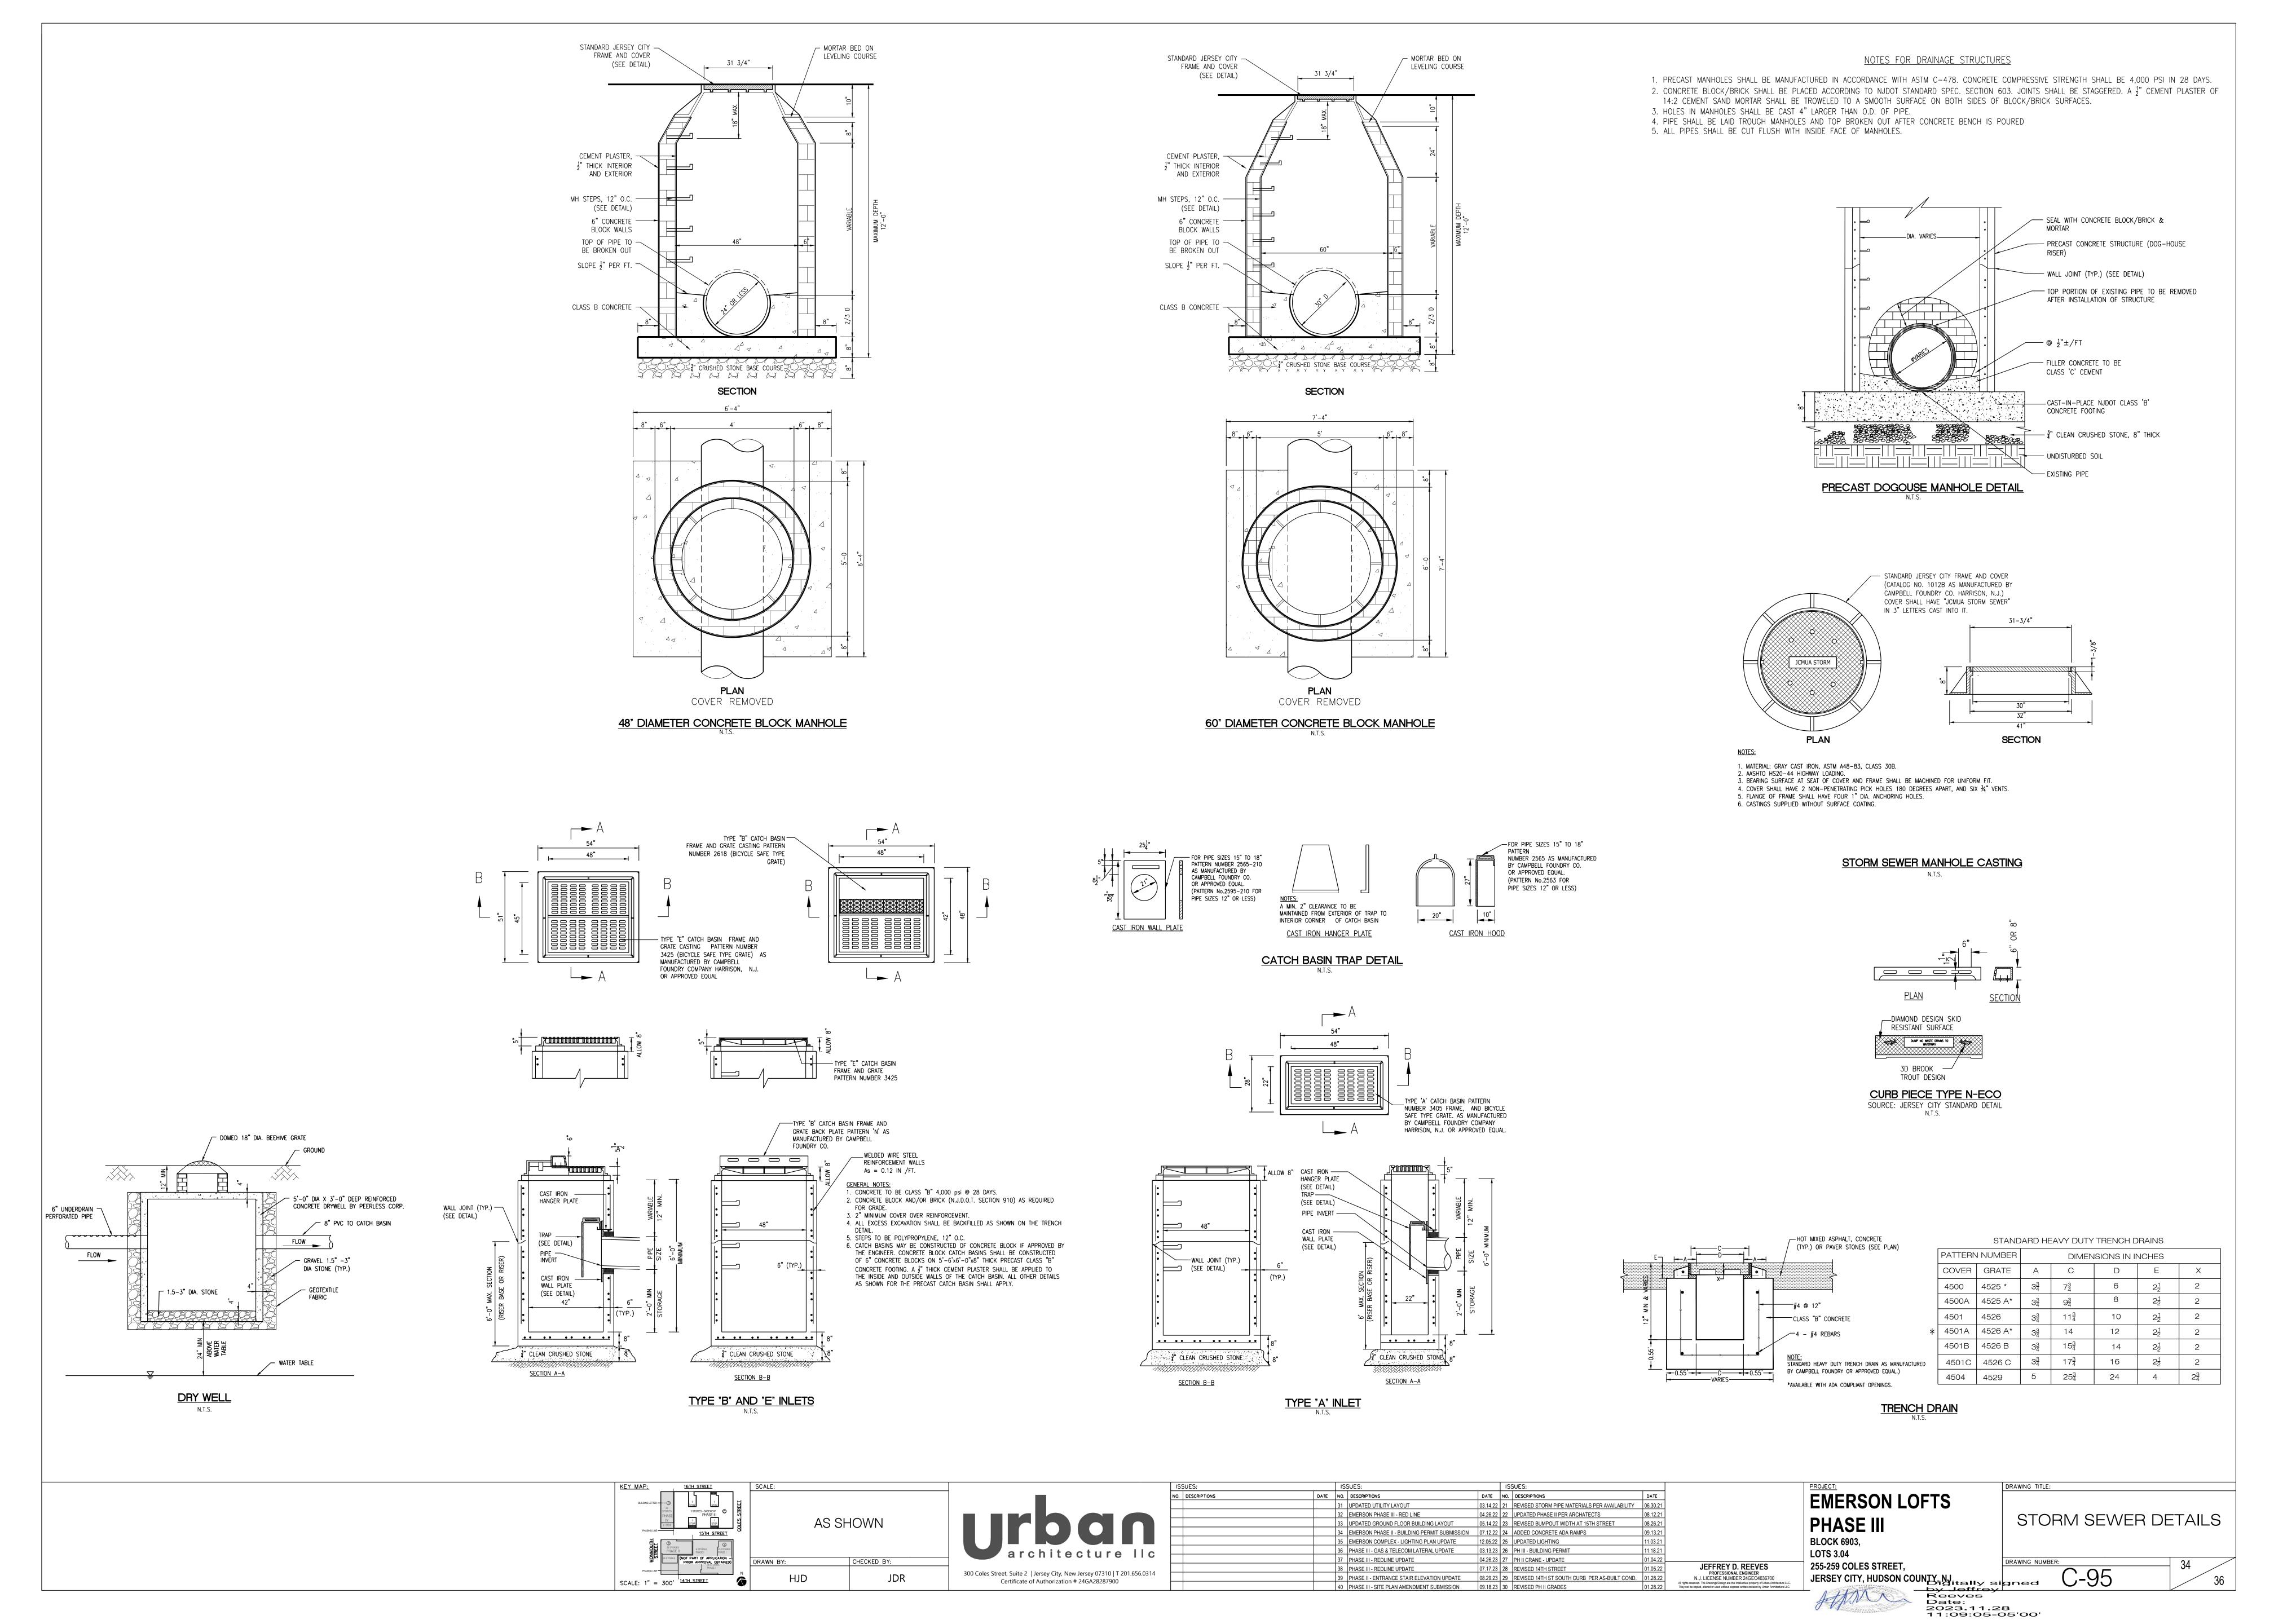
JERSEY CITY, HUDSON COUNTY, NJ by Jeffrey


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DRAWING TITLE WATER SYSTEM DETAILS C-94





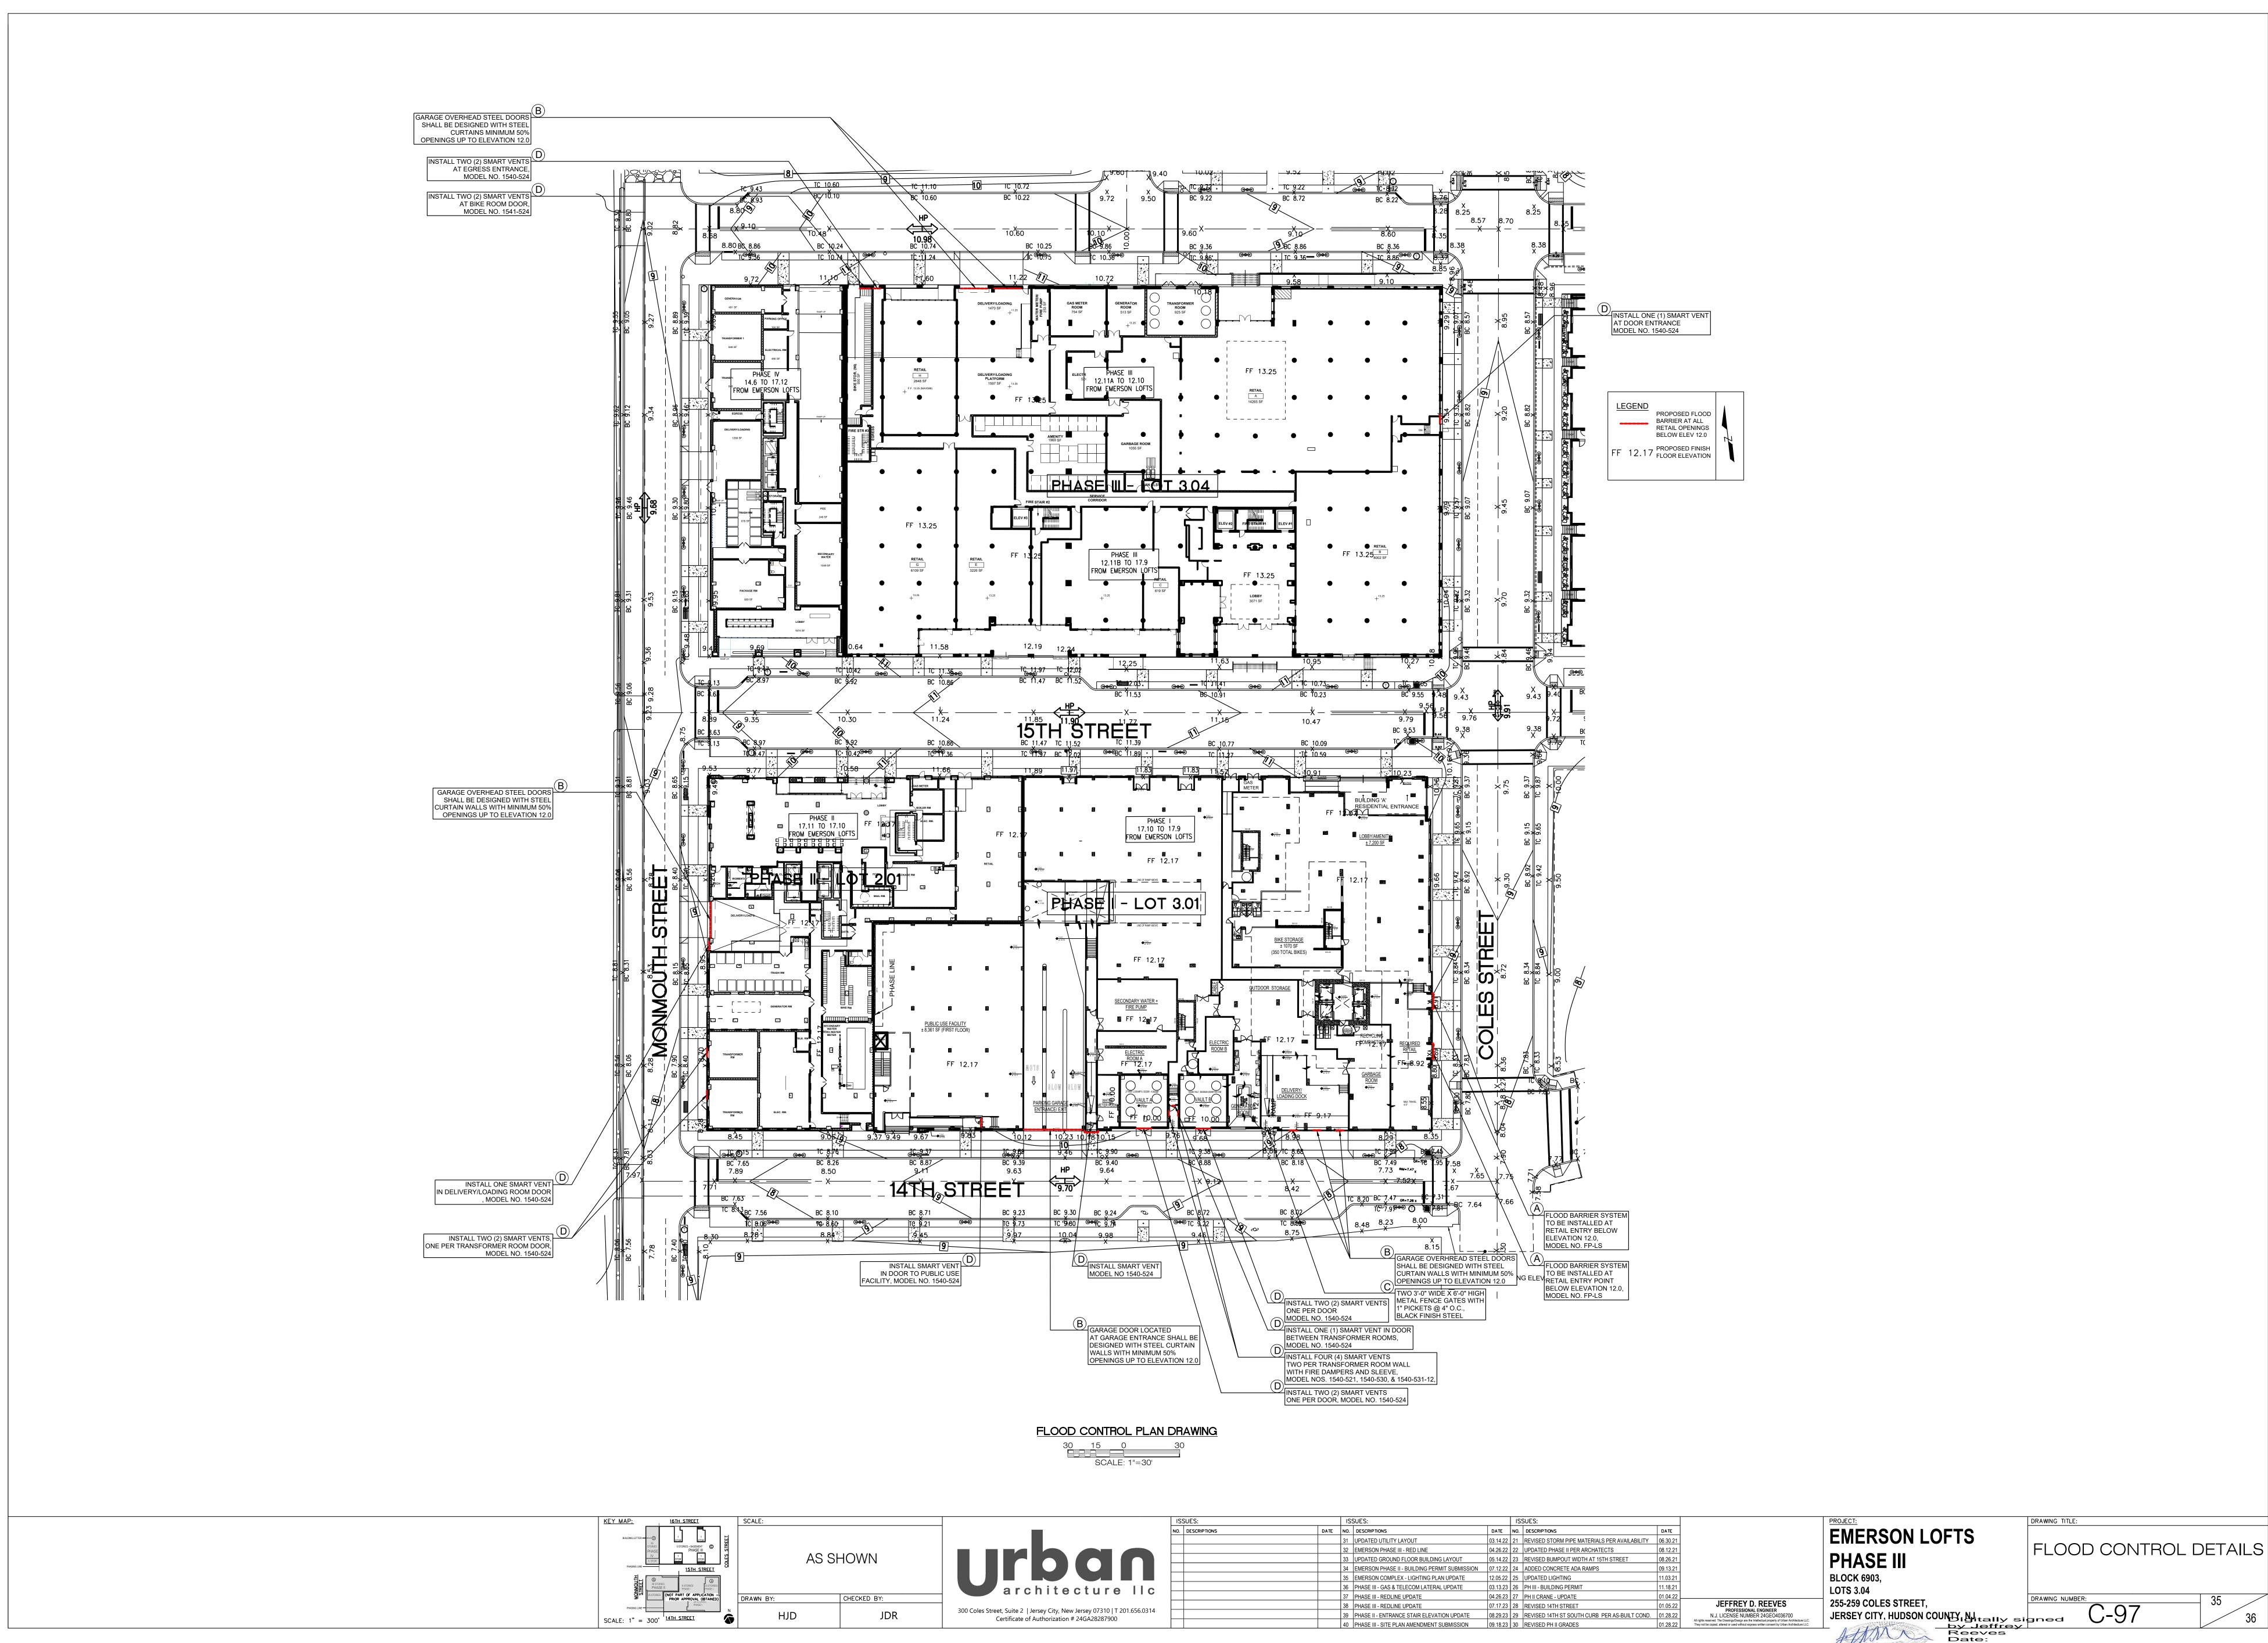Date: 2023.11.28 11:10:29-05'00'

