
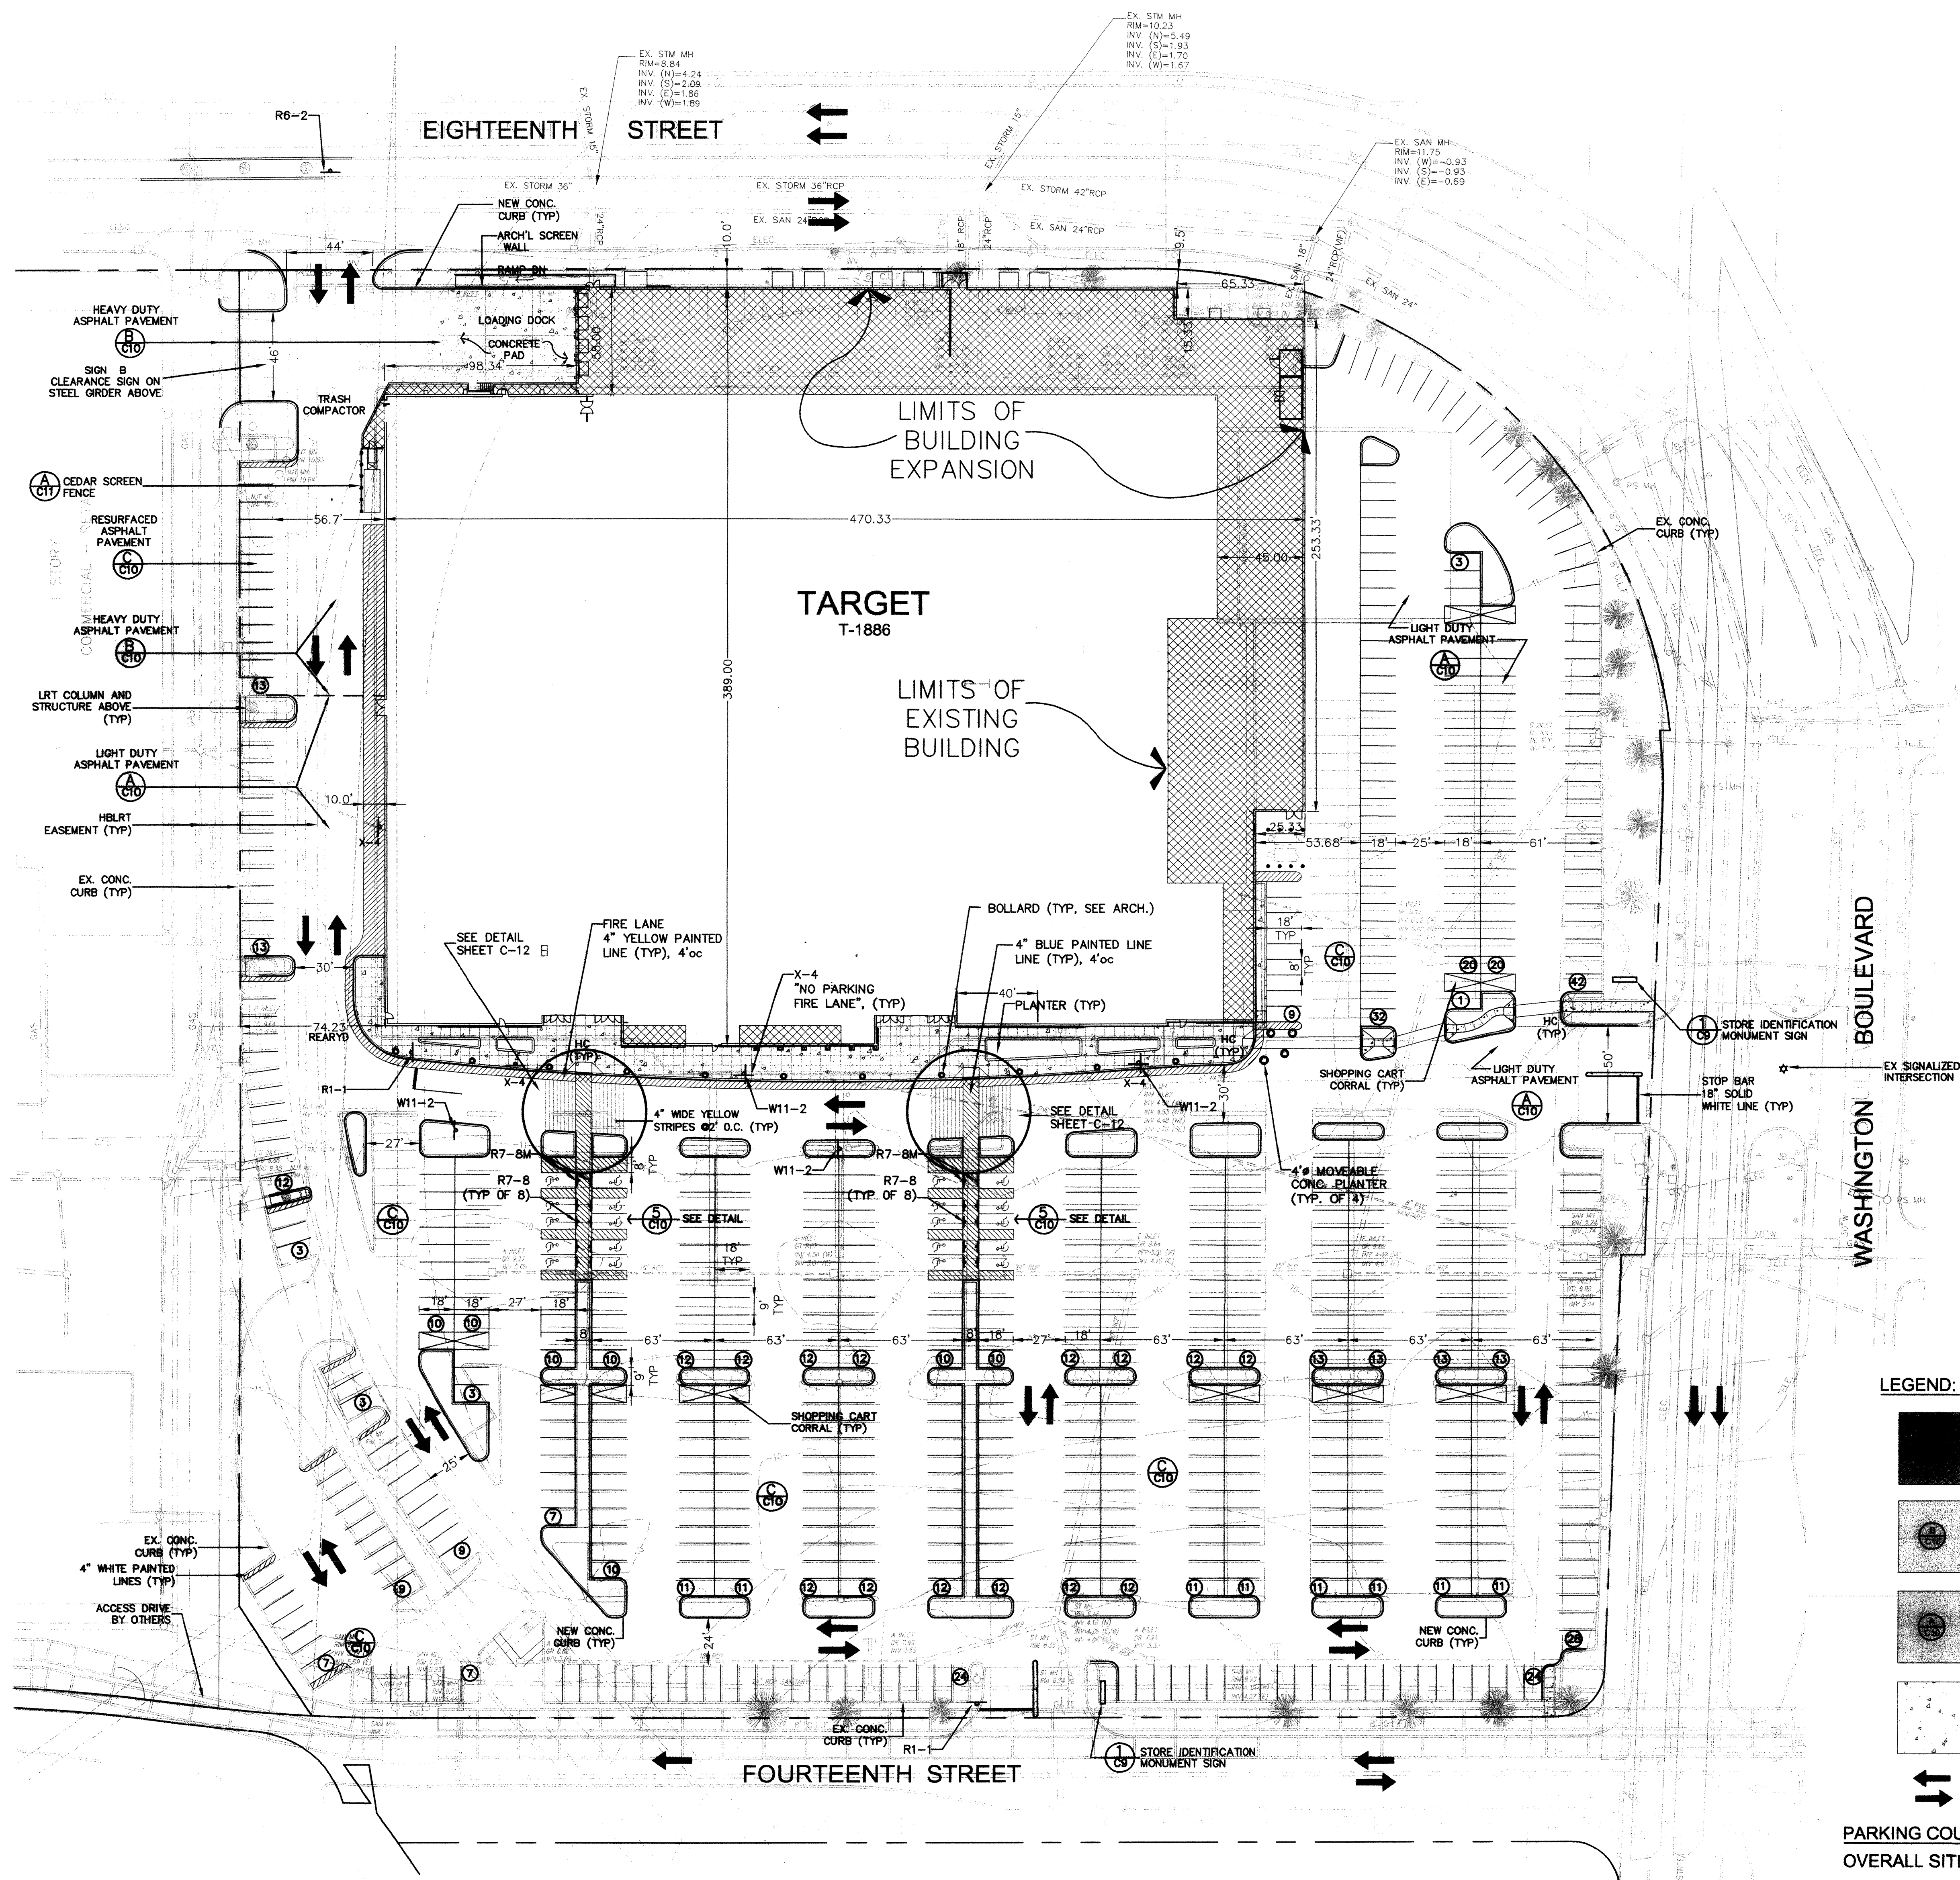


C0.0

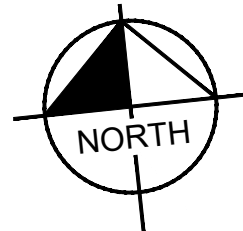

Site Development Manager
____ Revise and Resubmit ____ Not Review

Project Architect
____ Revise and Resubmit ____ Not Review

Project Engineer (M)
____ Revise and Resubmit ____ Not Review

Project Engineer (E)
____ Revise and Resubmit ____ Not Review

Project Engineer (S)
____ Revise and Resubmit ____ Not Review

Approved only for conformance of the site construction of
Guide, Edition 2.3 and the Target building documents. C
for completeness, accuracy, and dimensions on the site c

LEGEND:



- = PROPOSED BUILDING
- = HEAVY DUTY ASPHALT

LEGEND:

- = PROPOSED BUILDING EXPANSION
- = HEAVY DUTY ASPHALT
- = LIGHT DUTY ASPHALT
- = CONCRETE PAVEMENT & SIDEWALK
- = DIRECTION OF TRAFFIC FLOW

PARKING COUNT

OVERALL SITE PARKING TOTAL: 668 SPACES INCLUDING
20 HC SPACES
*NOT INCLUDING CART CORRALS

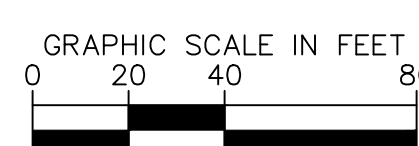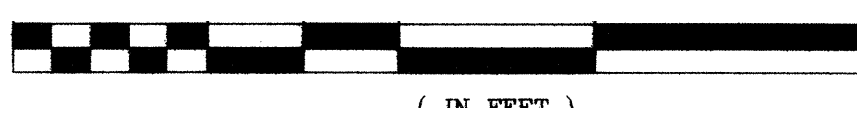

NOTE
1. THIS PLAN IS PROVIDED FOR INFORMATIONAL
PURPOSES ONLY, AND IS BASED UPON THE PLAN
ENTITLED "DIMENSIONAL PLAN" PREPARED BY PAULUS
SOKOLOWSKI AND SARTOR, LLC., LAST REVISED 6/7/2004.



Kimley»Horn

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902 CARNEGIE CENTER BLVD, SUITE 140
PRINCETON, NJ 08540
PHONE: 609-681-2428
WWW.KIMLEY-HORN.COM
CERTIFICATE OF AUTHORIZATION No.
24GA28039300

Date No Description

RICHARD PROCANIK



DATE: 01/20/2022

TARGET
T-1886 JERSEY CITY
100 14TH STREET
JERSEY CITY, NJ 07310
BLOCK: 7301, LOT: 1

Project Number T-1886

Config:
Drawn By JCS
Checked By RP

EXISTING
CONDITIONS
SITE PLAN


C0.1

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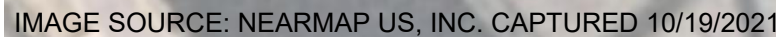
PROFESSIONAL ENGINEER
NEW JERSEY LICENSE No. 5407700
01/20/2022

TARGET
T-1886 JERSEY CITY
100 14TH STREET
JERSEY CITY, NJ 07310
BLOCK: 7301, LOT: 1

C0.2

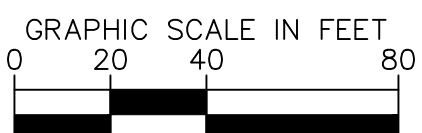

OVERALL SITE PLAN
1" = 40'



1" = 10'

 $1'' = 150'$

- ① SANDBLAST AND REMOVE EXISTING STRIPING AND DRIVE UP SIGNAGE.
- ③ REMOVE AND SALVAGE EXISTING DRIVE UP BEACON.
- ④ INSTALL CROSSWALK PER DETAILS SHEET.
- ⑤ INSTALL STOP BAR AND MARKING PER DETAILS SHEET.
- ⑥ INSTALL STOP SIGN PER DETAILS SHEET.
- ⑦ INSTALL CURB RAMP PER DETAILS SHEET.
- ⑧ INSTALL DRIVE UP STRIPING AND SIGNAGE PER DETAILS SHEET.
- ⑨ INSTALL DRIVE UP BEACON PER DETAILS SHEET.
- ⑩ INSTALL STANCHION SIGN AND BASE PER DETAILS SHEET.
- ⑫ REMOVE TARGET SPHERICAL BOLLARD.
- ⑬ RETROFIT EXISTING LIGHT POLE.

CONTRACTOR TO FIELD VERIFY SITE CONDITIONS AND HORIZONTAL DIMENSIONS. CONTRACTOR TO NOTIFY ENGINEER IF ANY DISCREPANCIES ARE DISCOVERED.

[illegible]

RICHARD PROCANIK



PROFESSIONAL ENGINEER
NEW JERSEY LICENSE No. 5407700
01/20/2022

DATE: 01/20/2022





Project Number T-1886



Drawn By	JCS
Checked By	RP

STRIPING AND
SIGNAGE PLAN

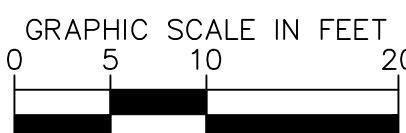C1.0

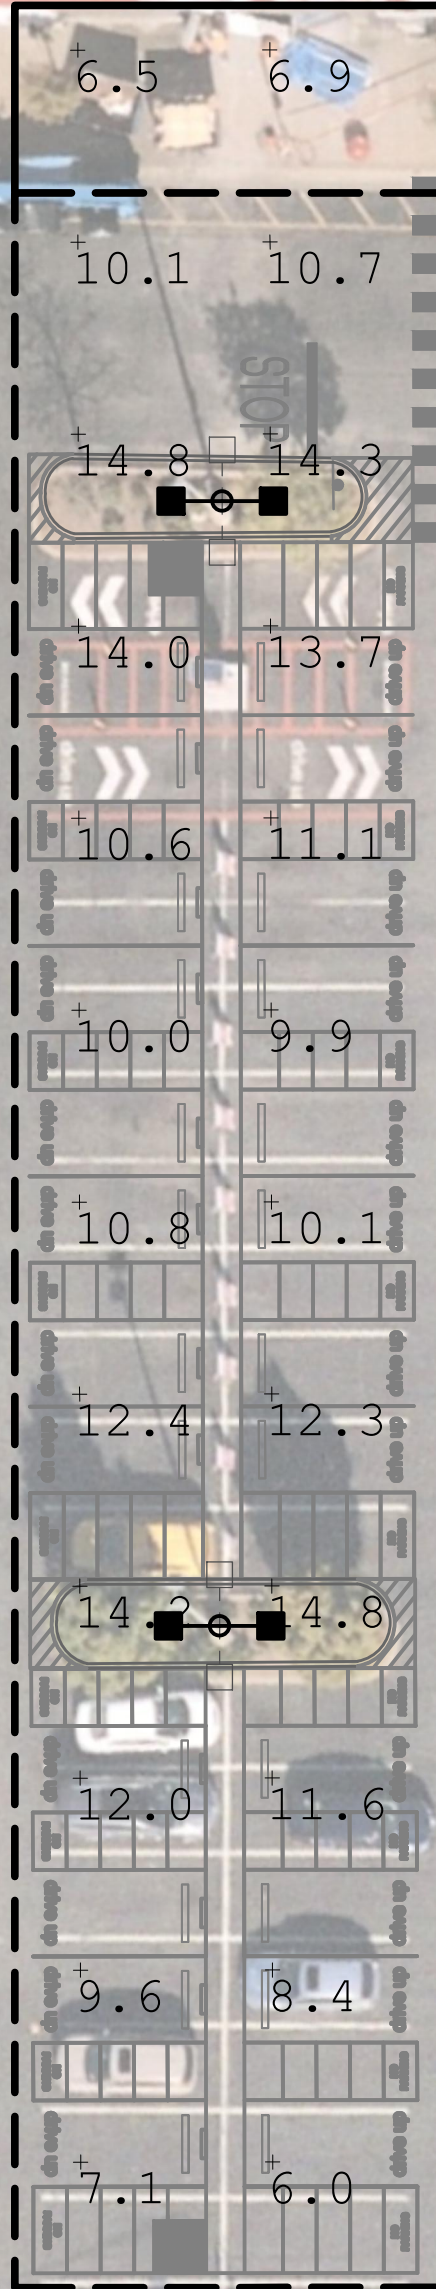



SYMBOL	QTY	LIGHT FIXTURE TYPE	MANUFACTURER/MODEL NAME	CATALOG/MODEL NUMBER	IES FILE NUMBER	DISTRIBUTION TYPE	FIXTURE TYPE	WATTAGE	INITIAL LUMENS/FIXTURE	LAMP QTY	COLOR TEMP.	LLF	MOUNTING HEIGHT	B.U.G. RATING	DESCRIPTION
	2	LED	MCGRAW-EDISON	GLEON-AF-06-LED-480-5MQ-DP-800-DIM10 -PER7N-MS/DC-L40W	GLEON-AF-06-LED-E1-5MQ-800.IES	VS	POLE MOUNTED	249W	30911	2	4,000 K	0.9	29'-0"	B5-U0-G3	EXISTING-5MQ-06(2)(S)
	2	LED	MCGRAW-EDISON	GLEON-AF-07-LED-480-T2R-EA-DP-800-DIM10 -PER7N-MS/DC-L40W-EA	GLEON-AF-07-LED-E1-T2R-800.IES	II	POLE MOUNTED	295W	36252	2	4,000 K	0.9	29'-0"	B3-U0-G4	NEW-T2R-07(2)(S)

SIDEWALKS
ILLUMINANCE (Fc)
MINIMUM = 1.0

PARKING LOT**
ILLUMINANCE (Fc)
AVG. MIN = 1.0 AVG MAX = 2.0

MAX POLE MOUNTING HEIGHT = 25 FT
**PER JERSEY CITY, NJ CODE OF ORDINANCES
SECTION 345.10.10.10.10
**THE AREA OF ANALYSIS IS LIMITED TO THE AREA
ADJACENT OUTSIDE OF THE EXISTING LIGHT POLES
AND DOES NOT CONSIDER THE FULL DISSIPATION
OF LIGHT GENERATED FROM THESE FIXTURES.

SIDEWALKS


ILLUMINANCE (Fc)


MINIMUM = 6.5

LIMITS OF LIGHTING ANALYSIS

ILLUMINANCE (Fc)


AVERAGE = 10.9	
MINIMUM = 6.0	MAXIMUM = 14.8
AVG/MIN = 1.8	MAX/MIN = 2.5

 = LIMITS OF LIGHTING ANALYSIS

 = SIDEWALKS

T1886- DESIGN LEVEL 1
JERSEY CITY, NJ
POLE COLOR & SHAPE PER SURVEY - ROUND/GRAY
FIXTURE VOLTAGE PER SURVEY - 480V

****EXISTING 5MQ-06 (2) (S) WILL REQUIRE AN EXTENDED
ARMS. THEY CURRENT HAVE A STANDARD ARM.**

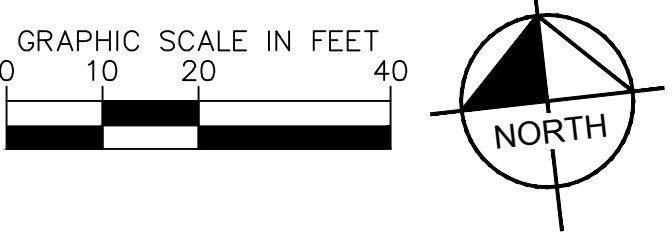


NOTES

1. EXISTING PARKING LOT LIGHTING, OUTSIDE OF THE LIMITS OF LIGHTING ANALYSIS, WAS NOT CALCULATED FOR THIS PROJECT.
2. THE LIGHTING VALUES AND CALCULATION POINTS DEPICTED ARE ALL ANALYZED ON A HORIZONTAL GEOMETRIC PLANE AT ELEVATION ZERO (GROUND LEVEL) UNLESS OTHERWISE NOTED. THE VALUES DERIVED ON THIS PLAN ARE IN FOOT-CANDELS.
3. THIS PLAN IS INTENDED TO SHOW THE LOCATIONS AND TYPE OF LUMINAIRES. ONLY. CONTRACTOR MUST BRING TO THE DESIGNER'S ATTENTION, PRIOR TO THE COMMENCEMENT OF CONSTRUCTION, ANY LIGHT LOCATIONS THAT CONFLICT WITH THE INFORMATION PROVIDED IN THIS PLAN.
4. NO BUILDING LUMINAIRES WERE INCLUDED IN THE CALCULATIONS FOR THE DRIVE UP AISLE.

[illegible]

RICHARD PROCANIK

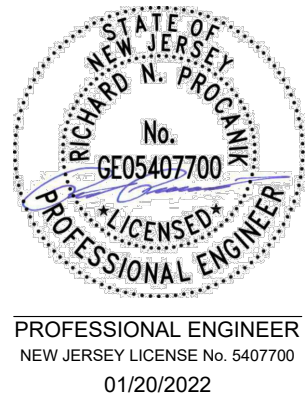

DATE: 01/20/2022

TARGET
T-1886 JERSEY CITY
100 14TH STREET
JERSEY CITY, NJ 07310
BLOCK: 7301, LOT: 1

Project Number	T-1886
Config:	
Drawn By	BDD
Checked By	RP

PHOTOMETRIC PLAN & DETAILS

C1.1



Kimley»Horn

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CERTIFICATE OF AUTHORIZATION No.
24GA28039300

[illegible]

RICHARD PROCANIK



PROFESSIONAL ENGINEER
NEW JERSEY LICENSE No. 5407700
01/20/2022

DATE: 01/20/2022




Project Number

Config:

Drawn By	JCS
Checked By	RP

DETAILS


C2.0

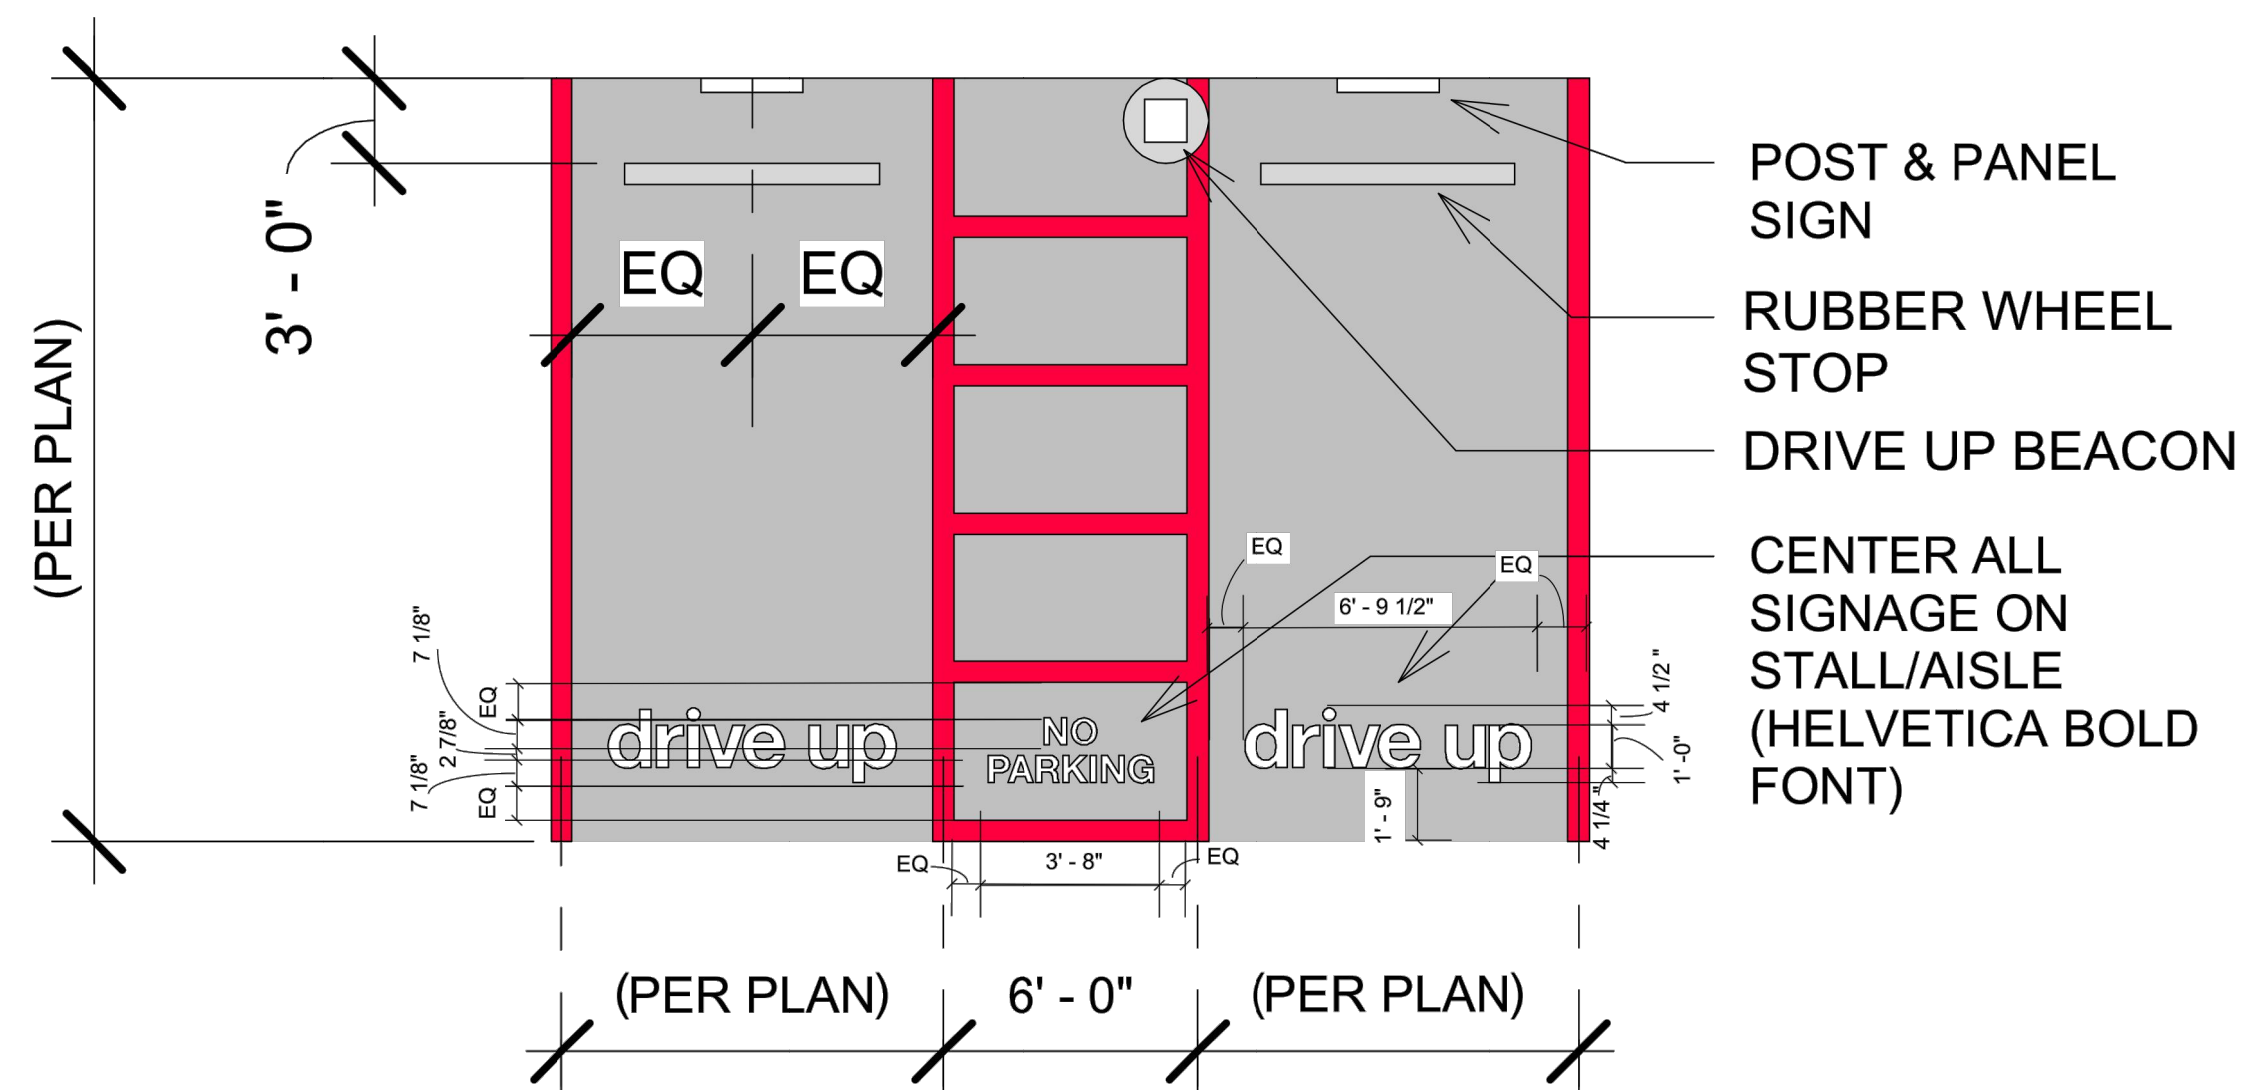


NOTES:

1. ALL RED STRIPING IS 6" WIDE
2. TARGET TO PROVIDE GC WITH "drive up" AND "NO PARKING" TEMPLATES
3. SEE PLAN VIEW DIMENSIONS FOR EXACT LAYOUT OF SITE
4. REFER TO C1.0 FOR EXACT DIMENSIONS

90° PARKING WITH LOADING AISLES
N.T.S.

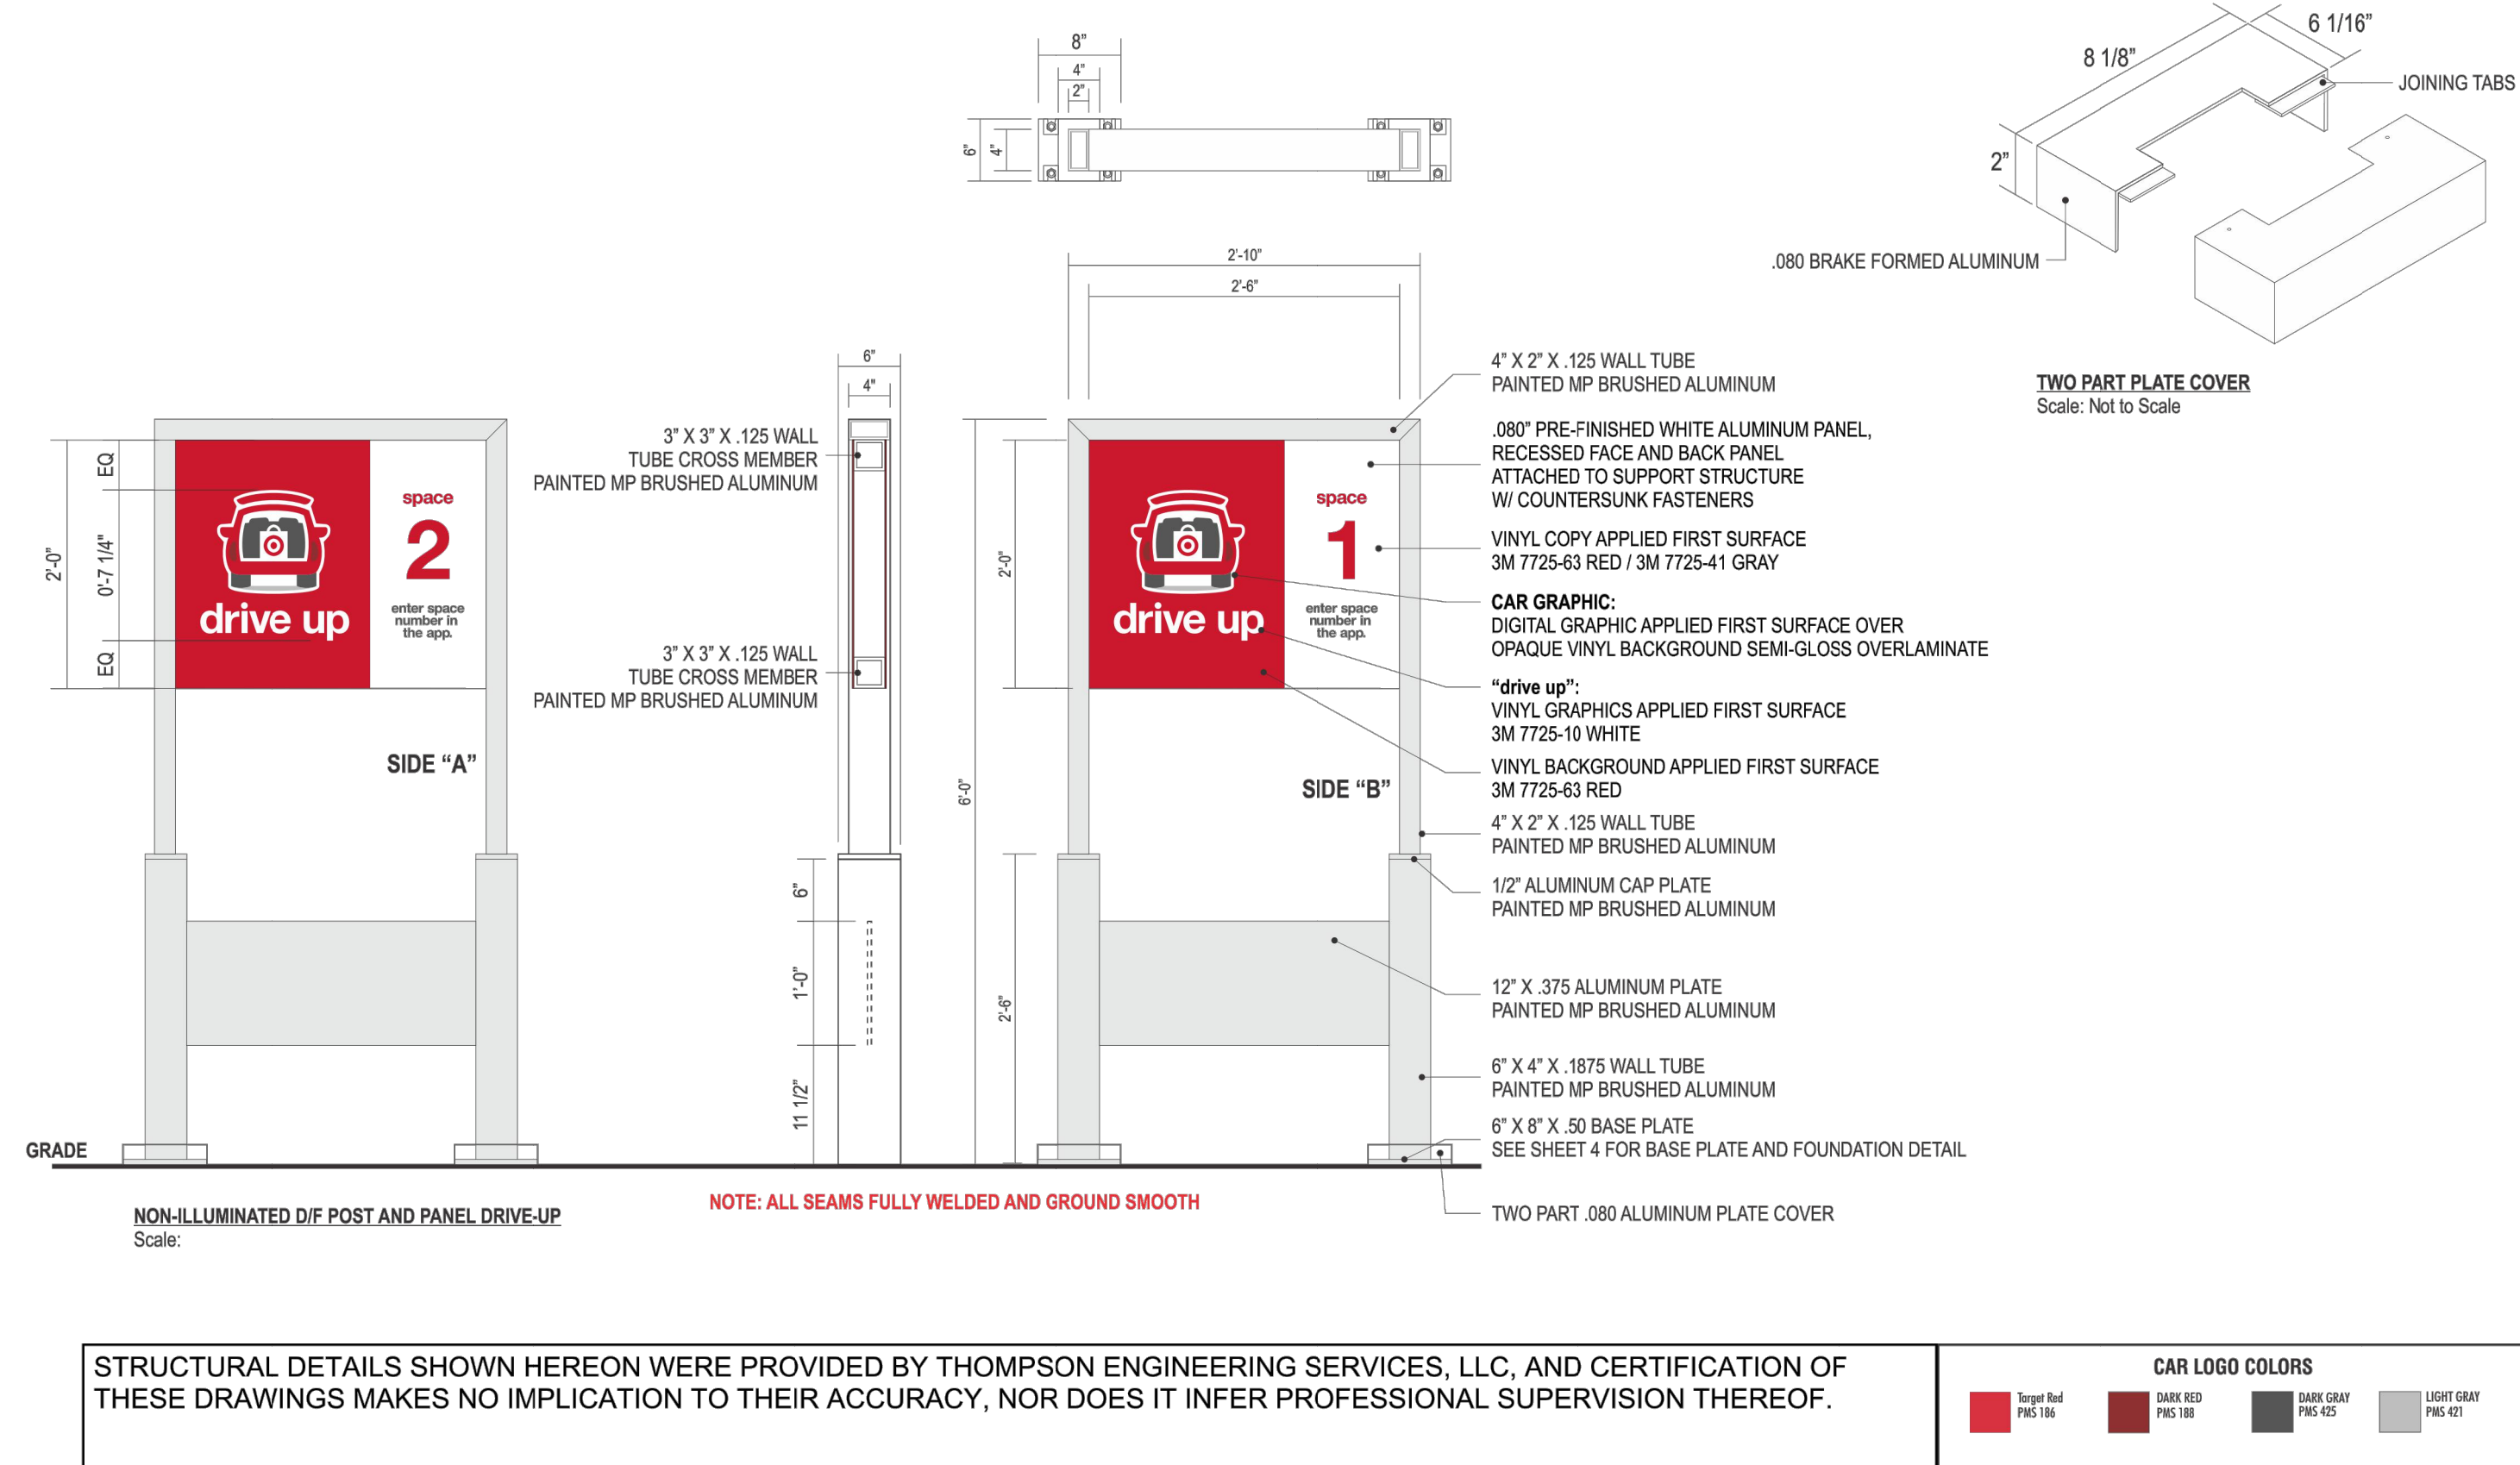


STANCHION SIGN POST AND BASE
N.T.S.

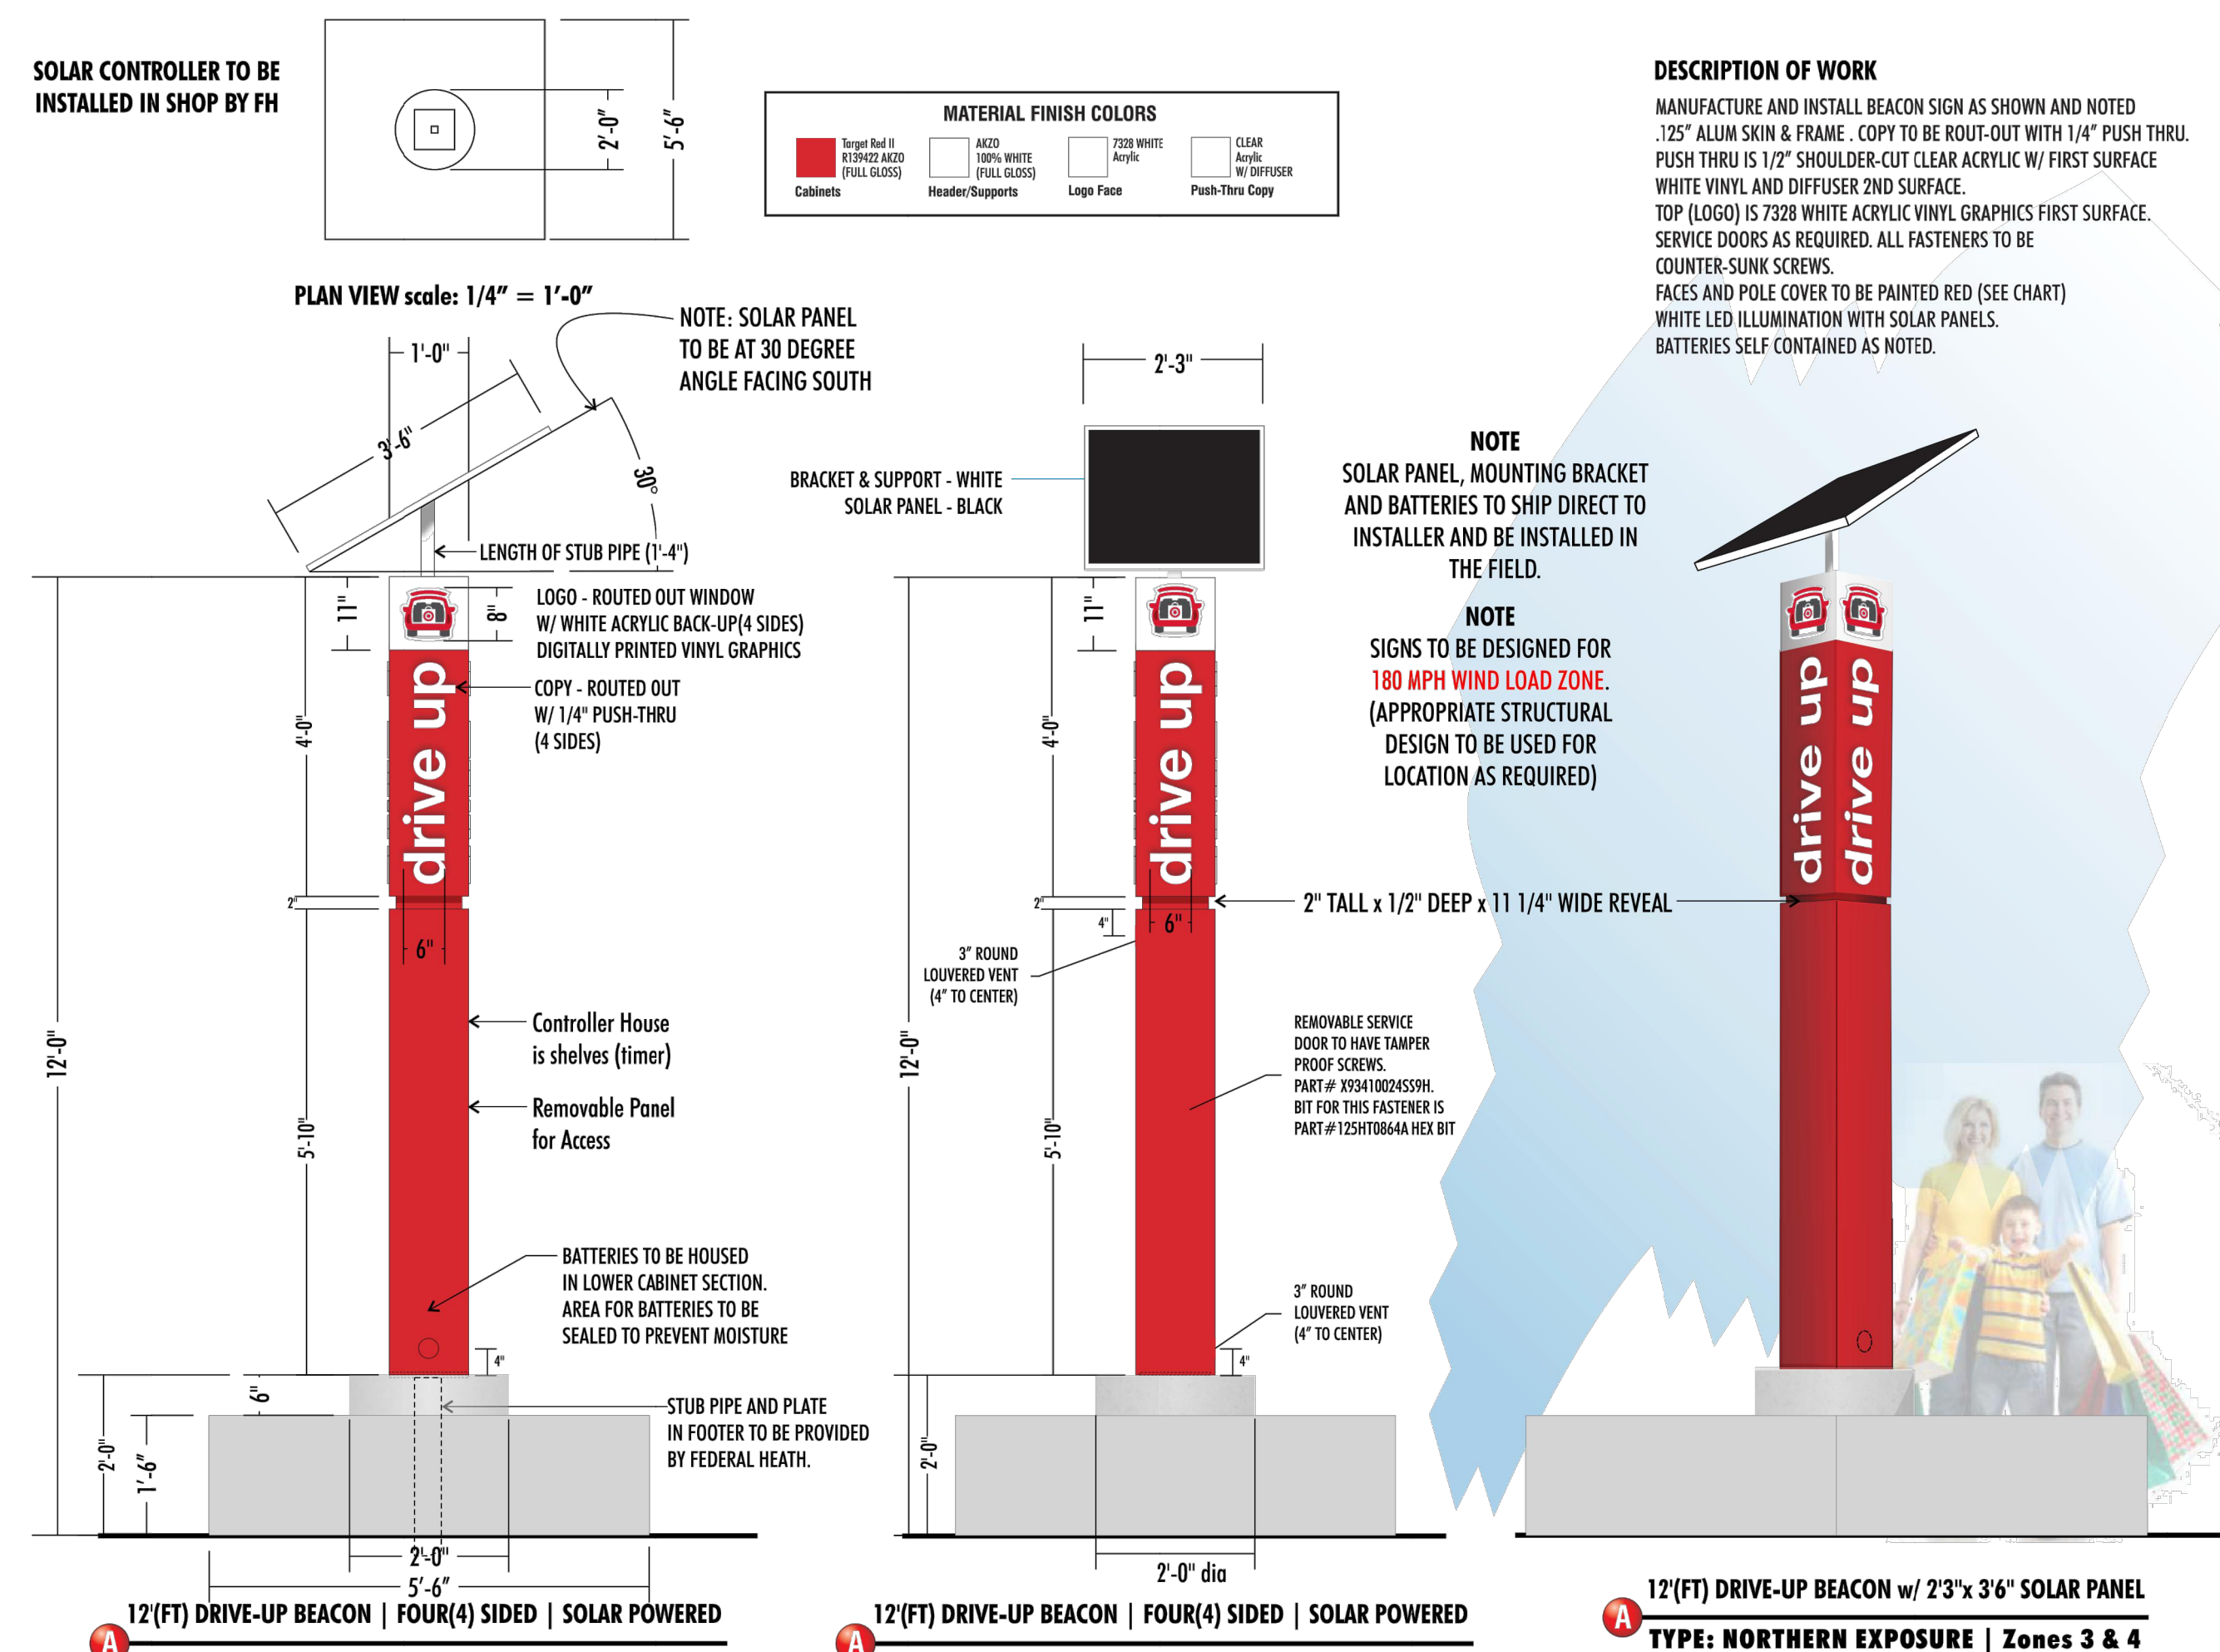


SOLAR DRIVE UP BEACON
NTS

STRUCTURAL DETAILS SHOWN HEREON WERE PROVIDED BY MBI, INC, AND CERTIFICATION OF THESE DRAWINGS MAKES NO IMPLICATION TO THEIR ACCURACY. NOR DOES IT INFER PROFESSIONAL SUPERVISION THEREOF.

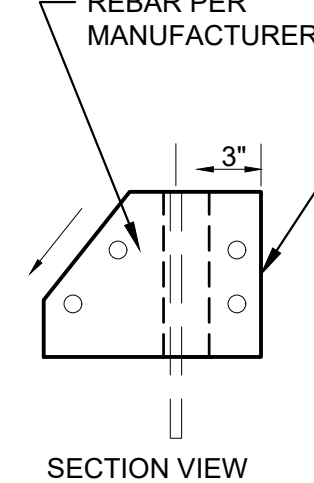

N.T.S.

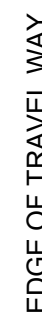

N.T.S.



1. WORDS AND ARROWS FOR DRIVEWAYS SHALL BE APPLIED ACCORDING TO REQUIREMENTS AS OUTLINED IN SECTION 3B OF THE MANUAL ON UNIFORM TRAFFIC CONTROL DEVICES FOR STREETS AND HIGHWAYS
2. THESE WORDS AND BAR ARE TO BE PAINTED WHITE.

N.T.S.



N.T.S.

13. REFER TO NJDOT CONSTRUCTION SPECIFICATIONS FOR APPROVED MATERIALS AND INSTALLATION PROCEDURES.

Date

PROFESSIONAL ENGINEER
NEW JERSEY LICENSE No. 5407700
01/20/2022

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BLOCK: 7301, LOT: 1

Config:	
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Checked By	RP

C2.1