


SCALE: |" = 500'±

AMENDED FINAL MAJOR SITE PLAN FOR

PROPOSED 29-STORY MIXED-USE DEVELOPMENT

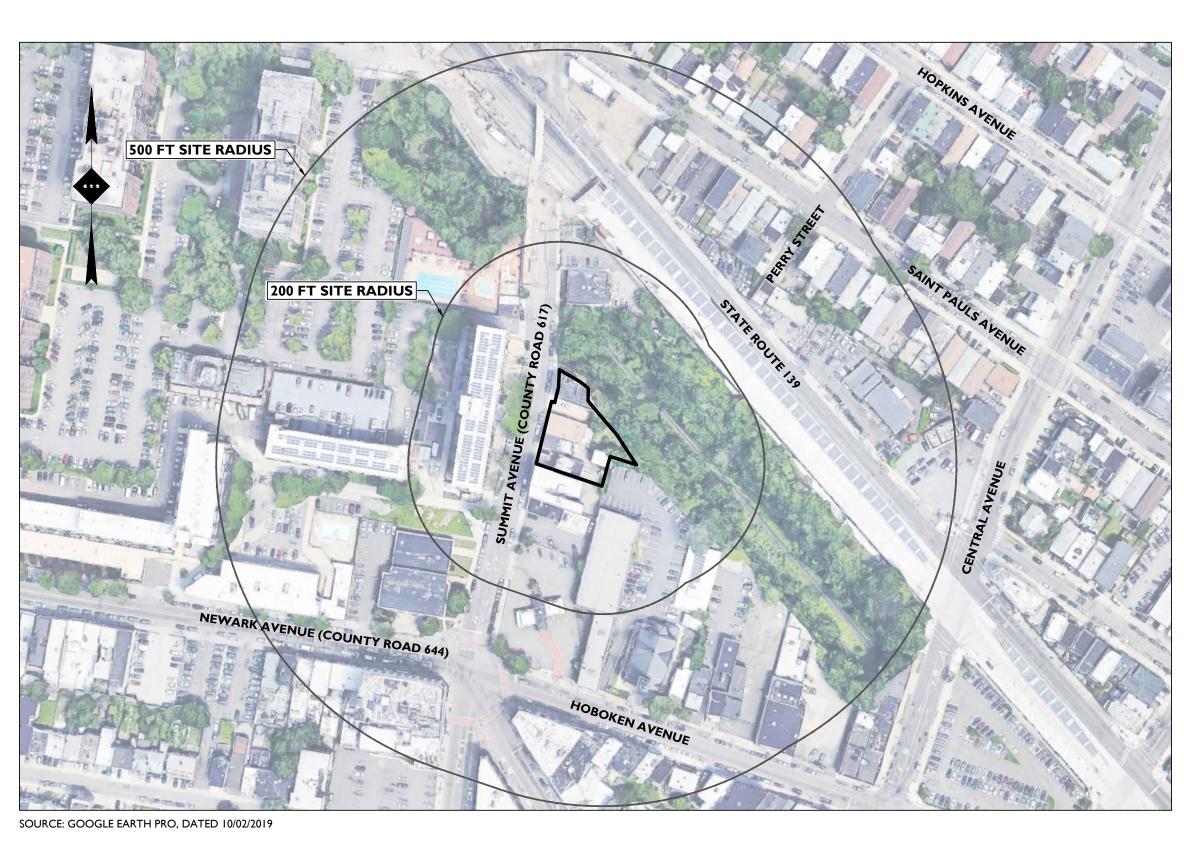


AERIAL MAP SCALE: |" = |50'±



Call before you dig.

BLOCK 6701, LOT 21.01 622 - 628 SUMMIT AVENUE CITY OF JERSEY CITY, HUDSON COUNTY, NEW JERSEY

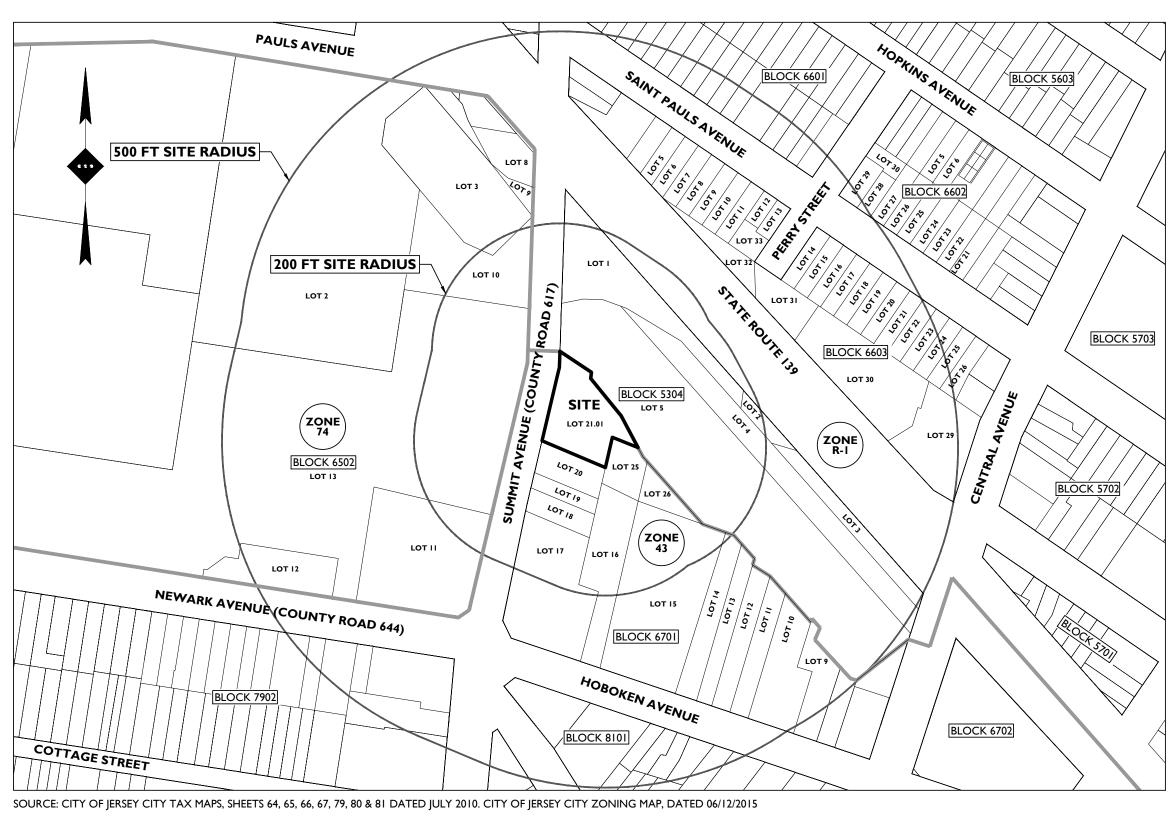

PLANS PREPARED BY:



Rutherford, NJ \cdot New York, NY Princeton, NJ • Tampa, FL • Detroit, MI www.stonefieldeng.com

Headquarters: 92 Park Avenue, Rutherford, NJ 07070 Phone 201.340.4468 · Fax 201.340.4472

PLAN REFERENCE MATERIALS:

SCALE: |" = 150'±

I. THIS PLAN SET REFERENCES THE FOLLOWING DOCUMENTS **INCLUDING, BUT NOT LIMITED TO: ING, BUT NOT LIMITED TO:**

- **BOUNDARY & TOPOGRAPHIC SURVEY PREPARED BY** STONEFIELD ENGINEERING & DESIGN, DATED 03/29/2021.
- ARCHITECTURAL PLANS PREPARED BY MVMK ARCHITECTURE + DESIGN, DATED 01/03/2023.
- **IMAGERY DATED 03/12/2019.**
- LOCATION MAP OBTAINED FROM UNITED STATES GEOLOGICAL SURVEY QUADRANGLE MAP, JERSEY CITY, NEW JERSEY-NEW YORK, 7.5 MINUTE SERIES, **DATED 2016**
- TAX MAP OBTAINED FROM THE CITY OF JERSEY CITY, HUDSON COUNTY, NEW JERSEY, DATED JULY 2010. ZONING MAP OBTAINED FROM THE CITY OF JERSEY CITY, HUDSON COUNTY, NEW JERSEY, DATED JUNE 12, 2015.
- 2. ALL REFERENCE MATERIAL LISTED ABOVE SHALL BE CONSIDERED A PART OF THIS PLAN SET AND ALL INFORMATION CONTAINED WITHIN THESE MATERIALS SHALL BE UTILIZED IN CONJUNCTION WITH THIS PLAN SET. THE CONTRACTOR IS RESPONSIBLE TO OBTAIN A COPY OF EACH REFERENCE AND REVIEW IT THOROUGHLY PRIOR TO THE START OF CONSTRUCTION

MVMK

Architecture + Design 360 14th St. , Hoboken, NJ, 07030 T. 201-386-0637 E. info@mvmkarchitecture.com www.mvmkarchitecture.com

SEAL

Frank J. Minervini, AIA NJ License # 12576 NY License # 03 0297 63 Anthony C. Vandermark, Jr. AIA NJ License # 17698 NY License # 32710-1 Adrian Melia, AlA NJ License # 18738 Ciaran Kelly, AIA NJ License # 18866

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ARTHUR KUYAN, P.E NEW JERSEY LICENSE No. 55741 LICENSED PROFESSIONAL ENGINEE

TAX & ZONING MAP

AERIAL MAP OBTAINED FROM GOOGLE EARTH PRO,

SHEET INDEX		
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15	01/06/2023	PB RESUBMISSION
14	12/16/2022	JCMUA REVISIONS
13	11/28/2022	FOR BUILDING
15	11/20/2022	PERMIT
12	10/31/2022	PSEG REVISION
11	10/05/2022	PER JCMUA
	10/03/2022	COMMENTS
10	08/08/2022	PB RESUBMISSION
9	07/20/2022	REVISED DRAINAG
8	06/20/2022	AMENDED FINAL
0	00/20/2022	SITE PLAN
7	05/12/2022	REVISED GRADING
6	04/22/2022	JCMUA REVISIONS
5	03/25/2022	JCMUA REVISIONS
4	09/03/2021	ISSUED FOR BID
3	07/02/2021	CD 90%
2	06/07/2021	CD 75%
1	04/09/2021	CD 50%
#	Date	Issue

SUMMIT TOWER

622-628 SUMMIT AVE JERSEY CITY, NEW JERSEY 07306 BLOCK 6701, LOT 21.01

Project Title


Project Description

PROPOSED NEW MIXED USE BUILDING WITH 209 RESIDENTIAL UNITS

Applicant	
628 SUMMIT AVE, LLC	

Project Number: Drawn by Checked by KB Scale As Noted

Sheet Title COVER SHEET

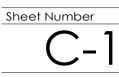

APPLICANT/OWNER

628 SUMMIT AVE LLC 222 DUNCAN AVENUE JERSEY CITY, NEW JERSEY 07306 (201) 266-0456 ARVIKIRAN7@GMAIL.COM DRAINAGE AND UTILITY NOTES

- THE CONTRACTOR TO PERFORM A TEST PIT PRIOR TO CONSTRUCTION (RECOMMEND 30 DAYS PRIOR) AT LOCATIONS OF EXISTING UTILITY CROSSINGS FOR STORMWATER IMPROVEMENTS. SHOULD A CONFLICT EXIST. THE CONTRACTOR SHALL IMMEDIATELY NOTIFY STONEFIELD ENGINEERING & DESIGN, LLC, IN WRITING. CONTRACTOR SHALL START CONSTRUCTION OF STORM LINES AT THE LOWEST INVERT AND WORK UP-GRADIENT.
- THE CONTRACTOR IS REQUIRED TO CALL THE APPROPRIATE AUTHORITY FOR NOTICE OF CONSTRUCTION/EXCAVATION AND UTILITY MARK OUT PRIOR TO THE START OF CONSTRUCTION IN ACCORDANCE WITH STATE LAW. CONTRACTOR IS REQUIRED TO CONFIRM THE HORIZONTAL AND VERTICAL LOCATION OF UTILITIES IN THE FIELD. SHOULD A DISCREPANCY EXIST BETWEEN THE FIELD LOCATION OF A UTILITY AND THE LOCATION SHOWN ON THE PLAN SET OR SURVEY, THE CONTRACTOR SHALL NOTIFY STONEFIELD ENGINEERING & DESIGN, LLC. IMMEDIATELY IN WRITING.
- 4. THE CONTRACTOR IS RESPONSIBLE TO MAINTAIN A RECORD OF THE AS-BUILT LOCATIONS OF ALL PROPOSED UNDERGROUND INFRASTRUCTURE. THE CONTRACTOR SHALL NOTE ANY DISCREPANCIES BETWEEN THE AS-BUILT LOCATIONS AND THE LOCATIONS DEPICTED WITHIN THE PLAN SET. THIS RECORD SHALL BE PROVIDED TO THE OWNER FOLLOWING COMPLETION OF WORK. EXCAVATION, SOIL PREPARATION, AND DEWATERING NOTES
- THE CONTRACTOR IS REQUIRED TO REVIEW THE REFERENCED GEOTECHNICAL DOCUMENTS PRIOR TO CONSTRUCTION, THESE DOCUMENTS SHALL BE CONSIDERED A PART OF THE PLAN SET. THE CONTRACTOR IS REQUIRED TO PREPARE SUBGRADE SOILS BENEATH ALL PROPOSED IMPROVEMENTS AND BACKFILL ALL EXCAVATIONS IN ACCORDANCE WITH RECOMMENDATIONS BY THE GEOTECHNICAL ENGINEER OF RECORD.
- THE CONTRACTOR IS RESPONSIBLE FOR PROVIDING SHORING FOR ALL EXCAVATIONS AS REQUIRED. CONTRACTOR SHALL HAVE THE SHORING DESIGN PREPARED BY A QUALIFIED PROFESSIONAL. SHORING DESIGNS SHALL BE SUBMITTED TO STONFFIELD ENGINEERING & DESIGN. L.C. AND THE OWNER PRIOR TO THE START OF CONSTRUCTION THE CONTRACTOR IS RESPONSIBLE FOR ENSURING THAT ALL OPEN EXCAVATIONS ARE PERFORMED AND PROTECTED IN ACCORDANCE WITH THE LATEST OSHA REGULATIONS.
- THE CONTRACTOR IS RESPONSIBLE FOR ANY DEWATERING DESIGN AND OPERATIONS, AS REQUIRED, TO CONSTRUCT THE PROPOSED IMPROVEMENTS. THE CONTRACTOR SHALL OBTAIN ANY REQUIRED PERMITS FOR DEWATERING OPERATIONS AND GROUNDWATER DISPOSAL.
- STORMWATER UNDERGROUND BMP CONSTRUCTION NOTES
- I. THE CONTRACTOR SHALL INSTALL AND BACKFILL THE UNDERGROUND BMP IN ACCORDANCE WITH THE I. THE CONTRACTOR IS REQUIRED TO CALL THE APPROPRIATE AUTHORITY FOR NOTICE OF MANUFACTURER'S SPECIFICATIONS.
- UNDERGROUND BASINS SHALL UTILIZE A STONE BACKFILL WITH A MINIMUM VOID RATIO OF 40%. NO CONSTRUCTION LOADING OVER UNDERGROUND BASINS IS PERMITTED UNTIL BACKFILL IS COMPLETE PER THE MANUFACTURER'S SPECIFICATIONS. NO VEHICLES SHALL BE STAGED OR OPERATE FROM A FIXED POSITION OVER THE BASIN.

DEMOLITION NOTES

PRACTICES

- 1. THE WORK REFLECTED ON THE DEMOLITION PLAN IS TO PROVIDE GENERAL INFORMATION TOWARDS THE EXISTING ITEMS TO BE DEMOLISHED AND/OR REMOVED. THE CONTRACTOR IS RESPONSIBLE TO REVIEW THE ENTIRE PLAN SET AND ASSOCIATED REPORTS/REFERENCE DOCUMENTS INCLUDING ALL DEMOLITION ACTIVITIES AND INCIDENTAL TASKS NECESSARY TO COMPLETE THE SITE IMPROVEMENTS.
- THE CONTRACTOR IS RESPONSIBLE TO DETERMINE THE MEANS AND METHODS OF DEMOLITION ACTIVITIES. EXPLOSIVES SHALL NOT BE USED UNLESS WRITTEN CONSENT FROM BOTH THE OWNER AND ANY APPLICABLE GOVERNING AGENCY IS OBTAINED. BEFORE THE START OF ANY EXPLOSIVE PROGRAM, THE CONTRACTOR IS RESPONSIBLE TO OBTAIN ALL LOCAL, STATE, AND FEDERAL PERMITS. ADDITIONALLY, THE CONTRACTOR WILL BE RESPONSIBLE FOR ALL SEISMIC TESTING AS REQUIRED AND ANY DAMAGES AS THE RESULT OF SAID DEMOLITION
- 4. ALL DEMOLITION ACTIVITIES SHALL BE PERFORMED IN ACCORDANCE WITH LOCAL, STATE, AND FEDERAL CODES. THE CONTRACTOR IS RESPONSIBLE FOR ENSURING ALL UTILITIES ARE DISCONNECTED IN ACCORDANCE WITH THE UTILITY AUTHORITY'S REQUIREMENTS PRIOR TO STARTING THE DEMOLITION OF ANY STRUCTURE. ALL EXCAVATIONS ASSOCIATED WITH DEMOLISHED STRUCTURES OR REMOVED TANKS SHALL BE BACKFILLED WITH SUITABLE MATERIAL AND COMPACTED TO SUPPORT SITE AND BUILDING IMPROVEMENTS. A GEOTECHNICAL ENGINEER SHOULD BE PRESENT DURING BACKFILLING ACTIVITIES TO OBSERVE AND CERTIFY THAT BACKFILL MATERIAL WAS COMPACTED TO A SUITABLE CONDITION.
- DEMOLISHED DEBRIS SHALL NOT BE BURIED ON SITE. ALL WASTE/DEBRIS GENERATED FROM DEMOLITION ACTIVITIES SHALL BE DISPOSED OF IN ACCORDANCE WITH ALL LOCAL, STATE AND FEDERAL REQUIREMENTS. THE CONTRACTOR IS RESPONSIBLE TO MAINTAIN ALL RECORDS OF THE DISPOSAL TO DEMONSTRATE COMPLIANCE WITH THE ABOVE **REGULATIONS.**

HUDSON-ESSEX-PASSAIC SOIL CONSERVATION DISTRICT SOIL EROSION AND SEDIMENT CONTROL NOTES

- I. ALL SOIL EROSION AND SEDIMENT CONTROL PRACTICES ON THIS PLAN WILL BE CONSTRUCTED IN ACCORDANCE WITH THE "NEW JERSEY STANDARDS FOR SOIL EROSION AND SEDIMENT CONTROL" 7TH EDITION LAST REVISED DECEMBER 2017. THESE MEASURES WILL BE INSTALLED PRIOR TO ANY MAJOR SOIL DISTURBANCE OR IN
- THEIR PROPER SEQUENCE AND MAINTAINED UNTIL PERMANENT PROTECTION IS ESTABLISHED. 2. ALL SOIL TO BE EXPOSED OR STOCKPILED FOR A PERIOD OF GREATER THAN 14 DAYS, AND NOT UNDER ACTIVE CONSTRUCTION, WILL BE TEMPORARILY SEEDED AND HAY MULCHED OR OTHERWISE PROVIDED WITH VEGETATIVE COVER. THIS TEMPORARY COVER SHALL BE MAINTAINED UNTIL SUCH TIME WHEREBY PERMANENT RESTABILIZATION IS
- ESTABLISHED. 3. SEEDING DATES: THE FOLLOWING SEEDING DATES ARE RECOMMENDED TO BEST ESTABLISH PERMANENT VEGETATIVE COVER WITHIN MOST LOCATIONS IN THE HEPSCD: SPRING - 3/1-5/15 AND FALL - 8/15 - 10/1
- 4. SEDIMENT FENCES ARE TO BE PROPERLY TRENCHED AND MAINTAINED UNTIL PERMANENT VEGETATIVE COVER IS ESTABLISHED 5. ALL STORM DRAINAGE INLETS SHALL BE PROTECTED BY ONE OF THE PRACTICES ACCEPTED IN THE STANDARDS, AND
- PROTECTION SHALL REMAIN UNTIL PERMANENT STABILIZATION HAS BEEN ESTABLISHED. STORM DRAINAGE OUTLET POINTS SHALL BE PROTECTED AS REQUIRED BEFORE THEY BECOME FUNCTIONAL 6. MULCH MATERIALS SHALL BE UN-ROTTED SMALL GRAIN STRAW APPLIED AT THE RATE OF 70 TO 90 POUNDS PER 1,000 SOUARE FEET AND ANCHORED WITH A MULCH ANCHORING TOOL. LIQUID MULCH BINDERS, OR NETTING TIE DOWN.
- OTHER SUITABLE MATERIALS MAY BE USED IF APPROVED BY THE SOIL CONSERVATION DISTRICT. 7. ALL EROSION CONTROL DEVICES SHALL BE PERIODICALLY INSPECTED, MAINTAINED AND CORRECTED BY THE CONTRACTOR. ANY DAMAGE INCURRED BY EROSION SHALL BE RECTIFIED IMMEDIATELY.
- B. THE HUDSON-ESSEX-PASSAIC SOIL CONSERVATION DISTRICT WILL BE NOTIFIED IN WRITING AT LEAST 48 HOURS PRIOR TO ANY SOIL DISTURBING ACTIVITIES. FAX-(862)333-4507 OR EMAIL - INFORMATION@HEPSCD.OF 9. THE APPLICANT MUST OBTAIN A DISTRICT ISSUED REPORT-OF-COMPLIANCE PRIOR TO APPLYING FOR THE CERTIFICATE OF OCCUPANCY OR TEMPORARY CERTIFICATE OF OCCUPANCY FROM THE **RESPECTIVE MUNICIPALITY, NJ - DCA OR ANY OTHER CONTROLLING AGENCY.** CONTACT THE DISTRICT
- RESTABILIZATION MEASURES. A PERFORMANCE DEPOSIT MAY BE POSTED WITH THE DISTRICT WHEN WINTER WEATHER OR SNOW COVER PROHIBITS THE PROPER APPLICATION OF SEED, MULCH, FERTILIZER OR HYDRO-SEED. 10. PAVED ROADWAYS MUST BE KEPT CLEAN AT ALL TIMES. DO NOT UTILIZE A FIRE OR GARDEN HOSE TO CLEAN ROADS UNLESS THE RUNOFF IS DIRECTED TO A PROPERLY DESIGNED AND FUNCTIONING SEDIMENT BASIN. WATER PUMPED OUT OF THE EXCAVATED AREAS CONTAINS SEDIMENTS THAT MUST BE REMOVED PRIOR TO DISCHARGING TO RECEIVING BODIES OF WATER USING REMOVABLE PUMPING STATIONS, SUMP PITS, PORTABLE SEDIMENTATION TANKS AND/OR SILT CONTROL BAGS.

AT 862-333-4505 TO REQUEST A FINAL INSPECTION. GIVING ADVANCED NOTICE UPON COMPLETION OF THE

- 11. ALL SURFACES HAVING LAWN OR LANDSCAPING AS FINAL COVER ARE TO BE PROVIDED TOPSOIL PRIOR TO RE-SEEDING. SODDING OR PLANTING. A DEPTH OF 5.0 INCHES, FIRMED IN PLACE, IS REQUIRED, AS PER THE STANDARDS FOR TOPSOILING AND LAND GRADING, LAST REVISED DECEMBER 2017 12. ALL PLAN REVISIONS MUST BE SUBMITTED TO THE DISTRICT FOR PROPER REVIEW AND APPROVAL
- 13. A CRUSHED STONE WHEEL CLEANING TRACKING-PAD IS TO BE INSTALLED AT ALL SITE EXITS USING 2 1/2 -1" CRUSHED ANGULAR STONE (ASTM 2 OR 3) TO A MINIMUM LENGTH OF 50 FEET AND MINIMUM DEPTH OF 6". ALL DRIVEWAYS MUST BE PROVIDED WITH CRUSHED STONE UNTIL PAVING IS COMPLETE.
- 14. STEEP SLOPES INCURRING DISTURBANCE MAY REQUIRE ADDITIONAL STABILIZATION MEASURES. THESE "SPECIAL" MEASURES SHALL BE DESIGNED BY THE APPLICANT'S ENGINEER AND BE APPROVED BY THE SOIL CONSERVATION DISTRICT 15. THE HUDSON-ESSEX-PASSAIC SOIL CONSERVATION DISTRICT SHALL BE NOTIFIED, IN WRITING, FOR
- THE SALE OF ANY PORTION OF THE PROJECT OR FOR THE SALE OF INDIVIDUAL LOTS. NEW OWNERS' INFORMATION SHALL BE PROVIDED. ADDITIONAL MEASURES DEEMED NECESSARY BY DISTRICT OFFICIALS SHALL BE IMPLEMENTED AS CONDITIONS WARRANT.

GENERAL LIGHTING NOTES

- I. THE LIGHTING LEVELS DEPICTED WITHIN THE PLAN SET ARE CALCULATED UTILIZING DATA OBTAINED FROM THE LISTED MANUFACTURER. ACTUAL ILLUMINATION LEVELS AND PERFORMANCE OF ANY PROPOSED LIGHTING FIXTURE MAY VARY DUE TO UNCONTROLLABLE VARIABLES SUCH ARE WEATHER, VOLTAGE SUPPLY, LAMP TOLERANCE, FOUIPMENT SERVICE LIFE AND OTHER VARIABLE FIELD CONDITIONS.
- 2. WHERE APPLICABLE. THE EXISTING LIGHT LEVELS DEPICTED WITHIN THE PLAN SET SHALL BE CONSIDERED APPROXIMATE. THE EXISTING LIGHT LEVELS ARE BASED ON FIELD OBSERVATIONS AND THE MANUFACTURER'S DATA OF THE ASSUMED OR MOST SIMILAR LIGHTING FIXTURE MODEL.
- UNLESS NOTED ELSEWHERE WITHIN THIS PLAN SET, THE LIGHT LOSS FACTORS USED IN THE LIGHTING ANALYSIS ARE AS FOLLOWS: LIGHT EMITTING DIODES (LED): 0.90
- 4. THE CONTRACTOR SHALL NOTIFY STONEFIELD ENGINEERING & DESIGN, LLC. IN WRITING, PRIOR TO THE START OF CONSTRUCTION, OF ANY PROPOSED LIGHTING LOCATIONS THAT CONFLICT WITH EXISTING/ PROPOSED DRAINAGE, UTILITY, OR OTHER IMPROVEMENTS.
- THE CONTRACTOR IS RESPONSIBLE TO PREPARE A WIRING PLAN AND PROVIDE ELECTRIC SERVICE TO ALL PROPOSED LIGHTING FIXTURES. THE CONTRACTOR IS REQUIRED TO PREPARE AN AS-BUILT PLAN OF WIRING AND PROVIDE COPIES TO THE OWNER AND STONEFIELD ENGINEERING & DESIGN, LLC.

CONSTRUCTION/EXCAVATION AND UTILITY MARK OUT PRIOR TO THE START OF CONSTRUCTION IN ACCORDANCE WITH STATE LAW. CONTRACTOR IS REQUIRED TO CONFIRM THE HORIZONTAL AND VERTICAL LOCATION OF UTILITIES IN THE FIELD. SHOULD A DISCREPANCY EXIST BETWEEN THE FIELD LOCATION OF A UTILITY AND THE LOCATION SHOWN ON THE PLAN SET OR SURVEY, THE CONTRACTOR SHALL NOTIFY

DRAINAGE AND UTILITY NOTES

- STONEFIELD ENGINEERING & DESIGN, LLC. IMMEDIATELY IN WRITING. THE CONTRACTOR IS RESPONSIBLE TO PROTECT AND MAINTAIN IN OPERATION ALL UTILITIES NOT DESIGNATED TO BE REMOVED.
- THE CONTRACTOR IS RESPONSIBLE FOR REPAIRING ANY DAMAGE TO ANY EXISTING UTILITY IDENTIFIED TO REMAIN WITHIN THE LIMITS OF THE PROPOSED WORK DURING CONSTRUCTION. 4. A MINIMUM HORIZONTAL SEPARATION OF 10 FEET IS REQUIRED BETWEEN ANY SANITARY
- SEWER SERVICE AND ANY WATER LINES. IF THIS SEPARATION CANNOT BE PROVIDED, A CONCRETE ENCASEMENT SHALL BE UTILIZED FOR THE SANITARY SEWER SERVICE AS APPROVED BY STONEFIELD ENGINEERING & DESIGN, LLC. ALL WATER LINES SHALL BE VERTICALLY SEPARATED ABOVE SANITARY SEWER LINES BY A
- MINIMUM DISTANCE OF 18 INCHES. IF THIS SEPARATION CANNOT BE PROVIDED, A CONCRETE ENCASEMENT SHALL BE UTILIZED FOR THE SANITARY SEWER SERVICE AS APPROVED BY STONEFIELD ENGINEERING & DESIGN, LLC.
- THE CONTRACTOR TO PERFORM A TEST PIT PRIOR TO CONSTRUCTION (RECOMMEND 30 DAYS PRIOR) AT LOCATIONS OF EXISTING UTILITY CROSSINGS FOR WATER AND SANITARY SEWER CONNECTION IMPROVEMENTS. SHOULD A CONFLICT EXIST, THE CONTRACTOR SHALL IMMEDIATELY NOTIFY STONEFIELD ENGINEERING & DESIGN, LLC. IN WRITING THE CONTRACTOR IS RESPONSIBLE FOR COORDINATING GAS, ELECTRIC AND
- TELECOMMUNICATION CONNECTIONS WITH THE APPROPRIATE GOVERNING AUTHORITY. CONTRACTOR SHALL START CONSTRUCTION OF ANY GRAVITY SEWER AT THE LOWEST
- INVERT AND WORK UP-GRADIENT. THE CONTRACTOR IS RESPONSIBLE TO MAINTAIN A RECORD SET OF PLANS REFLECTING THE LOCATION OF EXISTING UTILITIES THAT HAVE BEEN CAPPED, ABANDONED, OR RELOCATED BASED ON THE DEMOLITION/REMOVAL ACTIVITIES REQUIRED IN THIS PLAN
- SET. THIS DOCUMENT SHALL BE PROVIDED TO THE OWNER FOLLOWING COMPLETION OF WORK. 8. THE CONTRACTOR IS RESPONSIBLE TO MAINTAIN A RECORD OF THE AS-BUILT LOCATIONS OF ALL PROPOSED UNDERGROUND INFRASTRUCTURE. THE CONTRACTOR SHALL NOTE ANY DISCREPANCIES BETWEEN THE AS-BUILT LOCATIONS AND THE LOCATIONS DEPICTED WITHIN THE PLAN SET. THIS RECORD SHALL BE PROVIDED TO THE OWNER FOLLOWING COMPLETION OF WORK.

GRADING NOTES

- ALL SOIL AND MATERIAL REMOVED FROM THE SITE SHALL BE DISPOSED OF IN ACCORDANCE WITH LOCAL, STATE, AND FEDERAL REQUIREMENTS. ANY GROUNDWATER DE-WATERING PRACTICES SHALL BE PERFORMED UNDER THE SUPERVISION OF A QUALIFIED PROFESSIONAL. THE CONTRACTOR IS REQUIRED TO OBTAIN ALL NECESSARY PERMITS FOR THE DISCHARGE OF DE-WATERED GROUNDWATER. ALL SOIL IMPORTED TO THE SITE SHALL BE CERTIFIED CLEAN FILL CONTRACTOR SHALL
- MAINTAIN RECORDS OF ALL FILL MATERIALS BROUGHT TO THE SITE. THE CONTRACTOR IS REQUIRED TO PROVIDE TEMPORARY AND/OR PERMANENT SHORING WHERE REQUIRED DURING EXCAVATION ACTIVITIES, INCLUDING BUT NOT LIMITED TO UTILITY TRENCHES, TO ENSURE THE STRUCTURAL INTEGRITY OF NEARBY STRUCTURES AND STABILITY OF THE SURROUNDING SOILS
- PROPOSED TOP OF CURB ELEVATIONS ARE GENERALLY 4 INCHES TO 7 INCHES ABOVE EXISTING GRADES UNLESS OTHERWISE NOTED. THE CONTRACTOR WILL SUPPLY ALL STAKEOUT CURB GRADE SHEETS TO STONEFIELD ENGINEERING & DESIGN, LLC. FOR REVIEW AND APPROVAL PRIOR TO POURING CURBS. THE CONTRACTOR IS RESPONSIBLE TO SET ALL PROPOSED UTILITY COVERS AND RESET
- ALL EXISTING UTILITY COVERS WITHIN THE PROJECT LIMITS TO P ACCORDANCE WITH ANY APPLICABLE MUNICIPAL, COUNTY, STATE AND/OR UTILITY AUTHORITY REGULATIONS. MINIMUM SLOPE REQUIREMENTS TO PREVENT PONDING SHALL BE AS FOLLOWS:
- CURB GUTTER: 0.50% CONCRETE SURFACES: 1.00% ASPHALT SURFACES: 1.00% A MINIMUM SLOPE OF 1.00% SHALL BE PROVIDED AWAY FROM ALL BUILDINGS. THE
- CONTRACTOR SHALL ENSURE POSITIVE DRAINAGE FROM THE BUILDING IS ACHIFVED AND SHALL NOTIFY STONEFIELD ENGINEERING & DESIGN, LLC. IF THIS CONDITION CANNOT BE 6. FOR PROJECTS WHERE BASEMENTS ARE PROPOSED, THE DEVELOPER IS RESPONSIBLE TO
- DETERMINE THE DEPTH TO GROUNDWATER AT THE LOCATION OF THE PROPOSED STRUCTURE, IF GROUNDWATER IS ENCOUNTERED WITHIN THE BASEMENT AREA, SPECIAL CONSTRUCTION METHODS SHALL BE UTILIZED AND REVIEWED/APPROVED BY THE CONSTRUCTION CODE OFFICIAL. IF SUMP PUMPS ARE UTILIZED, ALL DISCHARGES SHALL BE CONNECTED DIRECTLY TO THE PUBLIC STORM SEWER SYSTEM WITH APPROVAL FROM THE GOVERNING STORM SEWER SYSTEM AUTHORITY.

ADA NOTES

- I. THE CONTRACTOR SHALL MAINTAIN A MAXIMUM 2.00% SLOPE IN ANY DIRECTION WITHIN THE ADA PARKING SPACES AND ACCESS AISLES. THE CONTRACTOR SHALL PROVIDE COMPLIANT SIGNAGE AT ALL ADA PARKING AREAS IN ACCORDANCE WITH STATE GUIDELINES.
- THE CONTRACTOR SHALL MAINTAIN A MAXIMUM 5.00% RUNNING SLOPE AND A MAXIMUM OF 2.00% CROSS SLOPE ALONG WALKWAYS WITHIN THE ACCESSIBLE PATH OF TRAVEL (SEE THE SITE PLAN FOR THE LOCATION OF THE ACCESSIBLE PATH). THE CONTRACTOR IS RESPONSIBLE TO ENSURE THE ACCESSIBLE PATH OF TRAVEL IS 36 INCHES
- WIDE OR GREATER UNLESS INDICATED OTHERWISE WITHIN THE PLAN SET. THE CONTRACTOR SHALL MAINTAIN A MAXIMUM 2.00% SLOPE IN ANY DIRECTION AT ALL LANDINGS. LANDINGS INCLUDE, BUT ARE NOT LIMITED TO, THE TOP AND BOTTOM OF AN ACCESSIBLE RAMP, AT ACCESSIBLE BUILDING ENTRANCES, AT AN AREA IN FRONT OF A WALK-UP ATM, AND AT TURNING SPACES ALONG THE ACCESSIBLE PATH OF TRAVEL. THE LANDING AREA SHALL HAVE A MINIMUM CLEAR AREA OF 60 INCHES BY 60 INCHES UNLESS INDICATED OTHERWISE WITHIN THE PLAN SET.
- THE CONTRACTOR SHALL MAINTAIN A MAXIMUM 8.33% RUNNING SLOPE AND A MAXIMUM 2.00% CROSS SLOPE ON ANY CURB RAMPS ALONG THE ACCESSIBLE PATH OF TRAVEL. WHERE PROVIDED, CURB RAMP FLARES SHALL NOT HAVE A SLOPE GREATER THAN 10.00% IF A LANDING AREA IS PROVIDED AT THE TOP OF THE RAMP. FOR ALTERATIONS, A CURB RAMP FLARES SHALL NOT HAVE A SLOPE GREATER THAN 8.33% IF A LANDING AREA IS NOT PROVIDED AT THE TOP OF THE RAMP. CURBS RAMPS SHALL NOT RISE MORE THAN 6 INCHES IN ELEVATION WITHOUT A HANDRAIL. THE CLEAR WIDTH OF
- A CURB RAMP SHALL BE NO LESS THAN 36 INCHES WIDE. ACCESSIBLE RAMPS WITH A RISE GREATER THAN 6 INCHES SHALL CONTAIN COMPLIANT HANDRAILS ON BOTH SIDES OF THE RAMP AND SHALL NOT RISE MORE THAN 30" IN ELEVATION WITHOUT A LANDING AREA IN BETWEEN RAMP RUNS. LANDING AREAS SHALL ALSO BE PROVIDED AT THE TOP AND BOTTOM OF THE RAMP.
- 7. A SLIP RESISTANT SURFACE SHALL BE CONSTRUCTED ALONG THE ACCESSIBLE PATH AND WITHIN ADA PARKING AREAS. 8. THE CONTRACTOR SHALL ENSURE A MAXIMUM OF 1/4 INCHES VERTICAL CHANGE IN LEVEL
- ALONG THE ACCESSIBLE PATH. WHERE A CHANGE IN LEVEL BETWEEN 1/4 INCHES AND 1/4 INCHES EXISTS, CONTRACTOR SHALL ENSURE THAT THE TOP 1/4 INCH CHANGE IN LEVEL IS BEVELED WITH A SLOPE NOT STEEPER THAN I UNIT VERTICAL AND 2 UNITS HORIZONTAL (2:1 SLOPE).
- THE CONTRACTOR SHALL ENSURE THAT ANY OPENINGS (GAPS OR HORIZONTAL SEPARATION) ALONG THE ACCESSIBLE PATH SHALL NOT ALLOW PASSAGE OF A SPHERE GREATER THAN 1/2 INCH.

LANDSCAPING NOTES

I. THE CONTRACTOR SHALL RESTORE ALL DISTURBED GRASS AND LANDSCAPED AREAS TO MATCH EXISTING CONDITIONS UNLESS INDICATED OTHERWISE WITHIN THE PLAN SET.

2. THE CONTRACTOR SHALL RESTORE ALL DISTURBED LAWN AREAS WITH A MINIMUM 4 INCH LAYER OF TOPSOIL AND SEED. 3. THE CONTRACTOR SHALL RESTORE MULCH AREAS WITH A MINIMUM 3 INCH LAYER OF MULCH . 4. THE MAXIMUM SLOPE ALLOWABLE IN LANDSCAPE RESTORATION AREAS SHALL BE 3 FEET HORIZONTAL TO I FOOT

VERTICAL (3:1 SLOPE) UNLESS INDICATED OTHERWISE WITHIN THE PLAN SET. 5. THE CONTRACTOR IS REQUIRED TO LOCATE ALL SPRINKLER HEADS IN AREA OF LANDSCAPING DISTURBANCE PRIOR TO CONSTRUCTION. THE CONTRACTOR SHALL RELOCATE SPRINKLER HEADS AND LINES IN ACCORDANCE WITH OWNER'S

DIRECTION WITHIN AREAS OF DISTURBANCE. 6. THE CONTRACTOR SHALL ENSURE THAT ALL DISTURBED LANDSCAPED AREAS ARE GRADED TO MEET FLUSH AT THE ELEVATION OF WALKWAYS AND TOP OF CURB ELEVATIONS EXCEPT UNLESS INDICATED OTHERWISE WITHIN THE PLAN

STABILIZATION SPECIFICATIONS:

I.A. TEMPORARY SEEDING AND MULCHING:

	GROUND LIMESTONE - APPLIED UNIFORMLY ACCORDING TO SOIL TEST RECOMMENDATIONS.
	FERTILIZER - APPLY IILBS./1,000 SF OF 10-20-10 OR EQUIVALENT WITH 50% WATER INSOLUBLE NITROGEN
	(UNLESS A SOIL TEST INDICATES OTHERWISE) WORKED INTO THE SOIL A MINIMUM OF 4".
	SEED - PERENNIAL RYEGRASS 100 LBS./ACRE (2.3 LBS./1,000 SF) OR OTHER APPROVED SEEDS; PLANT BETWEEN
	MARCH I AND MAY 15 OR BETWEEN AUGUST 15 AND OCTOBER I.
	MULCH - UNROTTED STRAW OR HAY AT A RATE OF 70 TO 90 LBS./1,000 SF APPLIED TO ACHIEVE 95% SOI
	surface coverage. Mulch shall be anchored by approved methods (i.e. peg and twine
	MULCH NETTING, OR LIQUID MULCH BINDER).
I.B.	PERMANENT SEEDING AND MULCHING:

TOPSOIL - UNIFORM APPLICATION TO A DEPTH OF 5" (UNSETTLED).

FERTILIZER - APPLY 11 LBS./1,000 SF OF 10-10-10 OR EQUIVALENT WITH 50% WATER INSOLUBLE NITROGEN (UNLESS A SOIL TEST INDICATES OTHERWISE) WORKED INTO THE SOIL A MINIMUM OF 4". SEED - TURF TYPE TALL FESCUE (BLEND OF 3 CULTIVARS) 350 LBS./ACRE (8 LBS./1.000 SF) OR OTHER APPROVED SEEDS; PLANT BETWEEN MARCH I AND OCTOBER I (SUMMER SEEDINGS REQUIRE IRRIGATION) MULCH - UNROTTED STRAW OR HAY AT A RATE OF 70 TO 90 LBS./1,000 SF APPLIED TO ACHIEVE 95% SOIL SURFACE COVERAGE. MULCH SHALL BE ANCHORED BY APPROVED METHODS (I.E. PEG AND TWINE,

SOIL CHARACTE	RISTICS CHART
TYPE OF SOIL	URBAN LAND (URTILB)
PERCENT OF SITE COVERAGE	100.0%

GROUND LIMESTONE - APPLIED UNIFORMLY ACCORDING TO SOIL TEST

MULCH NETTING, OR LIQUID MULCH BINDER).

RECOMMENDATIONS.

SET, NO ABRUPT CHANGES IN GRADE ARE PERMITTED IN DISTURBED LANDSCAPING AREAS.

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SEAL

Frank I Minervini AlA NJ License # 12576 NY License # 03 0297 63 Anthony C. Vandermark, Jr. AlA NJ License # 1769 NY License # 32710-1 Adrian Melia, AlA NJ License # 18738 Ciaran Kelly, AIA NJ License # 18866



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> ARTHUR KUYAN, P.E. NEW JERSEY LICENSE No. 55741 LICENSED PROFESSIONAL ENGINEE

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5	03/25/2022	JCMUA REVISIONS
4	09/03/2021	ISSUED FOR BID
3	07/02/2021	CD 90%
2	06/07/2021	CD 75%
1	04/09/2021	CD 50%
#	Date	Issue
Pro	ject Title	

SUMMIT TOWER


622-628 SUMMIT AVE JERSEY CITY, NEW JERSEY 07306 BLOCK 6701, LOT 21.01


Project Description PROPOSED NEW MIXED USE BUILDING WITH 209 RESIDENTIAL UNITS

Applicant 628 SUMMIT AVE, LLC


Project Number: T-18276 Drawn by KB Checked by : KB Scale As Noted

Sheet Title CONSTRUCTION NOTES

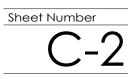

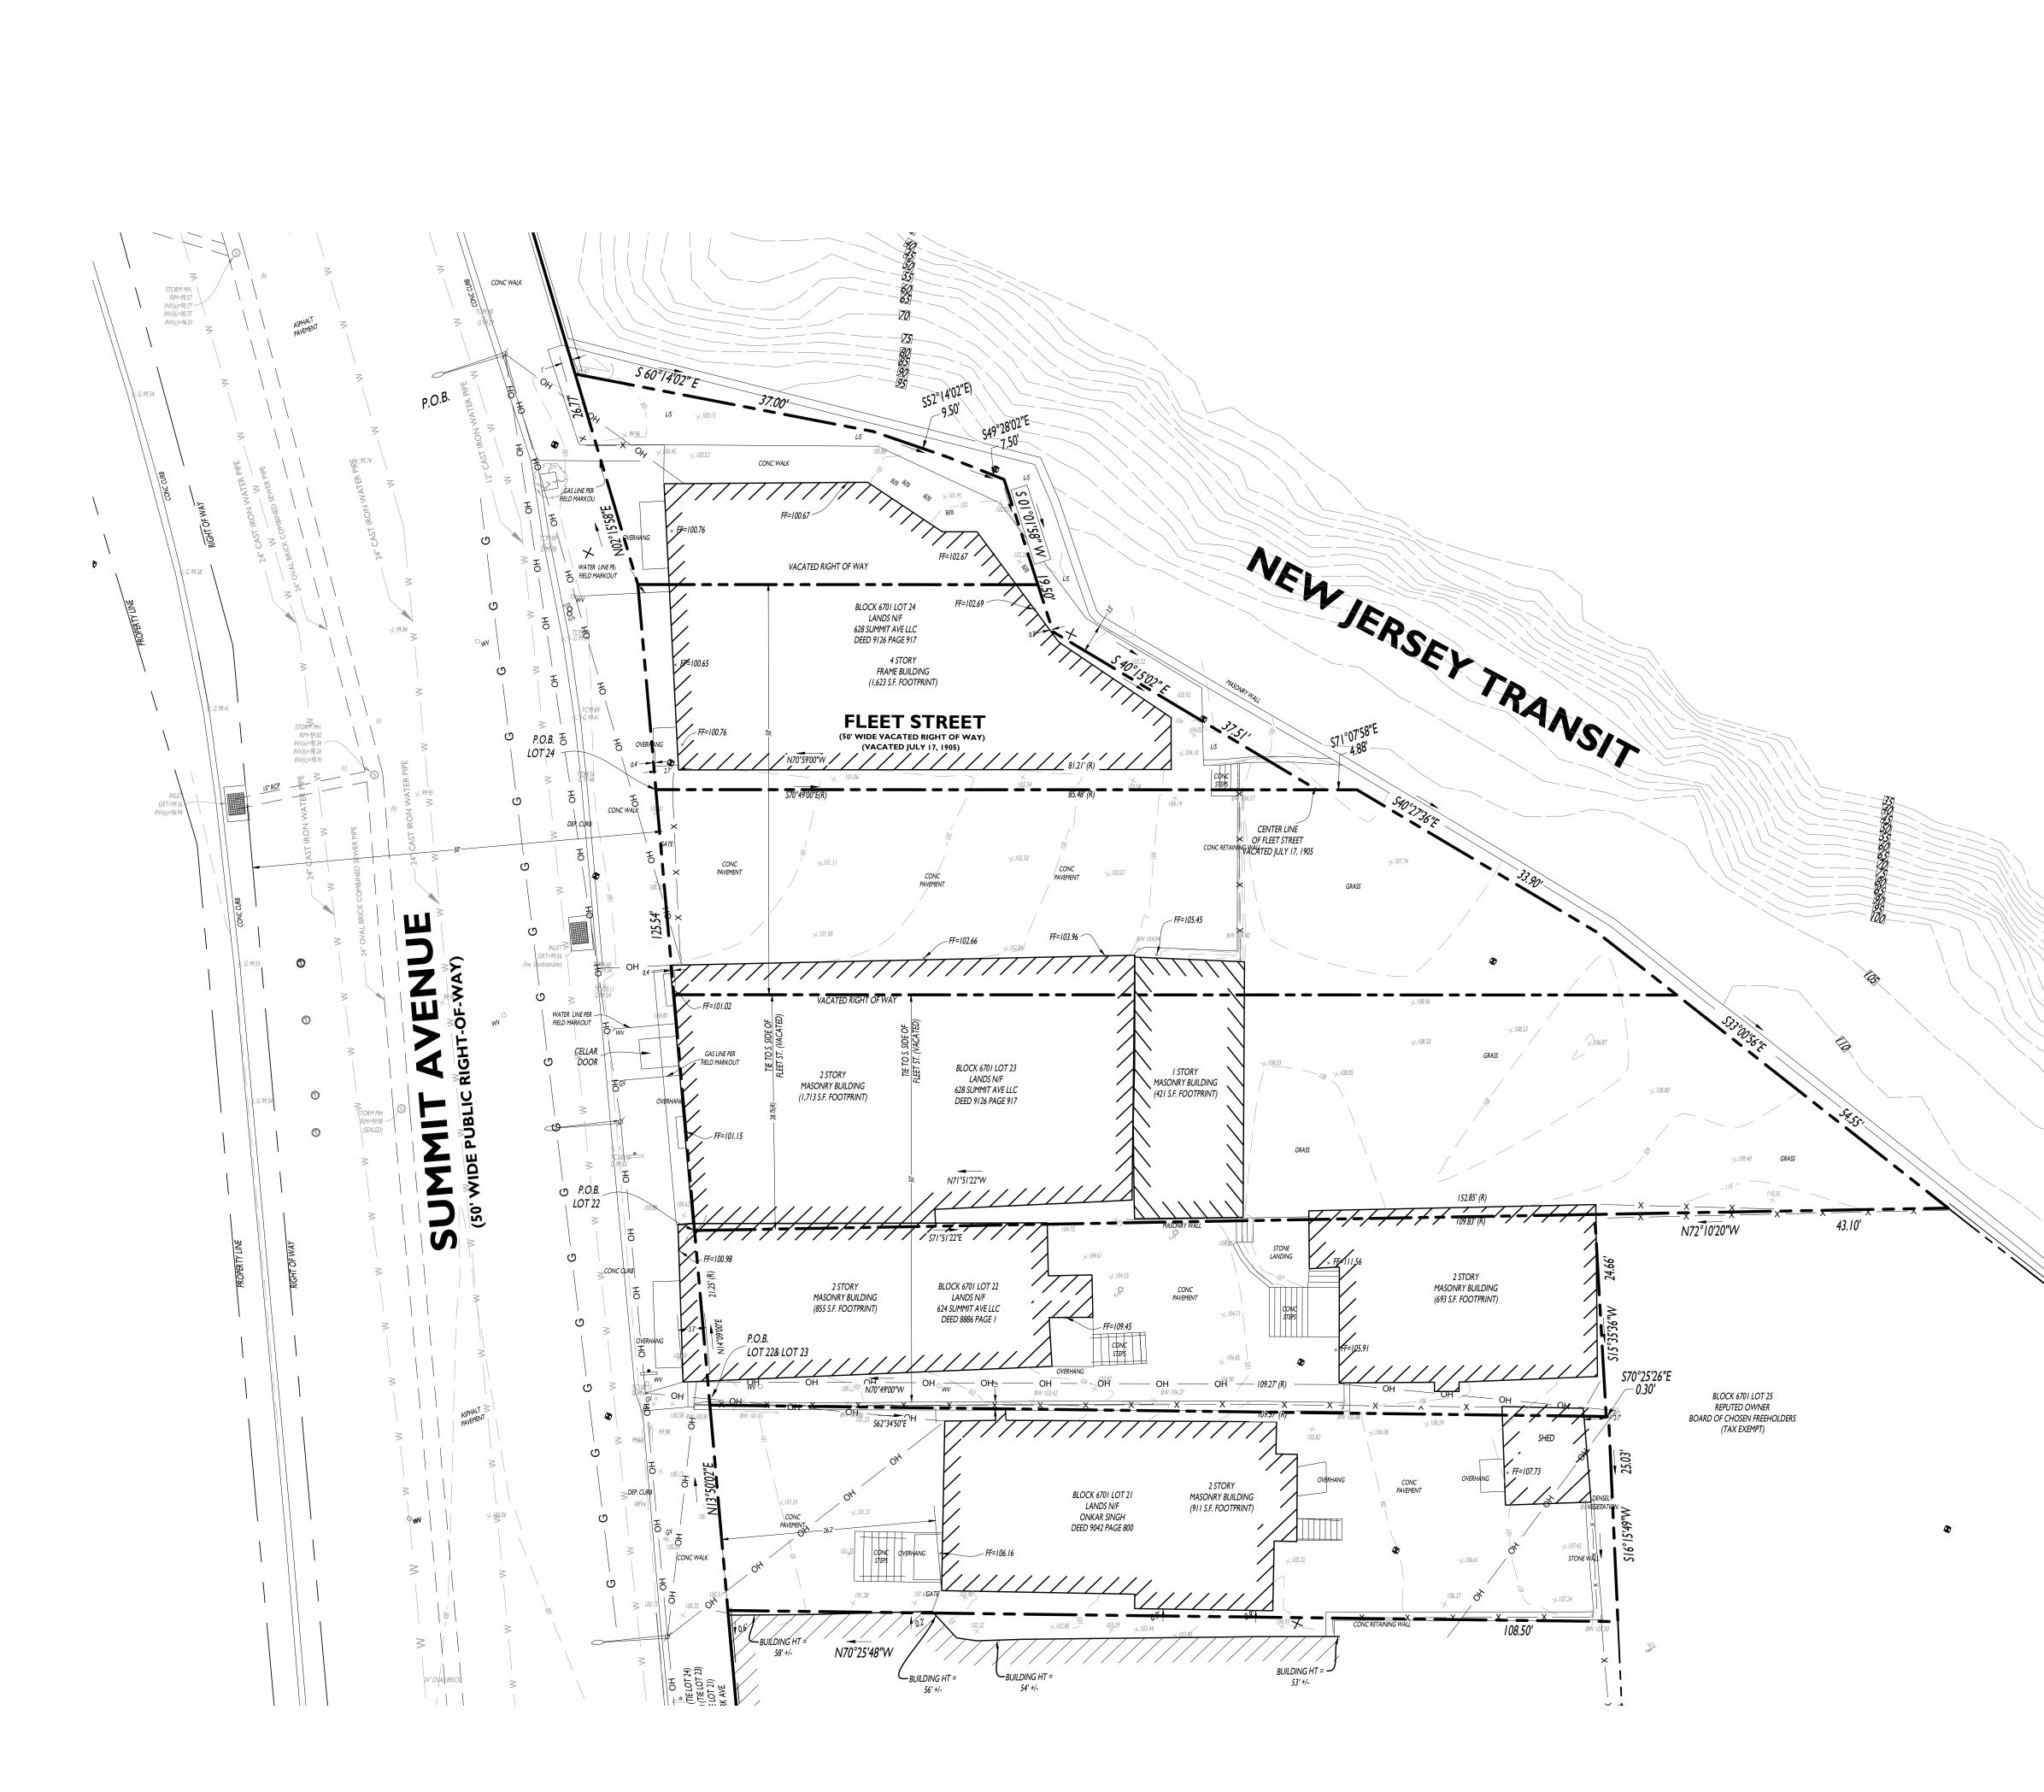

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SURVEY NOTES

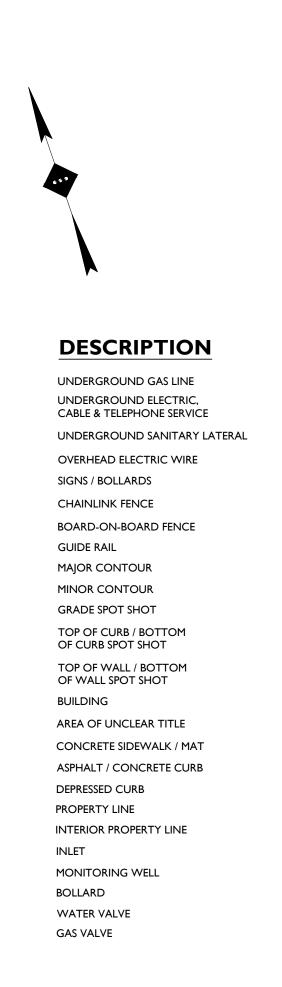- . THIS SURVEY AND THE BOUNDARIES SHOWN HEREON ARE THE RESULT OF AN ACTUAL FIELD SURVEY PERFORMED DURING OCTOBER OF 2018, BASED ON AVAILABLE MAPS AND DEEDS OF RECORD, AND PHYSICAL EVIDENCE. THIS SURVEY IS SUBJECT TO ALL EASEMENTS, RIGHTS OF WAYS AND AGREEMENTS OF RECORD THAT A TITLE SEARCH MAY DISCLOSE.
- THIS SURVEY IS VALID ONLY WHEN AN EMBOSSED SEAL IS AFFIXED HERETO.
 THE CERTIFICATION SHOWN HEREON IS NOT TRANSFERABLE TO ADDITIONAL

SYMBOL

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- INSTITUTIONS OR SUBSEQUENT OWNERS. 4. UNAUTHORIZED ALTERATION OR ADDITION TO THIS SURVEY IS A VIOLATION OF SECTION JAMA OF THE NEW YORK STATE FOLLOWING AND
- SECTION 7209 OF THE NEW YORK STATE EDUCATION LAW.
 5. ANY SUBSURFACE UTILITIES SHOWN HAVE BEEN LOCATED FROM MARKOUTS OBSERVED ON SITE DURING THE FIELD SURVEY, AND SURFACE FEATURES SUCH AS VALVES, MANHOLES AND GRATES. STORM DRAINAGE AND OR SANITARY INVERTS ARE DEPICTED BASED ON OBSERVATIONS MADE IN THE FIELD. THE SURVEYOR MAKES NO GUARANTEES THAT THE UNDERGROUND UTILITIES SHOWN COMPRISE ALL SUCH UTILITIES IN THE AREA, EITHER IN SERVICE OR ABANDONED. THE SURVEYOR FURTHER DOES NOT WARRANT THAT THE UNDERGROUND UTILITIES SHOWN ARE IN THE EXACT LOCATION INDICATED, ALTHOUGH THEY ARE LOCATED AS ACCURATELY AS POSSIBLE FROM INFORMATION USED. THE SURVEY HAS NOT PHYSICALLY LOCATED THE UTILITIES. BEFORE ANY EXCAVATIONS ARE BEGUN, THE PROPER UTILITY AGENCIES MUST BE CONTACTED FOR VERIFICATION OF UTILITY TYPE AND FOR FIELD LOCATIONS.
 6. BEARINGS ARE REFERENCED TO THE NY STATE PLANE COORDINATE SYSTEM, NAD 83
- (2011). ELEVATIONS SHOWN HEREON ARE REFERENCED TO THE NORTH AMERICAN VERTICAL DATUM OF 1988 (NAVD 88), ESTABLISHED VIA RTK GPS OBSERVATIONS.
- 5. 7 BENCHMARK = MAG NAIL ELEVATION = 99.79' 6. FIELD DATE OCTOBER 31, 2018

SURVEY REFERENCES

- . DEED BETWEEN MITA R. PATEL (GRANTOR) AND ONKAR SINGH (GRANTEE) RECORDED IN THE HUDSON COUNTY REGISTER OF DEEDS AS BOOK 9042 PAGE 800.
- 2. DEED BETWEEN SUKHMINDER KAUR (GRANTOR) AND 624 SUMMIT AVE LLC (GRANTEE) RECORDED IN THE HUDSON COUNTY REGISTER OF DEEDS AS BOOK 9131 PAGE 525.
- 3. DEED BETWEEN PETER E. JR., BRUCE W., DEBORAH ANN GARVIN, KATHLEEN M. KACHEL, EXECUTRIX OF THE ESTATE OF RICHARD G. KACHEL (GRNATOR) AND JOHN LIU CONNIELIU (GRANTEE) RECORDED IN THE HUDSON COUNTY REGISTER OF DEEDS AS BOOK 8635 PAGE 488.
- 4. DEED BETWEEN SUKHMINDER KAUR (GRANTOR) AND 624 SUMMIT AVE LLC (GRANTEE) RECORDED IN THE HUDSON COUNTY REGISTER OF DEEDS AS BOOK 9126 PAGE 917

SURVEY NOTES:

I. THE SURVEY LISTED WITHIN THE PLAN REFERENCES ON THE COVER SHEET SHALL BE CONSIDERED A PART OF THIS PLAN SET AND ALL INFORMATION CONTAINED WITHIN THE SURVEY AND ASSOCIATED DOCUMENTS SHALL BE UTILIZED IN CONJUNCTION WITH THIS PLAN SET. THE CONTRACTOR IS RESPONSIBLE TO OBTAIN A COPY OF THE SURVEY AND REVIEW IT THOROUGHLY PRIOR TO THE START OF CONSTRUCTION.

GRAPHIC SCALE IN FEET |" = |0'

Minervini Vandermark Melia Kelly

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ARTHUR KUYAN, P.E. NEW JERSEY LICENSE No. 55741 LICENSED PROFESSIONAL ENGINEER

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2	06/07/2021	CD 75%
1	04/09/2021	CD 50%
#	Date	Issue
	1	1

SUMMIT TOWER

622-628 SUMMIT AVE JERSEY CITY, NEW JERSEY 07306 BLOCK 6701, LOT 21.01

Project Description

PROPOSED NEW MIXED USE BUILDING WITH 209 RESIDENTIAL UNITS

Applicant 628 SUMMIT AVE, LLC

Project Title

Project Number :T-18276Drawn by:KBChecked by:KB


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Scale


EXISTING CONDITIONS





SYMBOL

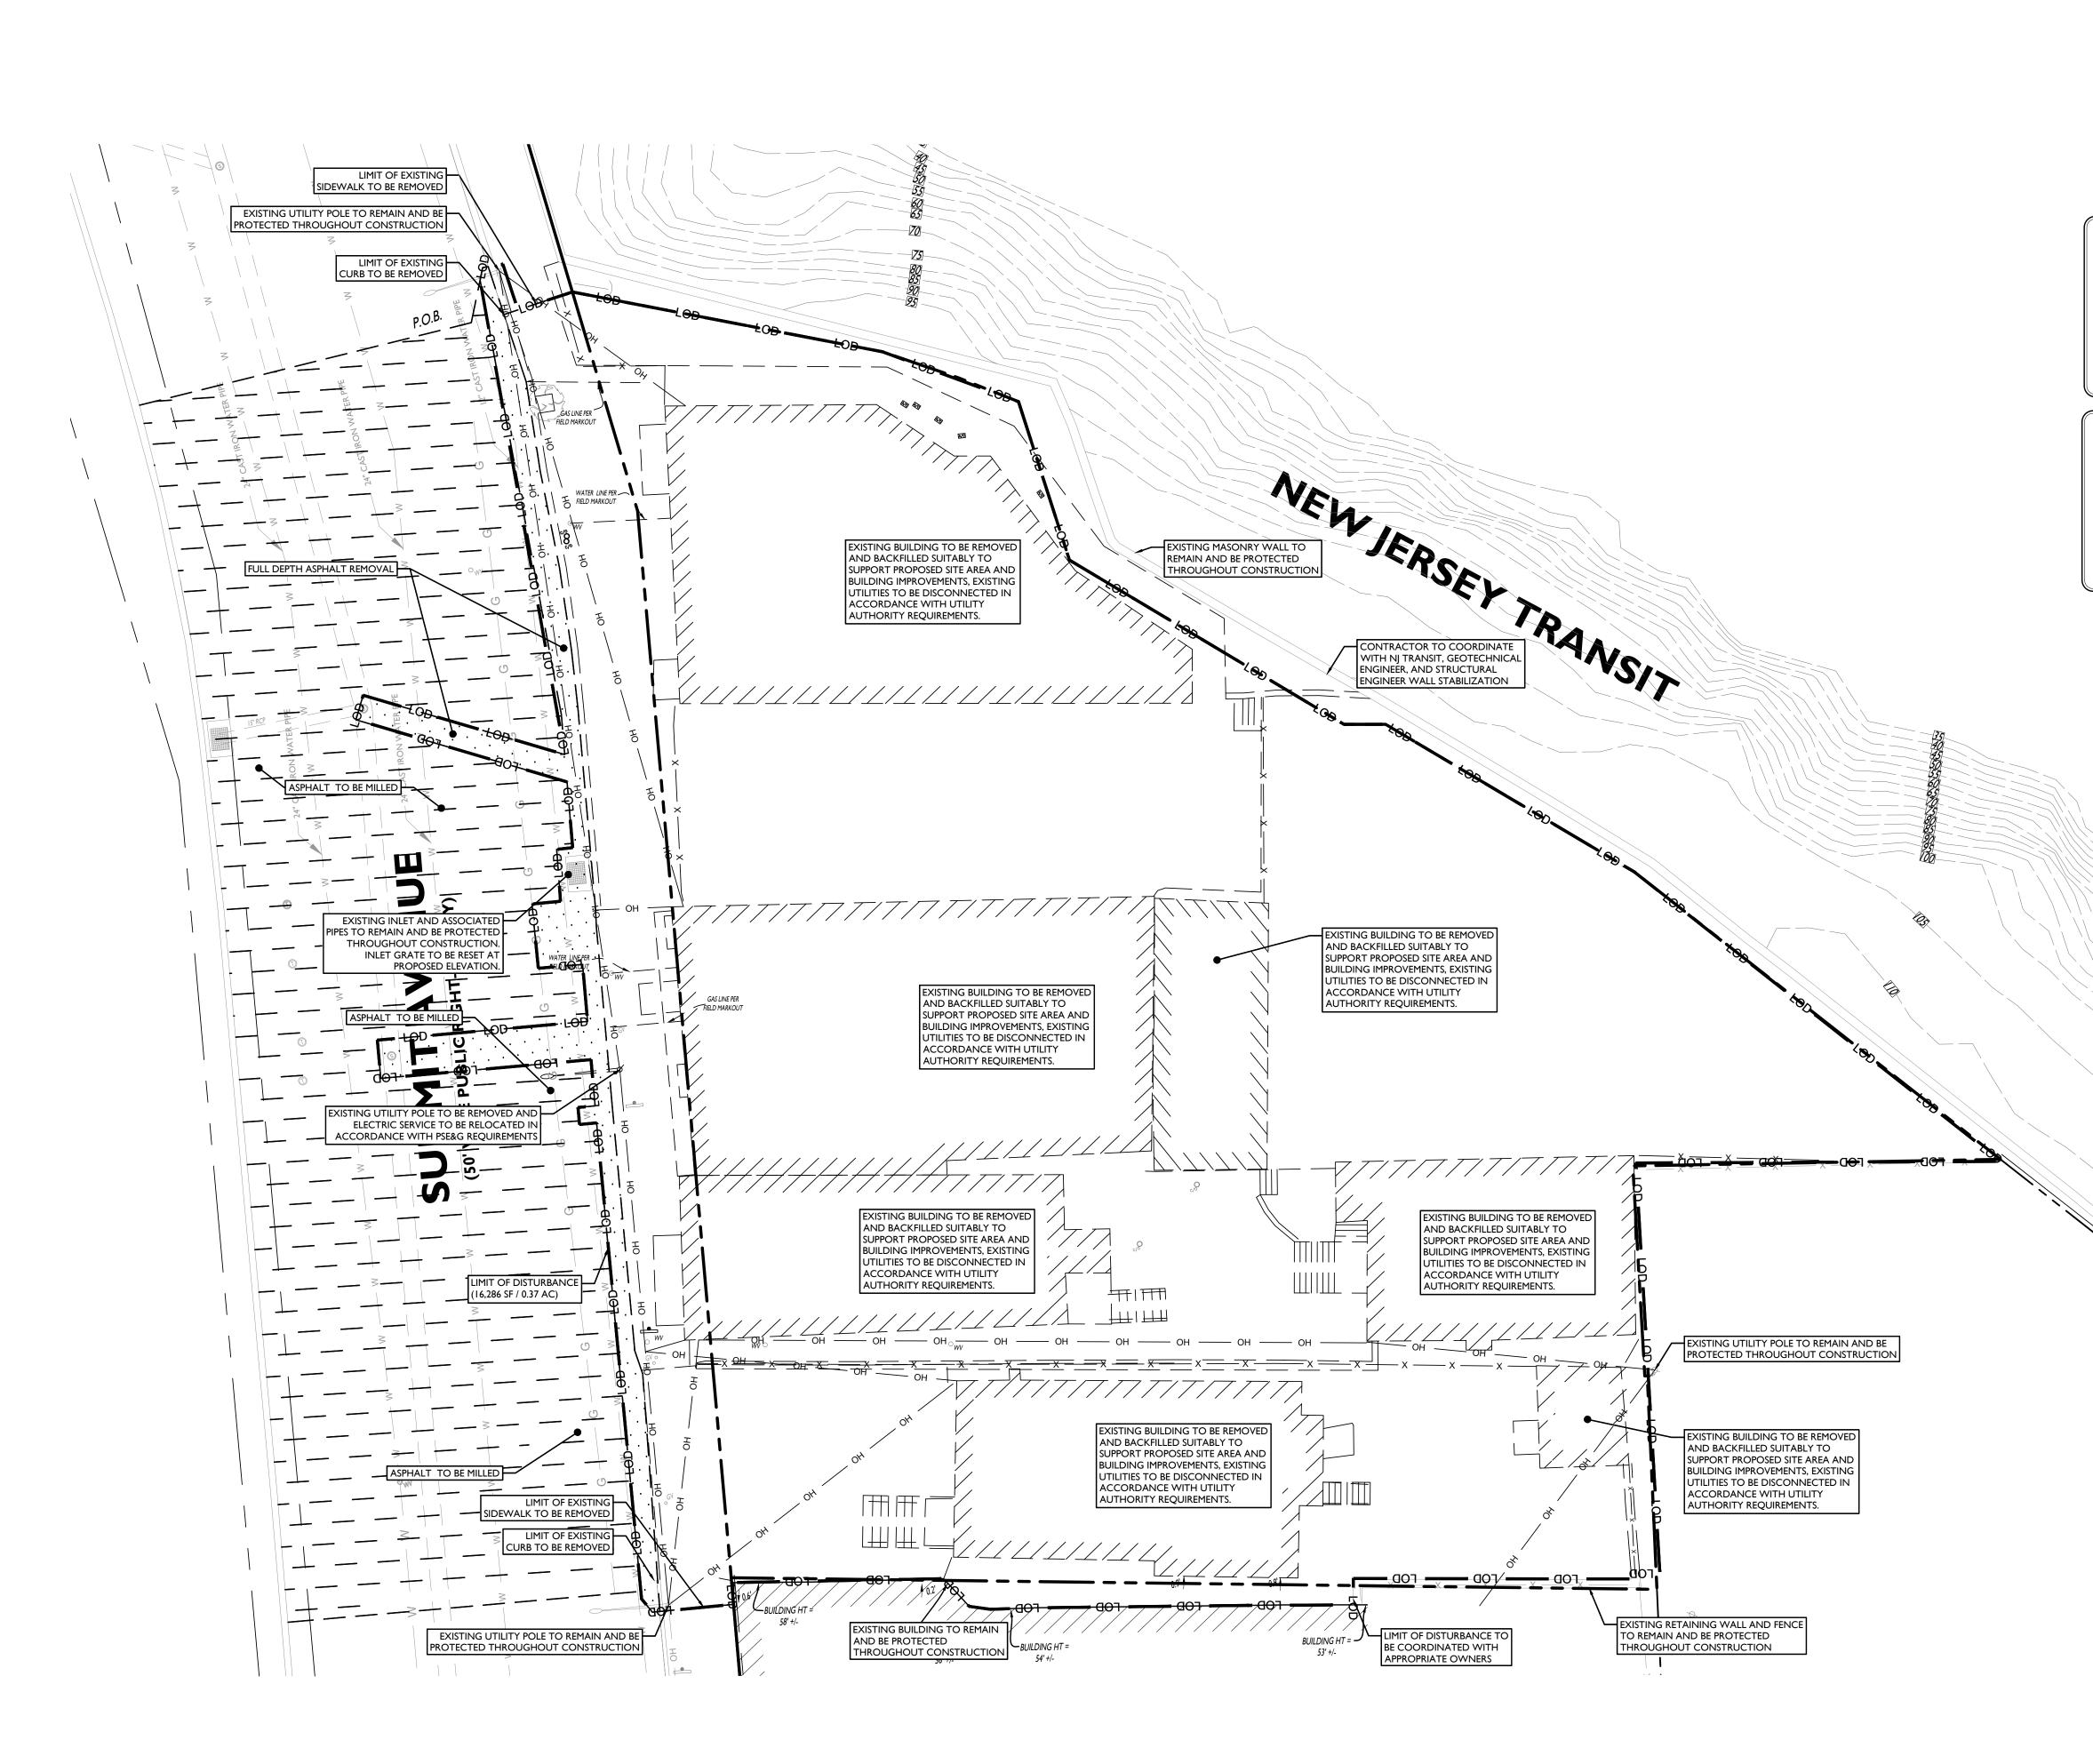DESCRIPTION

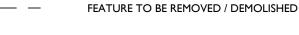

LOD -----

LIMIT OF DISTURBANCE

ALL DEMOLITION MATERIAL AND DEBRIS AND ALL ITEMS REMOVED FROM THE PROPERTY AND THE PUBLIC AREAS ADJACENT, SHALL BE DISPOSED OUTSIDE THE CITY LIMITS OF JERSEY CITY IN ACCORDANCE WITH THE RULES AND REGULATIONS OF THE CITY'S ENVIRONMENTAL COMMISSION AND IN ACCORDANCE WITH THE REGULATIONS AND LAWS OF THE NJDEP.

ALL SITE FEATURES WITHIN THE LIMIT OF DISTURBANCE INDICATED ON THIS PLAN ARE TO BE REMOVED / DEMOLISHED UNLESS OTHERWISE NOTED. THE CONTRACTOR SHALL NOTIFY STONEFIELD ENGINEERING & DESIGN, LLC. IF SIGNIFICANT DISCREPANCIES ARE DISCERNED BETWEEN THIS PLAN AND FIELD CONDITIONS



Know what's **below Call** before you dig.

DEMOLITION NOTES

- I. THE WORK REFLECTED ON THE DEMOLITION PLAN IS TO PROVIDE GENERAL INFORMATION TOWARDS THE EXISTING ITEMS TO BE DEMOLISHED AND/OR REMOVED. THE CONTRACTOR IS RESPONSIBLE TO REVIEW THE ENTIRE PLAN SET AND ASSOCIATED REPORTS/REFERENCE DOCUMENTS INCLUDING ALL DEMOLITION ACTIVITIES AND INCIDENTAL TASKS NECESSARY TO COMPLETE THE SITE IMPROVEMENTS.
- THE CONTRACTOR IS RESPONSIBLE TO DETERMINE THE MEANS AND METHODS OF DEMOLITION ACTIVITIES.
 EXPLOSIVES SHALL NOT BE USED UNLESS WRITTEN CONSENT FROM BOTH THE OWNER AND ANY APPLICABLE GOVERNING AGENCY IS OBTAINED. BEFORE THE START OF ANY EXPLOSIVE PROGRAM, THE CONTRACTOR IS RESPONSIBLE TO OBTAIN ALL LOCAL, STATE, AND FEDERAL PERMITS. ADDITIONALLY, THE CONTRACTOR WILL BE
- RESPONSIBLE FOR ALL SEISMIC TESTING AS REQUIRED AND ANY DAMAGES AS THE RESULT OF SAID DEMOLITION PRACTICES.
 ALL DEMOLITION ACTIVITIES SHALL BE PERFORMED IN ACCORDANCE WITH LOCAL, STATE, AND FEDERAL CODES. THE CONTRACTOR IS RESPONSIBLE FOR ENSURING ALL UTILITIES ARE DISCONNECTED IN ACCORDANCE WITH THE UTILITY AUTHORITY'S REQUIREMENTS PRIOR TO STARTING THE DEMOLITION OF ANY STRUCTURE. ALL EXCAVATIONS ASSOCIATED WITH DEMOLISHED STRUCTURES OR REMOVED TANKS SHALL BE BACKFILLED WITH SUITABLE MATERIAL AND COMPACTED TO SUPPORT SITE AND BUILDING IMPROVEMENTS. A GEOTECHNICAL ENGINEER SHOULD BE PRESENT DURING BACKFILLING ACTIVITIES TO OBSERVE AND CERTIFY THAT BACKFILL
- MATERIAL WAS COMPACTED TO A SUITABLE CONDITION. 5. DEMOLISHED DEBRIS SHALL NOT BE BURIED ON SITE. ALL WASTE/DEBRIS GENERATED FROM DEMOLITION ACTIVITIES SHALL BE DISPOSED OF IN ACCORDANCE WITH ALL LOCAL, STATE AND FEDERAL REQUIREMENTS. THE CONTRACTOR IS RESPONSIBLE TO MAINTAIN ALL RECORDS OF THE DISPOSAL TO DEMONSTRATE COMPLIANCE WITH THE ABOVE REGULATIONS.

GRAPHIC SCALE IN FEET 1" = 10'

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#	Date	Issue

SUMMIT TOWER

622-628 SUMMIT AVE JERSEY CITY, NEW JERSEY 07306 BLOCK 6701, LOT 21.01

Project Description PROPOSED NEW MIXED USE

BUILDING WITH 209 RESIDENTIAL UNITS


Applicant 628 SUMMIT AVE, LLC

Project Title


Project Number:T-18276Drawn by:KBChecked by:KBScale:As Noted

Sheet Title DEMOLITION PLAN

Sheet Number

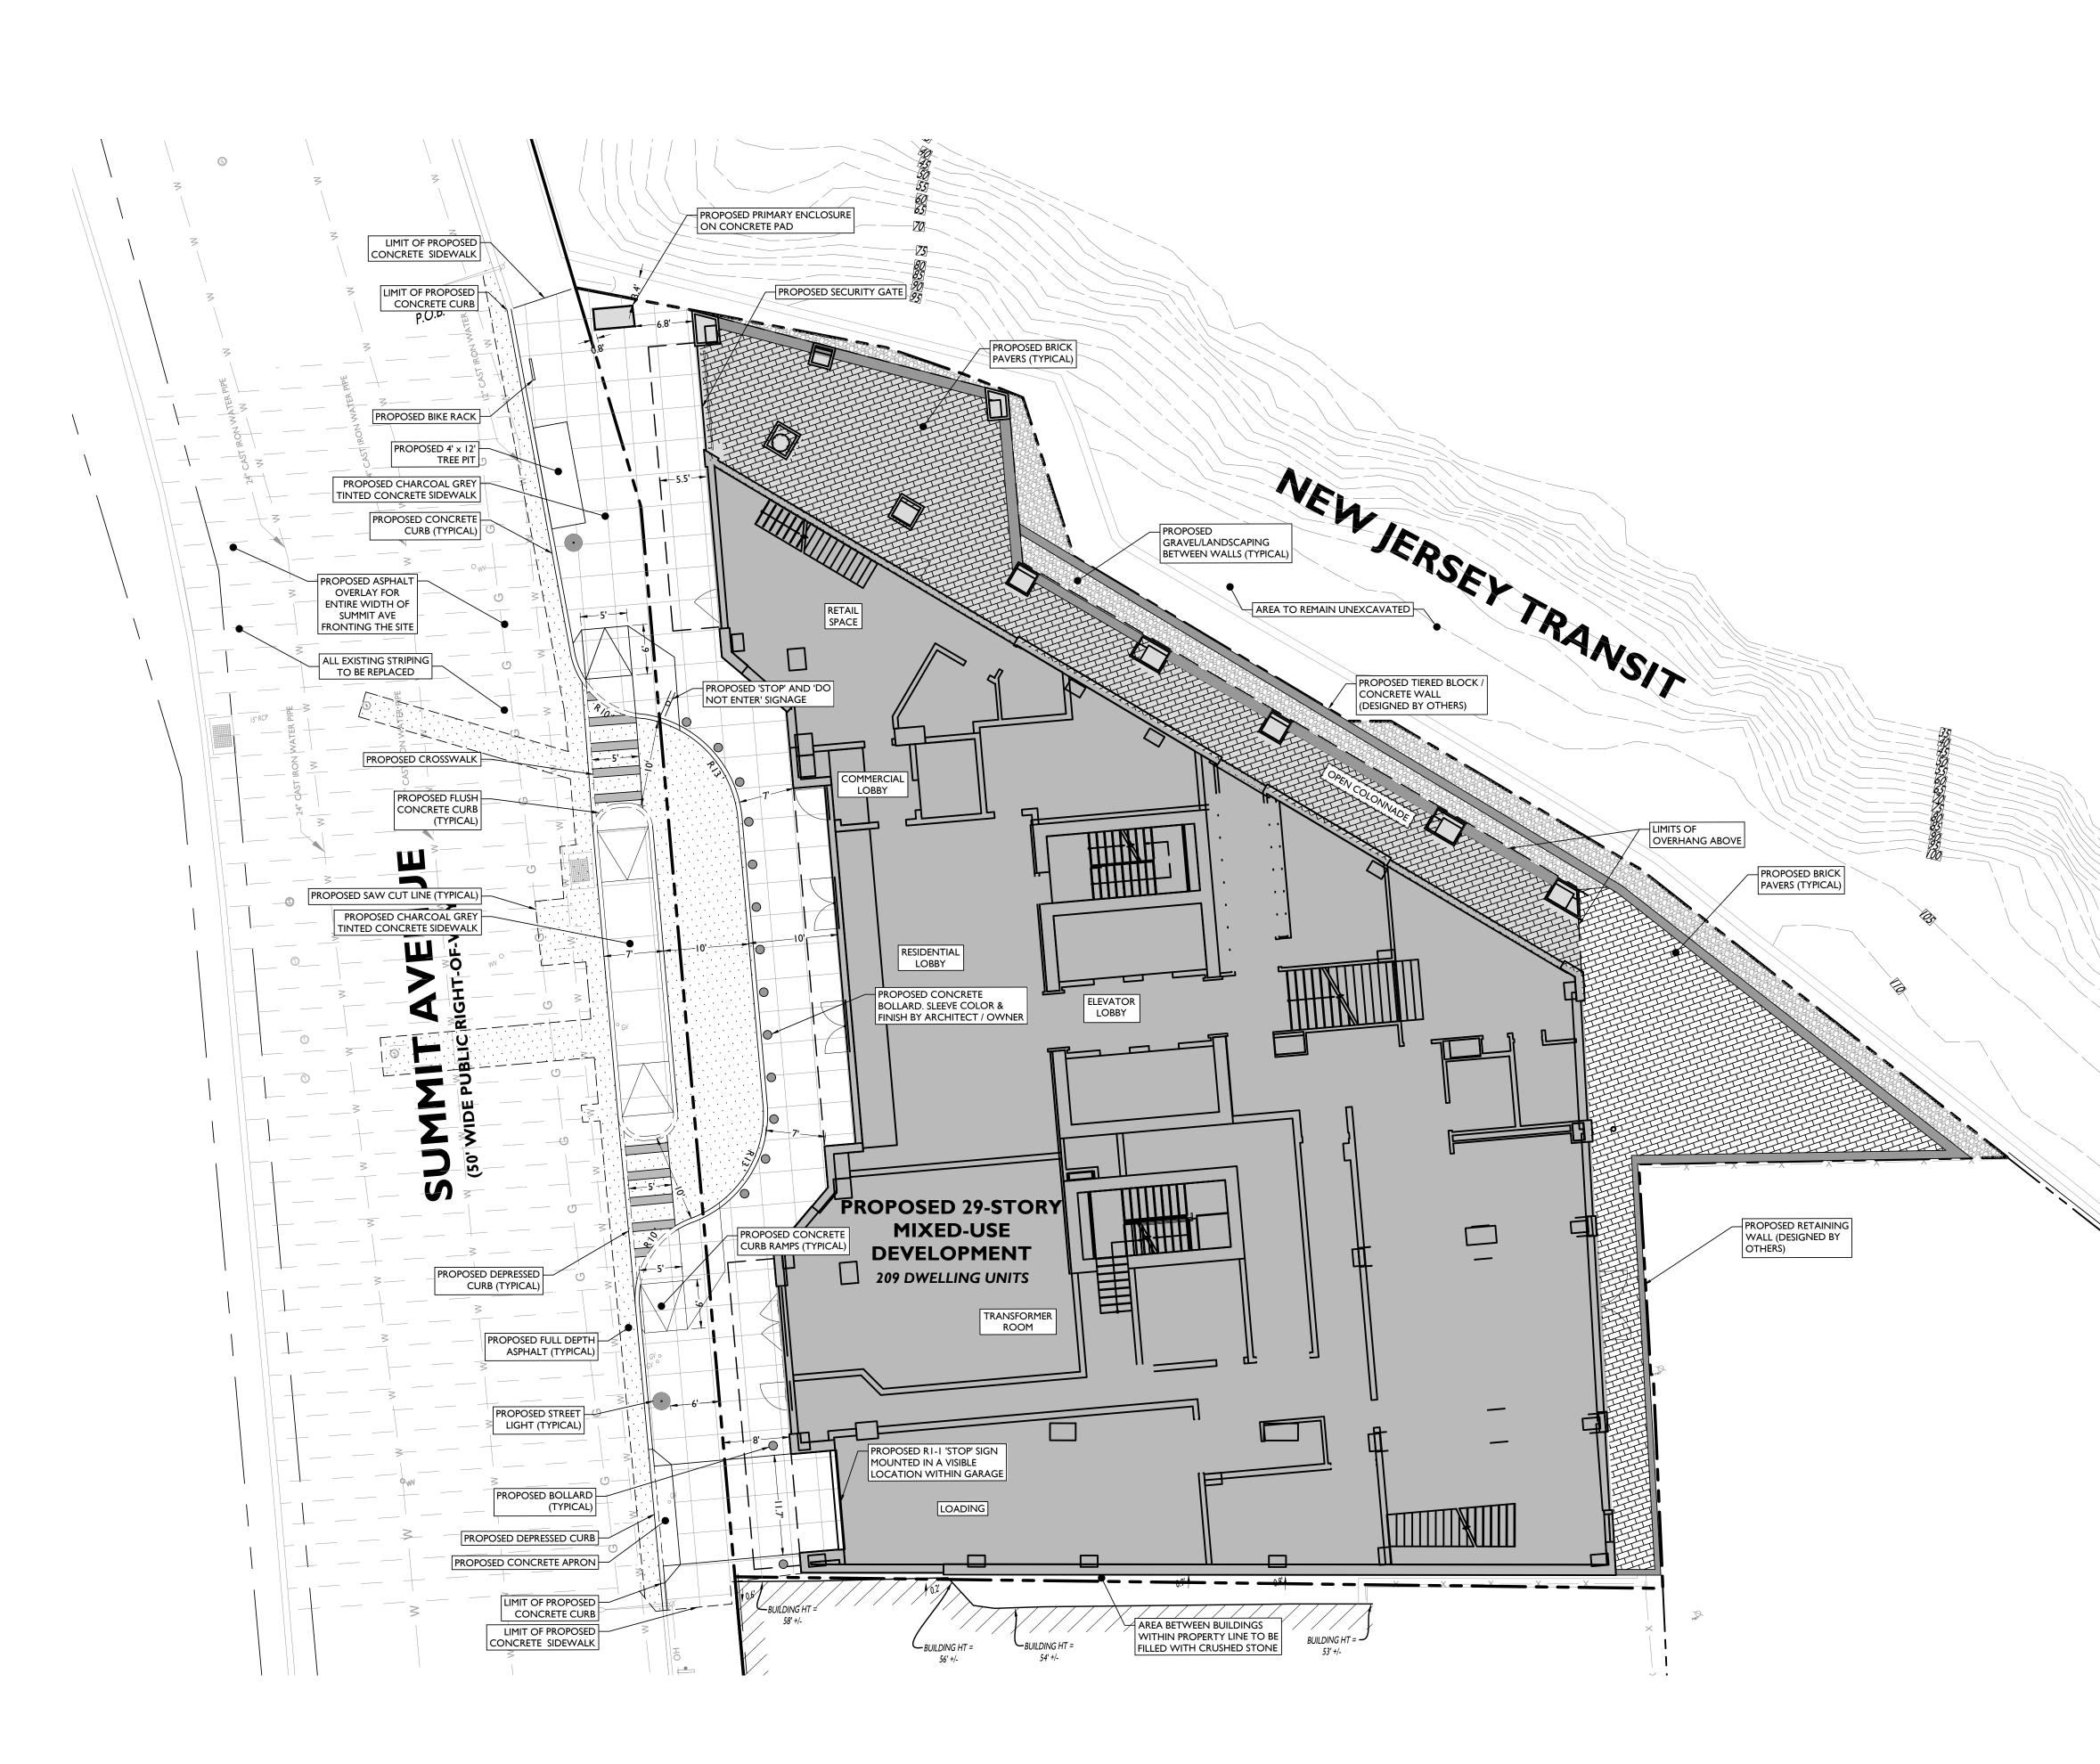

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DESCRIPTION

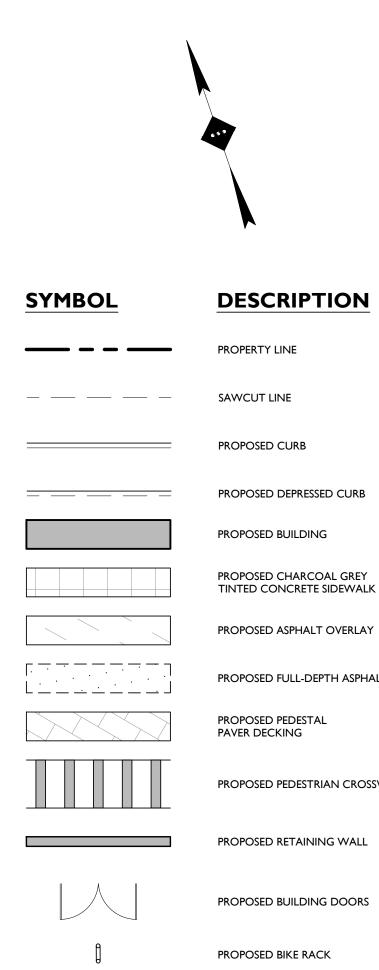PROPOSED DEPRESSED CURB

PROPOSED BUILDING

TINTED CONCRETE SIDEWALK

PROPOSED FULL-DEPTH ASPHALT

PROPOSED PEDESTAL

PROPOSED PEDESTRIAN CROSSWALK

PROPOSED RETAINING WALL

PROPOSED BUILDING DOORS

PROPOSED BIKE RACK

PROPOSED PROTECTIVE GLASS RAILING

ALL TRAFFIC SIGNAGE AND PAVEMENT MARKINGS SHALL BE **REINSTALLED UPON COMPLETION** OF CONSTRUCTION

--

GENERAL NOTES

- I. THE CONTRACTOR SHALL VERIFY AND FAMILIARIZE THEMSELVES WITH THE EXISTING SITE CONDITIONS AND THE PROPOSED SCOPE OF WORK (INCLUDING DIMENSIONS, LAYOUT, ETC.) PRIOR TO INITIATING THE IMPROVEMENTS IDENTIFIED WITHIN THESE DOCUMENTS. SHOULD ANY DISCREPANCY BE FOUND BETWEEN THE EXISTING SITE CONDITIONS AND THE PROPOSED WORK THE CONTRACTOR SHALL NOTIFY STONEFIELD ENGINEERING &
- DESIGN, LLC. PRIOR TO THE START OF CONSTRUCTION. THE CONTRACTOR SHALL OBTAIN ALL NECESSARY PERMITS AND ENSURE THAT ALL REQUIRED APPROVALS HAVE BEEN OBTAINED PRIOR TO THE START OF CONSTRUCTION. COPIES OF ALL REQUIRED PERMITS AND APPROVALS SHALL BE KEPT ON SITE AT ALL TIMES DURING CONSTRUCTION.
- 3. ALL CONTRACTORS WILL, TO THE FULLEST EXTENT PERMITTED BY LAW, INDEMNIFY AND HOLD HARMLESS STONEFIELD ENGINEERING & DESIGN, LLC. AND IT'S SUB-CONSULTANTS FROM AND AGAINST ANY DAMAGES AND LIABILITIES INCLUDING ATTORNEY'S FEES ARISING OUT OF CLAIMS BY EMPLOYEES OF THE CONTRACTOR IN ADDITION TO CLAIMS CONNECTED TO THE PROJECT AS A RESULT OF NOT CARRYING THE PROPER INSURANCE FOR WORKERS COMPENSATION, LIABILITY INSURANCE, AND LIMITS OF COMMERCIAL GENERAL LIABILITY INSURANCE.
- THE CONTRACTOR SHALL NOT DEVIATE FROM THE PROPOSED IMPROVEMENTS IDENTIFIED WITHIN THIS PLAN SET UNLESS APPROVAL IS PROVIDED IN WRITING BY STONEFIELD ENGINEERING & DESIGN, LLC.
- 5. THE CONTRACTOR IS RESPONSIBLE TO DETERMINE THE MEANS AND METHODS OF CONSTRUCTION. 6. THE CONTRACTOR SHALL NOT PERFORM ANY WORK OR CAUSE DISTURBANCE ON A PRIVATE PROPERTY NOT CONTROLLED BY THE PERSON OR ENTITY WHO HAS AUTHORIZED THE WORK WITHOUT PRIOR WRITTEN CONSENT FROM THE OWNER OF THE
- PRIVATE PROPERTY. 7. THE CONTRACTOR IS RESPONSIBLE TO RESTORE ANY DAMAGED OR UNDERMINED STRUCTURE OR SITE FEATURE THAT IS IDENTIFIED TO REMAIN ON THE PLAN SET. ALL REPAIRS SHALL USE NEW MATERIALS TO RESTORE THE FEATURE TO ITS EXISTING CONDITION AT THE CONTRACTORS EXPENSE.
- 8. CONTRACTOR IS RESPONSIBLE TO PROVIDE THE APPROPRIATE SHOP DRAWINGS, PRODUCT DATA, AND OTHER REQUIRED SUBMITTALS FOR REVIEW. STONEFIELD ENGINEERING & DESIGN, LLC. WILL REVIEW THE SUBMITTALS IN ACCORDANCE WITH THE DESIGN INTENT AS REFLECTED WITHIN THE PLAN SET.
- 9. THE CONTRACTOR IS RESPONSIBLE FOR TRAFFIC CONTROL IN ACCORDANCE WITH MANUAL ON UNIFORM TRAFFIC CONTROL DEVICES, LATEST EDITION. 10. THE CONTRACTOR IS REQUIRED TO PERFORM ALL WORK IN THE PUBLIC RIGHT-OF-WAY IN ACCORDANCE WITH THE APPROPRIATE GOVERNING AUTHORITY AND SHALL BE
- RESPONSIBLE FOR THE PROCUREMENT OF STREET OPENING PERMITS. 11. THE CONTRACTOR IS REQUIRED TO RETAIN AN OSHA CERTIFIED SAFETY INSPECTOR TO BE PRESENT ON SITE AT ALL TIMES DURING CONSTRUCTION & DEMOLITION ACTIVITIES.
- 12. SHOULD AN EMPLOYEE OF STONEFIELD ENGINEERING & DESIGN, LLC. BE PRESENT ON SITE AT ANY TIME DURING CONSTRUCTION, IT DOES NOT RELIEVE THE CONTRACTOR OF ANY OF THE RESPONSIBILITIES AND REQUIREMENTS LISTED IN THE NOTES WITHIN THIS PLAN

GRAPHIC SCALE IN FEET |" = |0'

MVMK 1 Andermark Melia Kelly Architecture + Design 360 14th St. , Hoboken, NJ, 07030 T. 201-386-0637 E. info@mvmkarchitecture.com www.mvmkarchitecture.com

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SUMMIT TOWER

622-628 SUMMIT AVE JERSEY CITY, NEW JERSEY 07306 BLOCK 6701, LOT 21.01

Project Description PROPOSED NEW MIXED USE

BUILDING WITH 209 RESIDENTIAL UNITS


Applicant 628 SUMMIT AVE, LLC

Project Title

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As Noted


Scale Sheet Title SITE PLAN

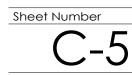


NOTES:

 AREAS BETWEEN EXISTING RETAINING WALLS AND PROPOSED SITE TO BE BACKFILLED TO MEET EXISTING SLOPES OFF-SITE.
 TOP OF PROPOSED RETAINING WALL AROUND PROPOSED OUTDOOR AREA TO BE BACKFILLED TO GRADE.

STORM MH. RIM=99.57 INV(a)=90.77 INV(b)=90.77 INV(c)=96.01 99.90 TC 99.83 BC 99.32 TC 99.98 BC 99.48 100.17 TC 100.10 BC 99.60 INV(a)=90.34 INV(b)=90.2 99.75 EXISTING STORM MANHOLE [M-101 100.25 99.98 DRAIN GRATE: 99.92 GRT 99.34 100.25 PROPOSED STORM MANHOLE M-10 Ш 10 RIM 99.95 99.45 100.00 100.00 C 99.50 S **PROPOSED 29-STORY MIXED-USE** 99.60 DEVELOPMENT **209 DWELLING UNITS** 100.25 99.83 99.66 99.90 100.25 99.73 G 100.08 —BUIĹDINĠ HT = 58' +/-BUILDING HT = 24" OVAL BRICK 56' +/-

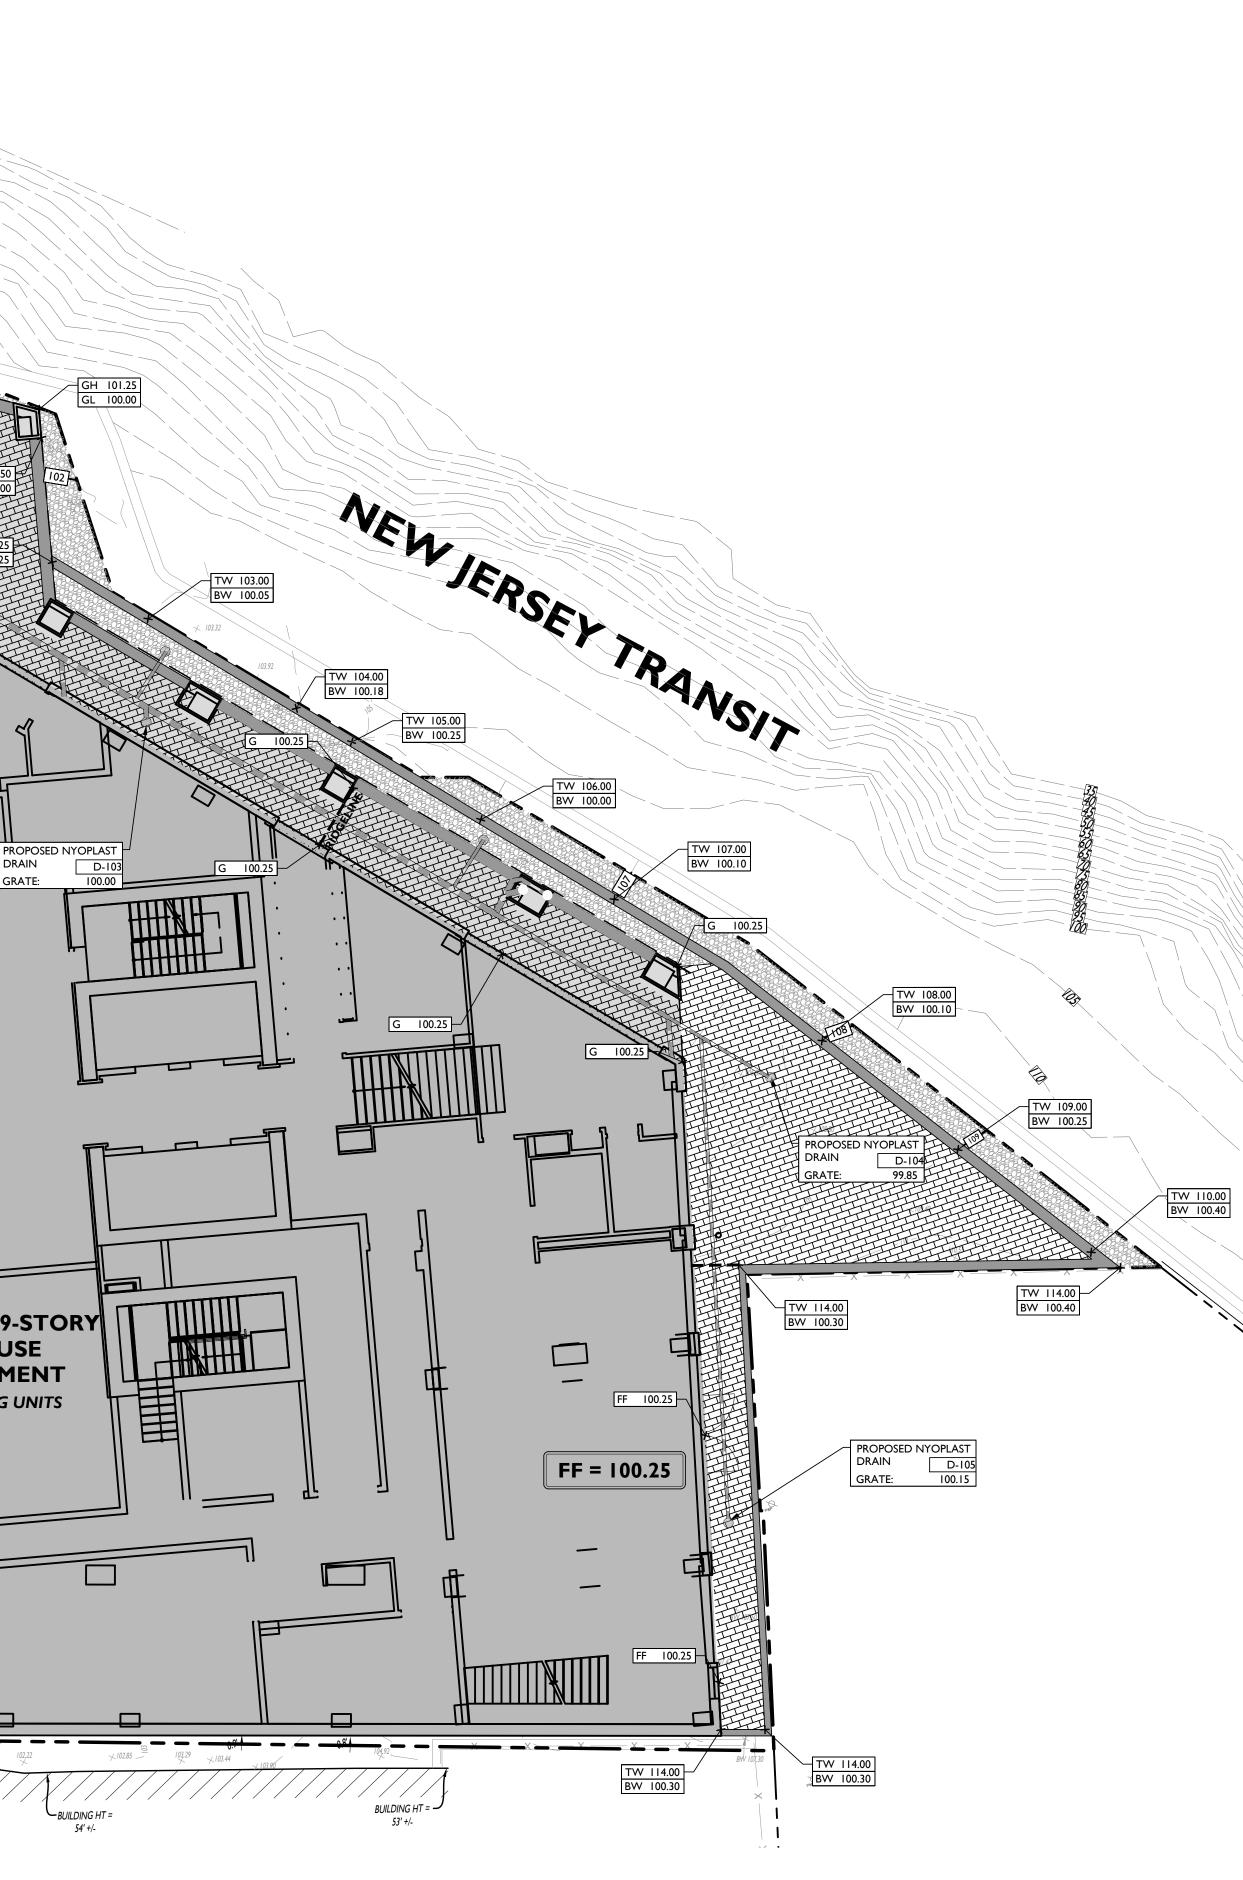

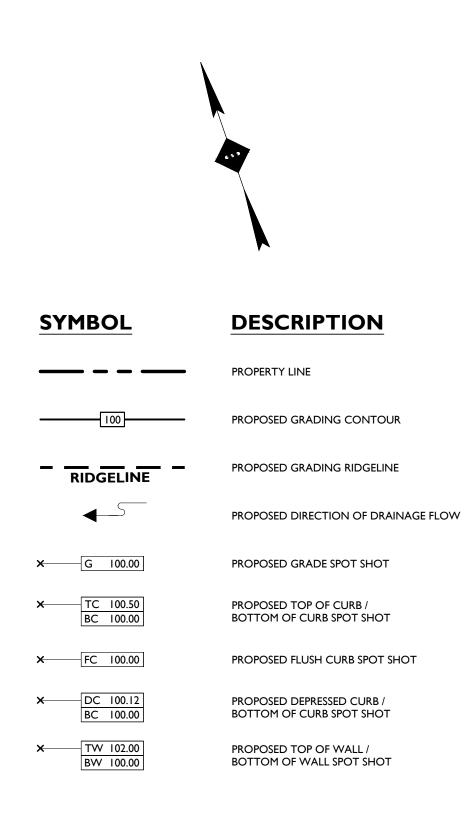


GRADING NOTES

- 1. ALL SOIL AND MATERIAL REMOVED FROM THE SITE SHALL BE DISPOSED OF IN ACCORDANCE WITH LOCAL, STATE, AND FEDERAL REQUIREMENTS. ANY GROUNDWATER DE-WATERING PRACTICES SHALL BE PERFORMED UNDER THE SUPERVISION OF A QUALIFIED PROFESSIONAL. THE CONTRACTOR IS REQUIRED TO OBTAIN ALL NECESSARY PERMITS FOR THE DISCHARGE OF DE-WATERED GROUNDWATER. ALL SOIL IMPORTED TO THE SITE SHALL BE CERTIFIED CLEAN FILL. CONTRACTOR SHALL MAINTAIN RECORDS OF ALL FILL MATERIALS BROUGHT TO THE SITE.
- 2. THE CONTRACTOR IS REQUIRED TO PROVIDE TEMPORARY AND/OR PERMANENT SHORING WHERE REQUIRED DURING EXCAVATION ACTIVITIES, INCLUDING BUT NOT LIMITED TO UTILITY TRENCHES, TO ENSURE THE STRUCTURAL INTEGRITY OF NEARBY STRUCTURES AND STABILITY OF THE SURROUNDING SOILS.
- 3. PROPOSED TOP OF CURB ELEVATIONS ARE GENERALLY 4 INCHES TO 7 INCHES ABOVE EXISTING GRADES UNLESS OTHERWISE NOTED. THE CONTRACTOR WILL SUPPLY ALL STAKEOUT CURB GRADE SHEETS TO STONEFIELD ENGINEERING & DESIGN, LLC. FOR REVIEW AND APPROVAL PRIOR TO POURING CURBS.
- THE CONTRACTOR IS RESPONSIBLE TO SET ALL PROPOSED UTILITY COVERS AND RESET ALL EXISTING UTILITY COVERS WITHIN THE PROJECT LIMITS TO PROPOSED GRADE IN ACCORDANCE WITH ANY APPLICABLE MUNICIPAL, COUNTY, STATE AND/OR UTILITY AUTHORITY REGULATIONS.
 MINIMUM SLOPE REQUIREMENTS TO PREVENT PONDING SHALL BE AS
- FOLLOWS: • CURB GUTTER: 0.50% • CONCRETE SURFACES: 1.00%
- ASPHALT SURFACES: 1.00%
 5. A MINIMUM SLOPE OF 1.00% SHALL BE PROVIDED AWAY FROM ALL BUILDINGS. THE CONTRACTOR SHALL ENSURE POSITIVE DRAINAGE FROM THE BUILDING IS ACHIEVED AND SHALL NOTIFY STONEFIELD ENGINEERING & DESIGN, LLC. IF THIS CONDITION CANNOT BE MET.
- 6. FOR PROJECTS WHERE BASEMENTS ARE PROPOSED, THE DEVELOPER IS RESPONSIBLE TO DETERMINE THE DEPTH TO GROUNDWATER AT THE LOCATION OF THE PROPOSED STRUCTURE. IF GROUNDWATER IS ENCOUNTERED WITHIN THE BASEMENT AREA, SPECIAL CONSTRUCTION METHODS SHALL BE UTILIZED AND REVIEWED/APPROVED BY THE CONSTRUCTION CODE OFFICIAL. IF SUMP PUMPS ARE UTILIZED, ALL DISCHARGES SHALL BE CONNECTED DIRECTLY TO THE PUBLIC STORM SEWER SYSTEM WITH APPROVAL FROM THE GOVERNING STORM SEWER SYSTEM AUTHORITY.

ADA NOTES

- THE CONTRACTOR SHALL MAINTAIN A MAXIMUM 2.00% SLOPE IN ANY DIRECTION WITHIN THE ADA PARKING SPACES AND ACCESS AISLES.
 THE CONTRACTOR SHALL PROVIDE COMPLIANT SIGNAGE AT ALL ADA
- PARKING AREAS IN ACCORDANCE WITH STATE GUIDELINES.
 THE CONTRACTOR SHALL MAINTAIN A MAXIMUM 5.00% RUNNING SLOPE AND A MAXIMUM OF 2.00% CROSS SLOPE ALONG WALKWAYS WITHIN THE ACCESSIBLE PATH OF TRAVEL (SEE THE SITE PLAN FOR THE LOCATION OF THE ACCESSIBLE PATH). THE CONTRACTOR IS RESPONSIBLE TO ENSURE THE ACCESSIBLE PATH OF TRAVEL IS 36 INCHES WIDE OR GREATER UNLESS INDICATED OTHERWISE WITHIN THE PLAN SET.
- 4. THE CONTRACTOR SHALL MAINTAIN A MAXIMUM 2.00% SLOPE IN ANY DIRECTION AT ALL LANDINGS. LANDINGS INCLUDE, BUT ARE NOT LIMITED TO, THE TOP AND BOTTOM OF AN ACCESSIBLE RAMP, AT ACCESSIBLE BUILDING ENTRANCES, AT AN AREA IN FRONT OF A WALK-UP ATM, AND AT TURNING SPACES ALONG THE ACCESSIBLE PATH OF TRAVEL. THE LANDING AREA SHALL HAVE A MINIMUM CLEAR AREA OF 60 INCHES BY 60 INCHES UNLESS INDICATED OTHERWISE WITHIN THE PLAN SET.
- 5. THE CONTRACTOR SHALL MAINTAIN A MAXIMUM 8.33% RUNNING SLOPE AND A MAXIMUM 2.00% CROSS SLOPE ON ANY CURB RAMPS ALONG THE ACCESSIBLE PATH OF TRAVEL. WHERE PROVIDED, CURB RAMP FLARES SHALL NOT HAVE A SLOPE GREATER THAN 10.00% IF A LANDING AREA IS PROVIDED AT THE TOP OF THE RAMP. FOR ALTERATIONS, A CURB RAMP FLARES SHALL NOT HAVE A SLOPE GREATER THAN 8.33% IF A LANDING AREA IS NOT PROVIDED AT THE TOP OF THE RAMP. CURBS RAMPS SHALL NOT RISE MORE THAN 6 INCHES IN ELEVATION WITHOUT A HANDRAIL. THE CLEAR WIDTH OF A CURB RAMP
- SHALL BE NO LESS THAN 36 INCHES WIDE.
 ACCESSIBLE RAMPS WITH A RISE GREATER THAN 6 INCHES SHALL CONTAIN COMPLIANT HANDRAILS ON BOTH SIDES OF THE RAMP AND SHALL NOT RISE MORE THAN 30" IN ELEVATION WITHOUT A LANDING AREA IN BETWEEN RAMP RUNS. LANDING AREAS SHALL ALSO BE PROVIDED AT THE TOP AND BOTTOM OF THE RAMP.
- A SLIP RESISTANT SURFACE SHALL BE CONSTRUCTED ALONG THE ACCESSIBLE PATH AND WITHIN ADA PARKING AREAS.
 THE CONTRACTOR SHALL ENSURE A MAXIMUM OF ¹/₄ INCHES VERTICAL CHANGE IN LEVEL ALONG THE ACCESSIBLE PATH. WHERE A CHANGE IN LEVEL BETWEEN ¹/₄ INCHES AND ¹/₂ INCHES EXISTS, CONTRACTOR SHALL ENSURE
- THAT THE TOP ¹/₄ INCH CHANGE IN LEVEL IS BEVELED WITH A SLOPE NOT STEEPER THAN I UNIT VERTICAL AND 2 UNITS HORIZONTAL (2:I SLOPE).
 9. THE CONTRACTOR SHALL ENSURE THAT ANY OPENINGS (GAPS OR HORIZONTAL SEPARATION) ALONG THE ACCESSIBLE PATH SHALL NOT ALLOW PASSAGE OF A SPHERE GREATER THAN ¹/₂ INCH.

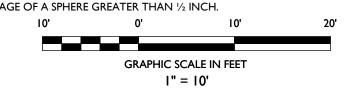

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ARTHUR KUYAN, P.E. NEW JERSEY LICENSE No. 55741 LICENSED PROFESSIONAL ENGINEER

15	01/06/2023	PB RESUBMISSION
14	12/16/2022	JCMUA REVISIONS
13	11/28/2022	FOR BUILDING
15	11/20/2022	PERMIT
12	10/31/2022	PSEG REVISION
11	10/05/2022	PER JCMUA
11	10/03/2022	COMMENTS
10	08/08/2022	PB RESUBMISSION
9	07/20/2022	REVISED DRAINAGI
8	06/20/2022	AMENDED FINAL
0	06/20/2022	SITE PLAN
7	05/12/2022	REVISED GRADING
6	04/22/2022	JCMUA REVISIONS
5	03/25/2022	JCMUA REVISIONS
4	09/03/2021	ISSUED FOR BID
3	07/02/2021	CD 90%
2	06/07/2021	CD 75%
1	04/09/2021	CD 50%
#	Date	Issue

SUMMIT TOWER

622-628 SUMMIT AVE JERSEY CITY, NEW JERSEY 07306 BLOCK 6701, LOT 21.01

Project Description

PROPOSED NEW MIXED USE BUILDING WITH 209 RESIDENTIAL UNITS

Applicant 628 SUMMIT AVE, LLC

Project Title

Project Number: T-18276 Drawn by : KB Checked by : KB


Scale : As Noted
Sheet Title

GRADING PLAN





. AREAS BETWEEN EXISTING RETAINING WALLS AND PROPOSED SITE TO BE BACKFILLED TO MEET EXISTING SLOPES OFF-SITE. 2. TOP OF PROPOSED RETAINING WALL AROUND PROPOSED OUTDOOR AREA TO BE BACKFILLED TO GRADE.

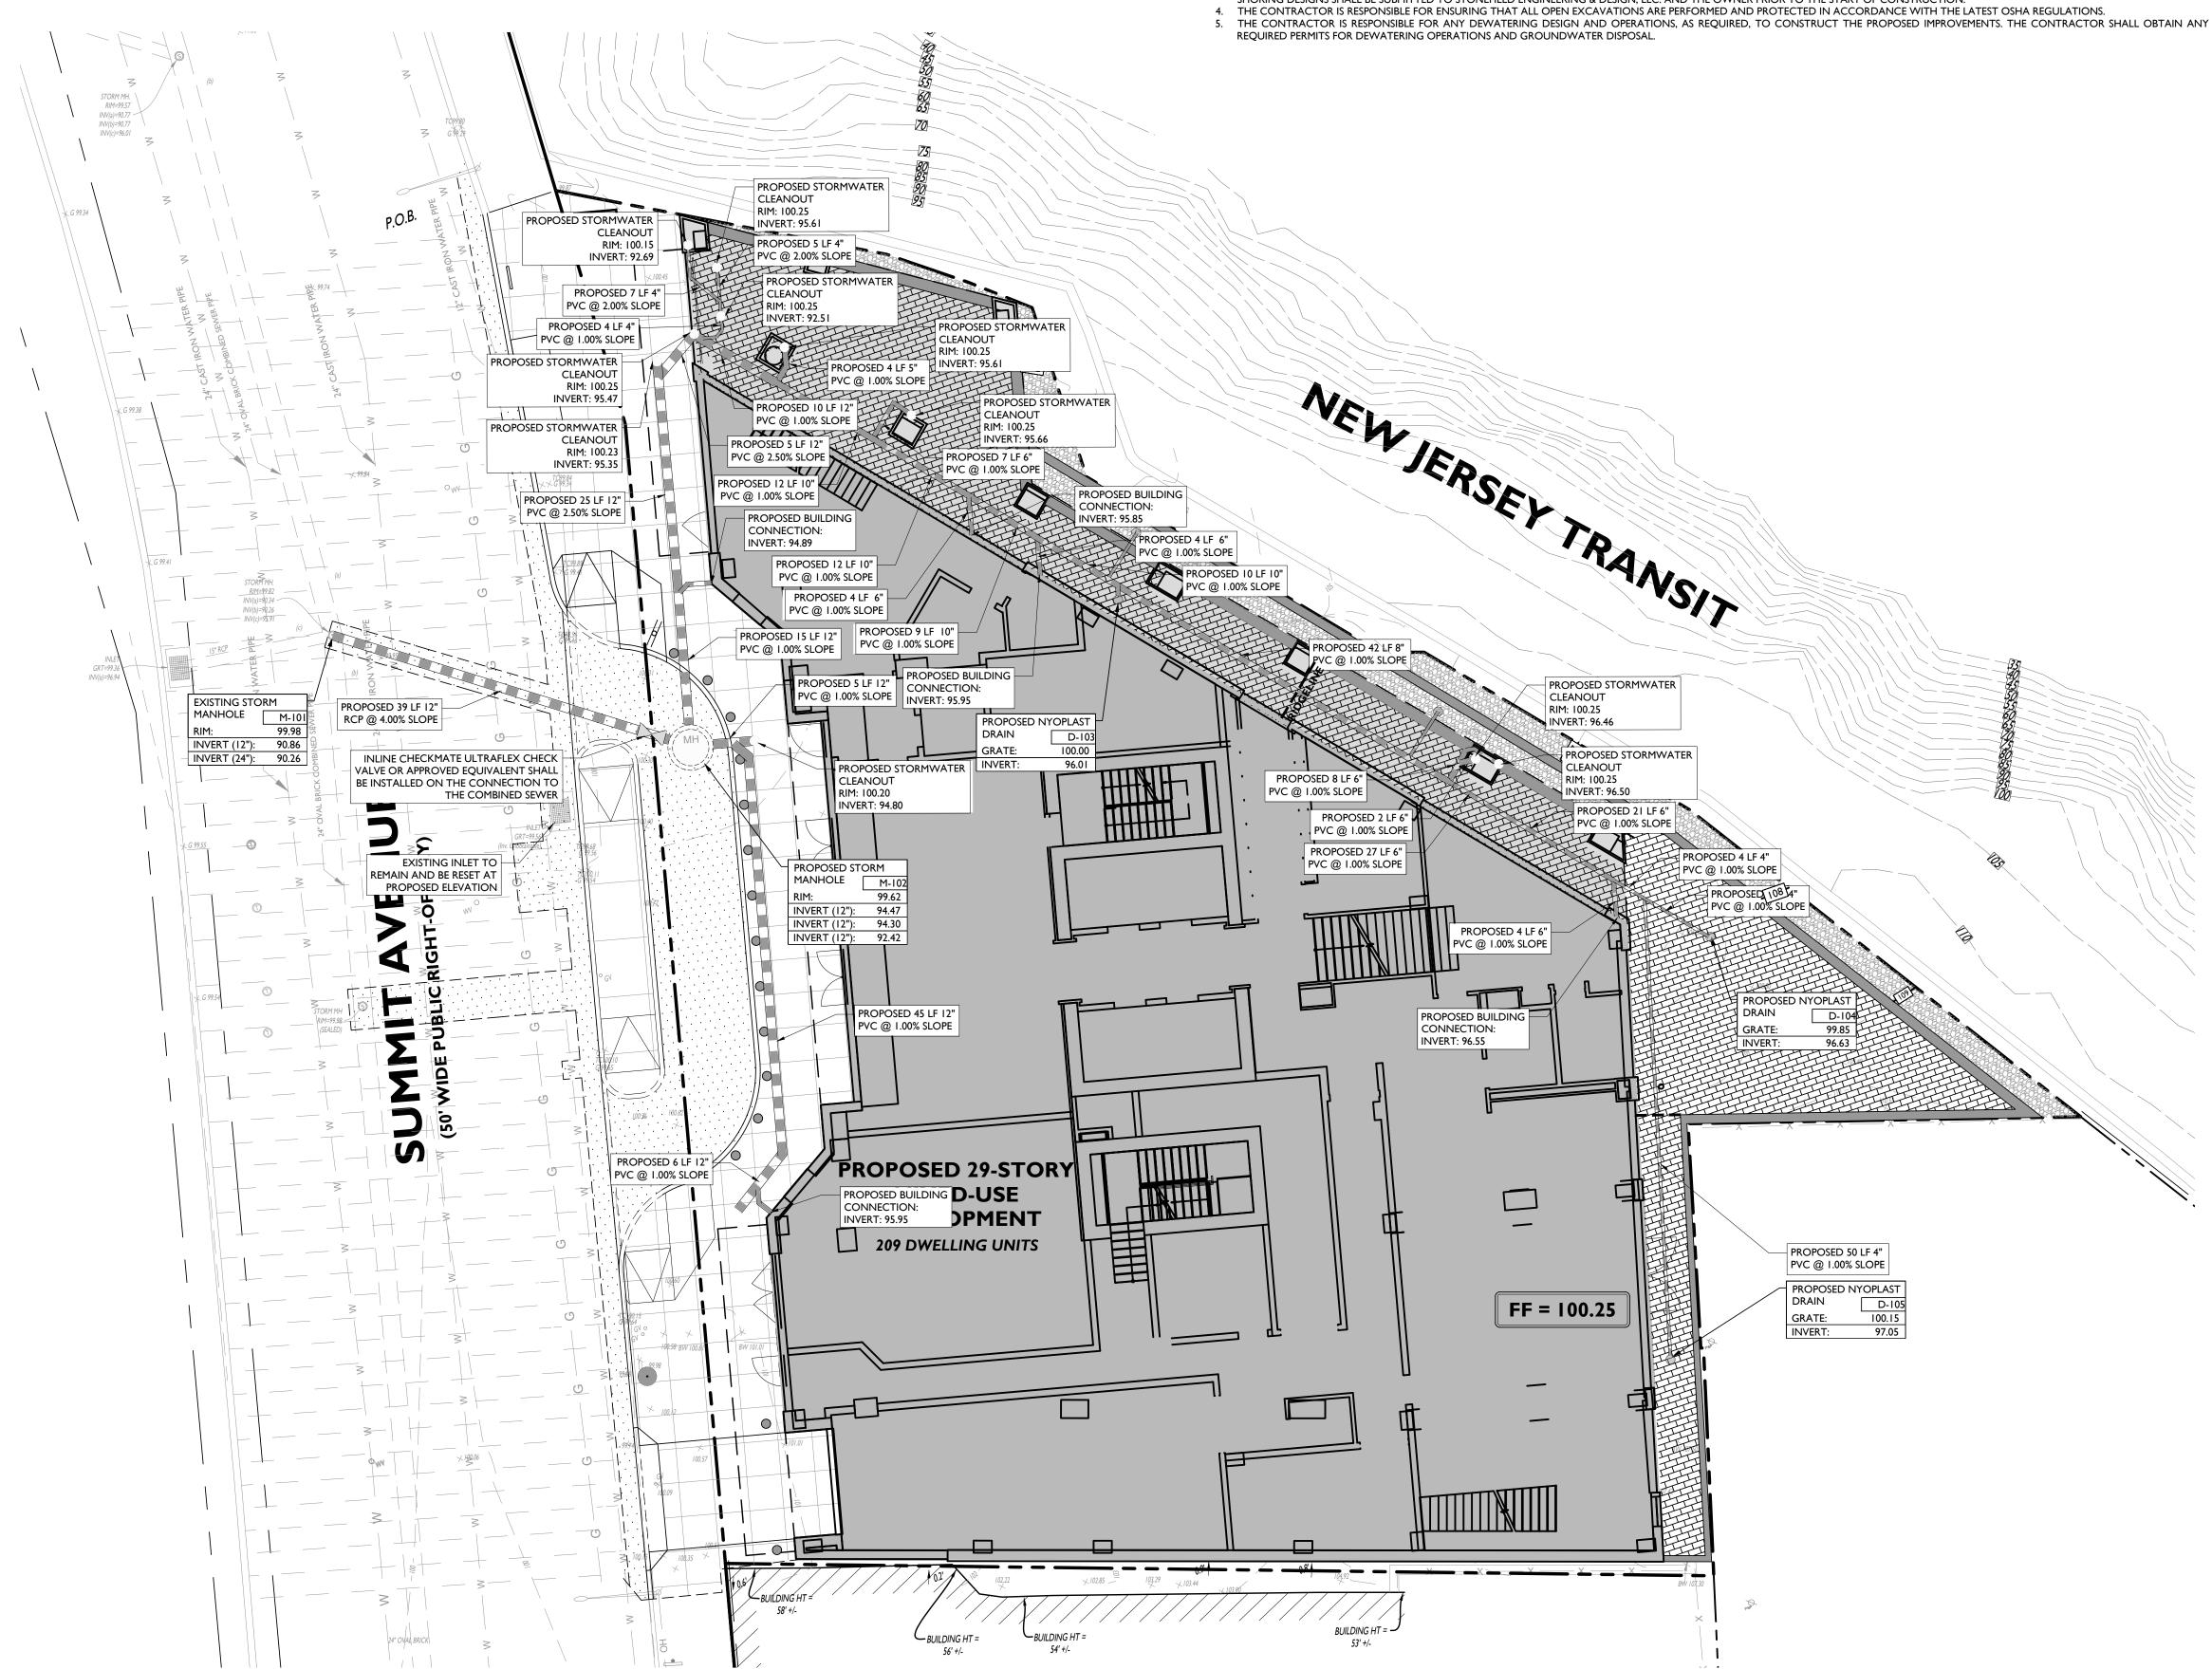


DRAINAGE AND UTILITY NOTES

- I. THE CONTRACTOR TO PERFORM A TEST PIT PRIOR TO CONSTRUCTION (RECOMMEND 30 DAYS PRIOR) AT LOCATIONS OF EXISTING UTILITY CROSSINGS FOR STORMWATER IMPROVEMENTS. SHOULD A CONFLICT EXIST, THE CONTRACTOR SHALL IMMEDIATELY NOTIFY STONEFIELD ENGINEERING & DESIGN, LLC. IN WRITING.
- CONTRACTOR SHALL START CONSTRUCTION OF STORM LINES AT THE LOWEST INVERT AND WORK UP-GRADIENT. THE CONTRACTOR IS REQUIRED TO CALL THE APPROPRIATE AUTHORITY FOR NOTICE OF CONSTRUCTION/EXCAVATION AND UTILITY MARK OUT PRIOR TO THE START OF CONSTRUCTION IN ACCORDANCE WITH STATE LAW. CONTRACTOR IS REQUIRED TO CONFIRM THE HORIZONTAL AND VERTICAL LOCATION OF UTILITIES IN THE FIELD. SHOULD A DISCREPANCY EXIST BETWEEN THE FIELD LOCATION OF A UTILITY AND THE LOCATION SHOWN ON THE PLAN SET OR SURVEY, THE CONTRACTOR SHALL NOTIFY STONEFIELD ENGINEERING & DESIGN, LLC. IMMEDIATELY IN WRITING.
- 4. THE CONTRACTOR IS RESPONSIBLE TO MAINTAIN A RECORD OF THE AS-BUILT LOCATIONS OF ALL PROPOSED UNDERGROUND INFRASTRUCTURE. THE CONTRACTOR SHALL NOTE ANY DISCREPANCIES BETWEEN THE AS-BUILT LOCATIONS AND THE LOCATIONS DEPICTED WITHIN THE PLAN SET. THIS RECORD SHALL BE PROVIDED TO THE OWNER FOLLOWING COMPLETION OF

EXCAVATION, SOIL PREPARATION, AND DEWATERING NOTES

- THE CONTRACTOR IS REQUIRED TO REVIEW THE REFERENCED GEOTECHNICAL DOCUMENTS PRIOR TO CONSTRUCTION, THESE DOCUMENTS SHALL BE CONSIDERED A PART OF THE PLAN SET. THE CONTRACTOR IS REQUIRED TO PREPARE SUBGRADE SOILS BENEATH ALL PROPOSED IMPROVEMENTS AND BACKFILL ALL EXCAVATIONS IN ACCORDANCE WITH RECOMMENDATIONS BY THE GEOTECHNICAL ENGINEER OF RECORD.
- THE CONTRACTOR IS RESPONSIBLE FOR PROVIDING SHORING FOR ALL EXCAVATIONS AS REQUIRED. CONTRACTOR SHALL HAVE THE SHORING DESIGN PREPARED BY A QUALIFIED PROFESSIONAL.
- SHORING DESIGNS SHALL BE SUBMITTED TO STONEFIELD ENGINEERING & DESIGN, LLC. AND THE OWNER PRIOR TO THE START OF CONSTRUCTION.

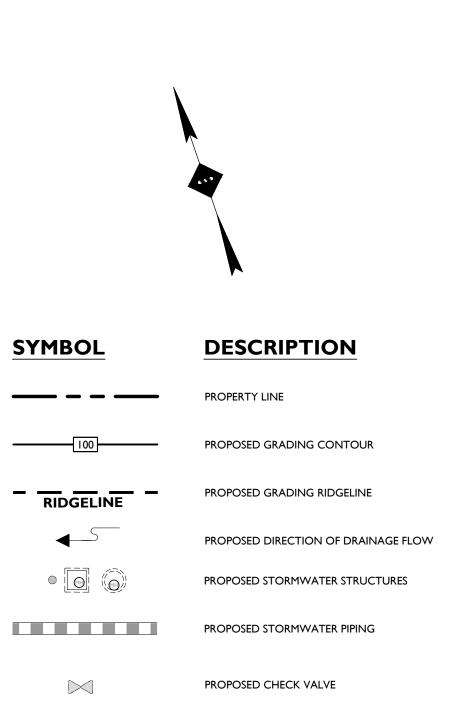


PROPOSED STORMWATER CLEANOUT

GRADING NOTES

- ALL SOIL AND MATERIAL REMOVED FROM THE SITE SHALL BE DISPOSED OF IN ACCORDANCE WITH LOCAL, STATE, AND FEDERAL REQUIREMENTS. ANY GROUNDWATER DE-WATERING PRACTICES SHALL BE PERFORMED UNDER THE SUPERVISION OF A QUALIFIED PROFESSIONAL. THE CONTRACTOR IS REQUIRED TO OBTAIN ALL NECESSARY PERMITS FOR THE DISCHARGE OF DE-WATERED GROUNDWATER. ALL SOIL IMPORTED TO THE SITE SHALL BE CERTIFIED CLEAN FILL. CONTRACTOR SHALL MAINTAIN RECORDS OF ALL FILL MATERIALS BROUGHT TO THE SITE.
- 2. THE CONTRACTOR IS REQUIRED TO PROVIDE TEMPORARY AND/OR PERMANENT SHORING WHERE REQUIRED DURING EXCAVATION ACTIVITIES, INCLUDING BUT NOT LIMITED TO UTILITY TRENCHES, TO ENSURE THE STRUCTURAL INTEGRITY OF NEARBY STRUCTURES AND STABILITY OF THE SURROUNDING SOILS.
- PROPOSED TOP OF CURB ELEVATIONS ARE GENERALLY 4 INCHES TO 7 INCHES ABOVE EXISTING GRADES UNLESS OTHERWISE NOTED. THE CONTRACTOR WILL SUPPLY ALL STAKEOUT CURB GRADE SHEETS TO STONEFIELD ENGINEERING & DESIGN, LLC. FOR REVIEW AND APPROVAL PRIOR TO POURING CURBS
- 4. THE CONTRACTOR IS RESPONSIBLE TO SET ALL PROPOSED UTILITY COVERS AND RESET ALL EXISTING UTILITY COVERS WITHIN THE PROJECT LIMITS TO PROPOSED GRADE IN ACCORDANCE WITH ANY APPLICABLE MUNICIPAL, COUNTY, STATE AND/OR UTILITY AUTHORITY REGULATIONS. MINIMUM SLOPE REQUIREMENTS TO PREVENT PONDING SHALL BE AS FOLLOWS:
- CURB GUTTER: 0.50% CONCRETE SURFACES: 1.00%
- ASPHALT SURFACES: 1 00%
- 5. A MINIMUM SLOPE OF 1.00% SHALL BE PROVIDED AWAY FROM ALL BUILDINGS. THE CONTRACTOR SHALL ENSURE POSITIVE DRAINAGE FROM THE BUILDING IS ACHIEVED AND SHALL NOTIFY STONEFIELD ENGINEERING & DESIGN, LLC. IF THIS CONDITION CANNOT BE MET.
- 6. FOR PROJECTS WHERE BASEMENTS ARE PROPOSED, THE DEVELOPER IS RESPONSIBLE TO DETERMINE THE DEPTH TO GROUNDWATER AT THE LOCATION OF THE PROPOSED STRUCTURE. IF GROUNDWATER IS ENCOUNTERED WITHIN THE BASEMENT AREA, SPECIAL CONSTRUCTION METHODS SHALL BE UTILIZED AND REVIEWED/APPROVED BY THE CONSTRUCTION CODE OFFICIAL. IF SUMP PUMPS ARE UTILIZED, ALL DISCHARGES SHALL BE CONNECTED DIRECTLY TO THE PUBLIC STORM SEWER SYSTEM WITH APPROVAL FROM THE GOVERNING STORM SEWER SYSTEM AUTHORITY.

ADA NOTES

- . THE CONTRACTOR SHALL MAINTAIN A MAXIMUM 2.00% SLOPE IN ANY DIRECTION WITHIN THE ADA PARKING SPACES AND ACCESS AISLES. 2. THE CONTRACTOR SHALL PROVIDE COMPLIANT SIGNAGE AT ALL ADA
- PARKING AREAS IN ACCORDANCE WITH STATE GUIDELINES. 3. THE CONTRACTOR SHALL MAINTAIN A MAXIMUM 5.00% RUNNING SLOPE AND A MAXIMUM OF 2.00% CROSS SLOPE ALONG WALKWAYS WITHIN THE ACCESSIBLE PATH OF TRAVEL (SEE THE SITE PLAN FOR THE LOCATION OF THE ACCESSIBLE PATH). THE CONTRACTOR IS RESPONSIBLE TO ENSURE THE ACCESSIBLE PATH OF TRAVEL IS 36 INCHES WIDE OR GREATER UNLESS INDICATED OTHERWISE WITHIN THE PLAN SET.
- 4. THE CONTRACTOR SHALL MAINTAIN A MAXIMUM 2.00% SLOPE IN ANY DIRECTION AT ALL LANDINGS. LANDINGS INCLUDE, BUT ARE NOT LIMITED TO, THE TOP AND BOTTOM OF AN ACCESSIBLE RAMP, AT ACCESSIBLE BUILDING ENTRANCES, AT AN AREA IN FRONT OF A WALK-UP ATM, AND AT TURNING SPACES ALONG THE ACCESSIBLE PATH OF TRAVEL. THE LANDING AREA SHALL HAVE A MINIMUM CLEAR AREA OF 60 INCHES BY 60 INCHES UNLESS INDICATED OTHERWISE WITHIN THE PLAN SET.
- 5. THE CONTRACTOR SHALL MAINTAIN A MAXIMUM 8.33% RUNNING SLOPE AND A MAXIMUM 2.00% CROSS SLOPE ON ANY CURB RAMPS ALONG THE ACCESSIBLE PATH OF TRAVEL. WHERE PROVIDED, CURB RAMP FLARES SHALL NOT HAVE A SLOPE GREATER THAN 10.00% IF A LANDING AREA IS PROVIDED AT THE TOP OF THE RAMP. FOR ALTERATIONS, A CURB RAMP FLARES SHALL NOT HAVE A SLOPE GREATER THAN 8.33% IF A LANDING AREA IS NOT PROVIDED AT THE TOP OF THE RAMP. CURBS RAMPS SHALL NOT RISE MORE THAN 6 INCHES IN ELEVATION WITHOUT A HANDRAIL. THE CLEAR WIDTH OF A CURB RAMP SHALL BE NO LESS THAN 36 INCHES WIDE.
- 6. ACCESSIBLE RAMPS WITH A RISE GREATER THAN 6 INCHES SHALL CONTAIN COMPLIANT HANDRAILS ON BOTH SIDES OF THE RAMP AND SHALL NOT RISE MORE THAN 30" IN ELEVATION WITHOUT A LANDING AREA IN BETWEEN RAMP RUNS. LANDING AREAS SHALL ALSO BE PROVIDED AT THE TOP AND BOTTOM OF THE RAMP.
- 7. A SLIP RESISTANT SURFACE SHALL BE CONSTRUCTED ALONG THE ACCESSIBLE PATH AND WITHIN ADA PARKING AREAS. 8. THE CONTRACTOR SHALL ENSURE A MAXIMUM OF 1/4 INCHES VERTICAL
- CHANGE IN LEVEL ALONG THE ACCESSIBLE PATH. WHERE A CHANGE IN LEVEL BETWEEN 1/4 INCHES AND 1/2 INCHES EXISTS, CONTRACTOR SHALL ENSURE THAT THE TOP 1/4 INCH CHANGE IN LEVEL IS BEVELED WITH A SLOPE NOT STEEPER THAN I UNIT VERTICAL AND 2 UNITS HORIZONTAL (2:1 SLOPE). 9. THE CONTRACTOR SHALL ENSURE THAT ANY OPENINGS (GAPS OR
- HORIZONTAL SEPARATION) ALONG THE ACCESSIBLE PATH SHALL NOT ALLOW PASSAGE OF A SPHERE GREATER THAN 1/2 INCH.

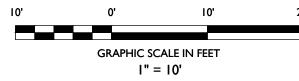

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SEAL

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ARTHUR KUYAN, P.E. NEW JERSEY LICENSE No. 55741 LICENSED PROFESSIONAL ENGINEER

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04/22/2022	JCMUA REVISIONS
03/25/2022	JCMUA REVISIONS
09/03/2021	ISSUED FOR BID
07/02/2021	CD 90%
06/07/2021	CD 75%
04/09/2021	CD 50%
Date	Issue
	07/20/2022 06/20/2022 05/12/2022 04/22/2022 03/25/2022 09/03/2021 07/02/2021 06/07/2021 04/09/2021

SUMMIT TOWER

622-628 SUMMIT AVE JERSEY CITY, NEW JERSEY 07306 BLOCK 6701, LOT 21.01

Project Description

PROPOSED NEW MIXED USE BUILDING WITH 209 RESIDENTIAL UNITS

Applicant 628 SUMMIT AVE, LLC


Project Number: T-18276 Drawn by KB Checked by : KB : As Noted

Scale Sheet Title DRAINAGE PLAN

Sheet Number **_**__ **DRAINAGE AND UTILITY NOTES**

- I. THE CONTRACTOR IS REQUIRED TO CALL THE APPROPRIATE AUTHORITY FOR NOTICE OF CONSTRUCTION/EXCAVATION AND UTILITY MARK OUT PRIOR TO THE START OF CONSTRUCTION IN ACCORDANCE WITH STATE LAW CONTRACTOR IS REQUIRED TO CONFIRM THE HORIZONTAL AND VERTICAL LOCATION OF UTILITIES IN THE FIELD. SHOULD A DISCREPANCY EXIST BETWEEN THE FIELD LOCATION OF A UTILITY AND THE LOCATION SHOWN ON THE PLAN SET OR SURVEY, THE CONTRACTOR SHALL NOTIFY STONEFIELD ENGINEERING & DESIGN, LLC. IMMEDIATELY IN WRITING.
- 2. THE CONTRACTOR IS RESPONSIBLE TO PROTECT AND MAINTAIN IN OPERATION ALL UTILITIES NOT DESIGNATED TO BE REMOVED. 3. THE CONTRACTOR IS RESPONSIBLE FOR REPAIRING ANY DAMAGE TO ANY EXISTING UTILITY IDENTIFIED TO
- REMAIN WITHIN THE LIMITS OF THE PROPOSED WORK DURING CONSTRUCTION. 4. A MINIMUM HORIZONTAL SEPARATION OF 10 FEET IS REQUIRED BETWEEN ANY SANITARY SEWER SERVICE AND ANY WATER LINES. IF THIS SEPARATION CANNOT BE PROVIDED. A CONCRETE ENCASEMENT SHALL BE UTILIZED FOR THE SANITARY SEWER SERVICE AS APPROVED BY STONEFIELD ENGINEERING & DESIGN. LLC.
- 5. ALL WATER LINES SHALL BE VERTICALLY SEPARATED ABOVE SANITARY SEWER LINES BY A MINIMUM DISTANCE OF 18 INCHES. IF THIS SEPARATION CANNOT BE PROVIDED, A CONCRETE ENCASEMENT SHALL BE UTILIZED FOR THE SANITARY SEWER SERVICE AS APPROVED BY STONEFIELD ENGINEERING & DESIGN, LLC.
- 6. THE CONTRACTOR TO PERFORM A TEST PIT PRIOR TO CONSTRUCTION (RECOMMEND 30 DAYS PRIOR) AT LOCATIONS OF EXISTING UTILITY CROSSINGS FOR WATER AND SANITARY SEWER CONNECTION IMPROVEMENTS. SHOULD A CONFLICT EXIST, THE CONTRACTOR SHALL IMMEDIATELY NOTIFY STONEFIELD
- ENGINEERING & DESIGN, LLC. IN WRITING. 7. THE CONTRACTOR IS RESPONSIBLE FOR COORDINATING GAS, ELECTRIC AND TELECOMMUNICATION CONNECTIONS WITH THE APPROPRIATE GOVERNING AUTHORITY.
- 8. CONTRACTOR SHALL START CONSTRUCTION OF ANY GRAVITY SEWER AT THE LOWEST INVERT AND WORK **UP-GRADIENT** 7. THE CONTRACTOR IS RESPONSIBLE TO MAINTAIN A RECORD SET OF PLANS REFLECTING THE LOCATION OF EXISTING UTILITIES THAT HAVE BEEN CAPPED, ABANDONED, OR RELOCATED BASED ON THE
- DEMOLITION/REMOVAL ACTIVITIES REQUIRED IN THIS PLAN SET. THIS DOCUMENT SHALL BE PROVIDED TO THE OWNER FOLLOWING COMPLETION OF WORK. 8. THE CONTRACTOR IS RESPONSIBLE TO MAINTAIN A RECORD OF THE AS-BUILT LOCATIONS OF ALL PROPOSED UNDERGROUND INFRASTRUCTURE. THE CONTRACTOR SHALL NOTE ANY DISCREPANCIES
- BETWEEN THE AS-BUILT LOCATIONS AND THE LOCATIONS DEPICTED WITHIN THE PLAN SET. THIS RECORD SHALL BE PROVIDED TO THE OWNER FOLLOWING COMPLETION OF WORK.

- JCMUA NOTES
- REQUIREMENTS OF THE NIDOT'S STANDARD SPECIFICATION FOR ROAD AND BRIDGE CONSTRUCTION, AND THE DESIGN AND CONSTRUCTION OF
- URBAN STORMWATER MANAGEMENT SYSTEMS, ASCE MANUALS AND REPORTS OF ENGINEERING PRACTICE NO. 77, 1993, AS APPLICABLE. MADE DIRECTLY TO THE SEWER MAIN AND ALL CONNECTIONS 8-INCHES IN SIZE OR LARGER MUST BE MADE TO A MANHOLE. WHERE A CONNECTION
- TO A MANHOLE IS REQUIRED, MANHOLE BENCH AND CHANNEL MAY **REOUIRE MODIFICATION** THE JCMUA REQUIRES THAT SEWER SERVICE CONNECTIONS TO BE RE-USED BE TELEVISED TO VERIFY THEIR INTEGRITY AND THAT THE PIPE IS FREE FROM
- ANY DEFECTS 4. EACH BUILDING CONNECTION REQUIRES A CURB CLEANOUT (REFER TO ATTACHED DETAIL DRAWINGS). T-WYE CLEANOUTS WHICH ENABLE STORM AND SANITARY LATERAL
- PROPOSED SEWER LATERAL CONNECTION TO JCMUA'S SEWER MAIN SHALL SEWER SERVICE CONNECTION DETAILS)
- 6. THE SIZE, MATERIAL, DEPTH, CONDITION, DIRECTION OF FLOW AND ANY OTHER RELEVANT CONDITIONS OF THE EXISTING ICMUA SEWER TO WHICH YOU PLAN TO CONNECT MUST BE FIELD VERIFIED BY DEVELOPER TO IN ADDITION, MANHOLE INVERTS AND RIM ELEVATION MUST BE SHOWN ON PLANS. THIS VERIFICATION IS TO BE INCLUDED ON THE PLANS FOR THE PROIFCT
- CIRCULAR HOLE SAWS WHICH ARE APPROXIMATELY SIZED OR HAND DRILLS MUST BE USED TO MAKE THE OPENINGS IN THE EXISTING SEWER TO RECEIVE THE LATERALS, IACKHAMMERS, SLEDGEHAMMERS AND OTHER UNSUITABLE TOOLS OR MACHINERY WHICH MAY DAMAGE THE ICMUA'S SEWER MAIN ARE NOT ALLOWED TO BE USED TO MAKE THE LATERAL OPENINGS, ALL DEBRIS MUST BE REMOVED AND NOT ALLOWED TO FALL INTO PIPE.

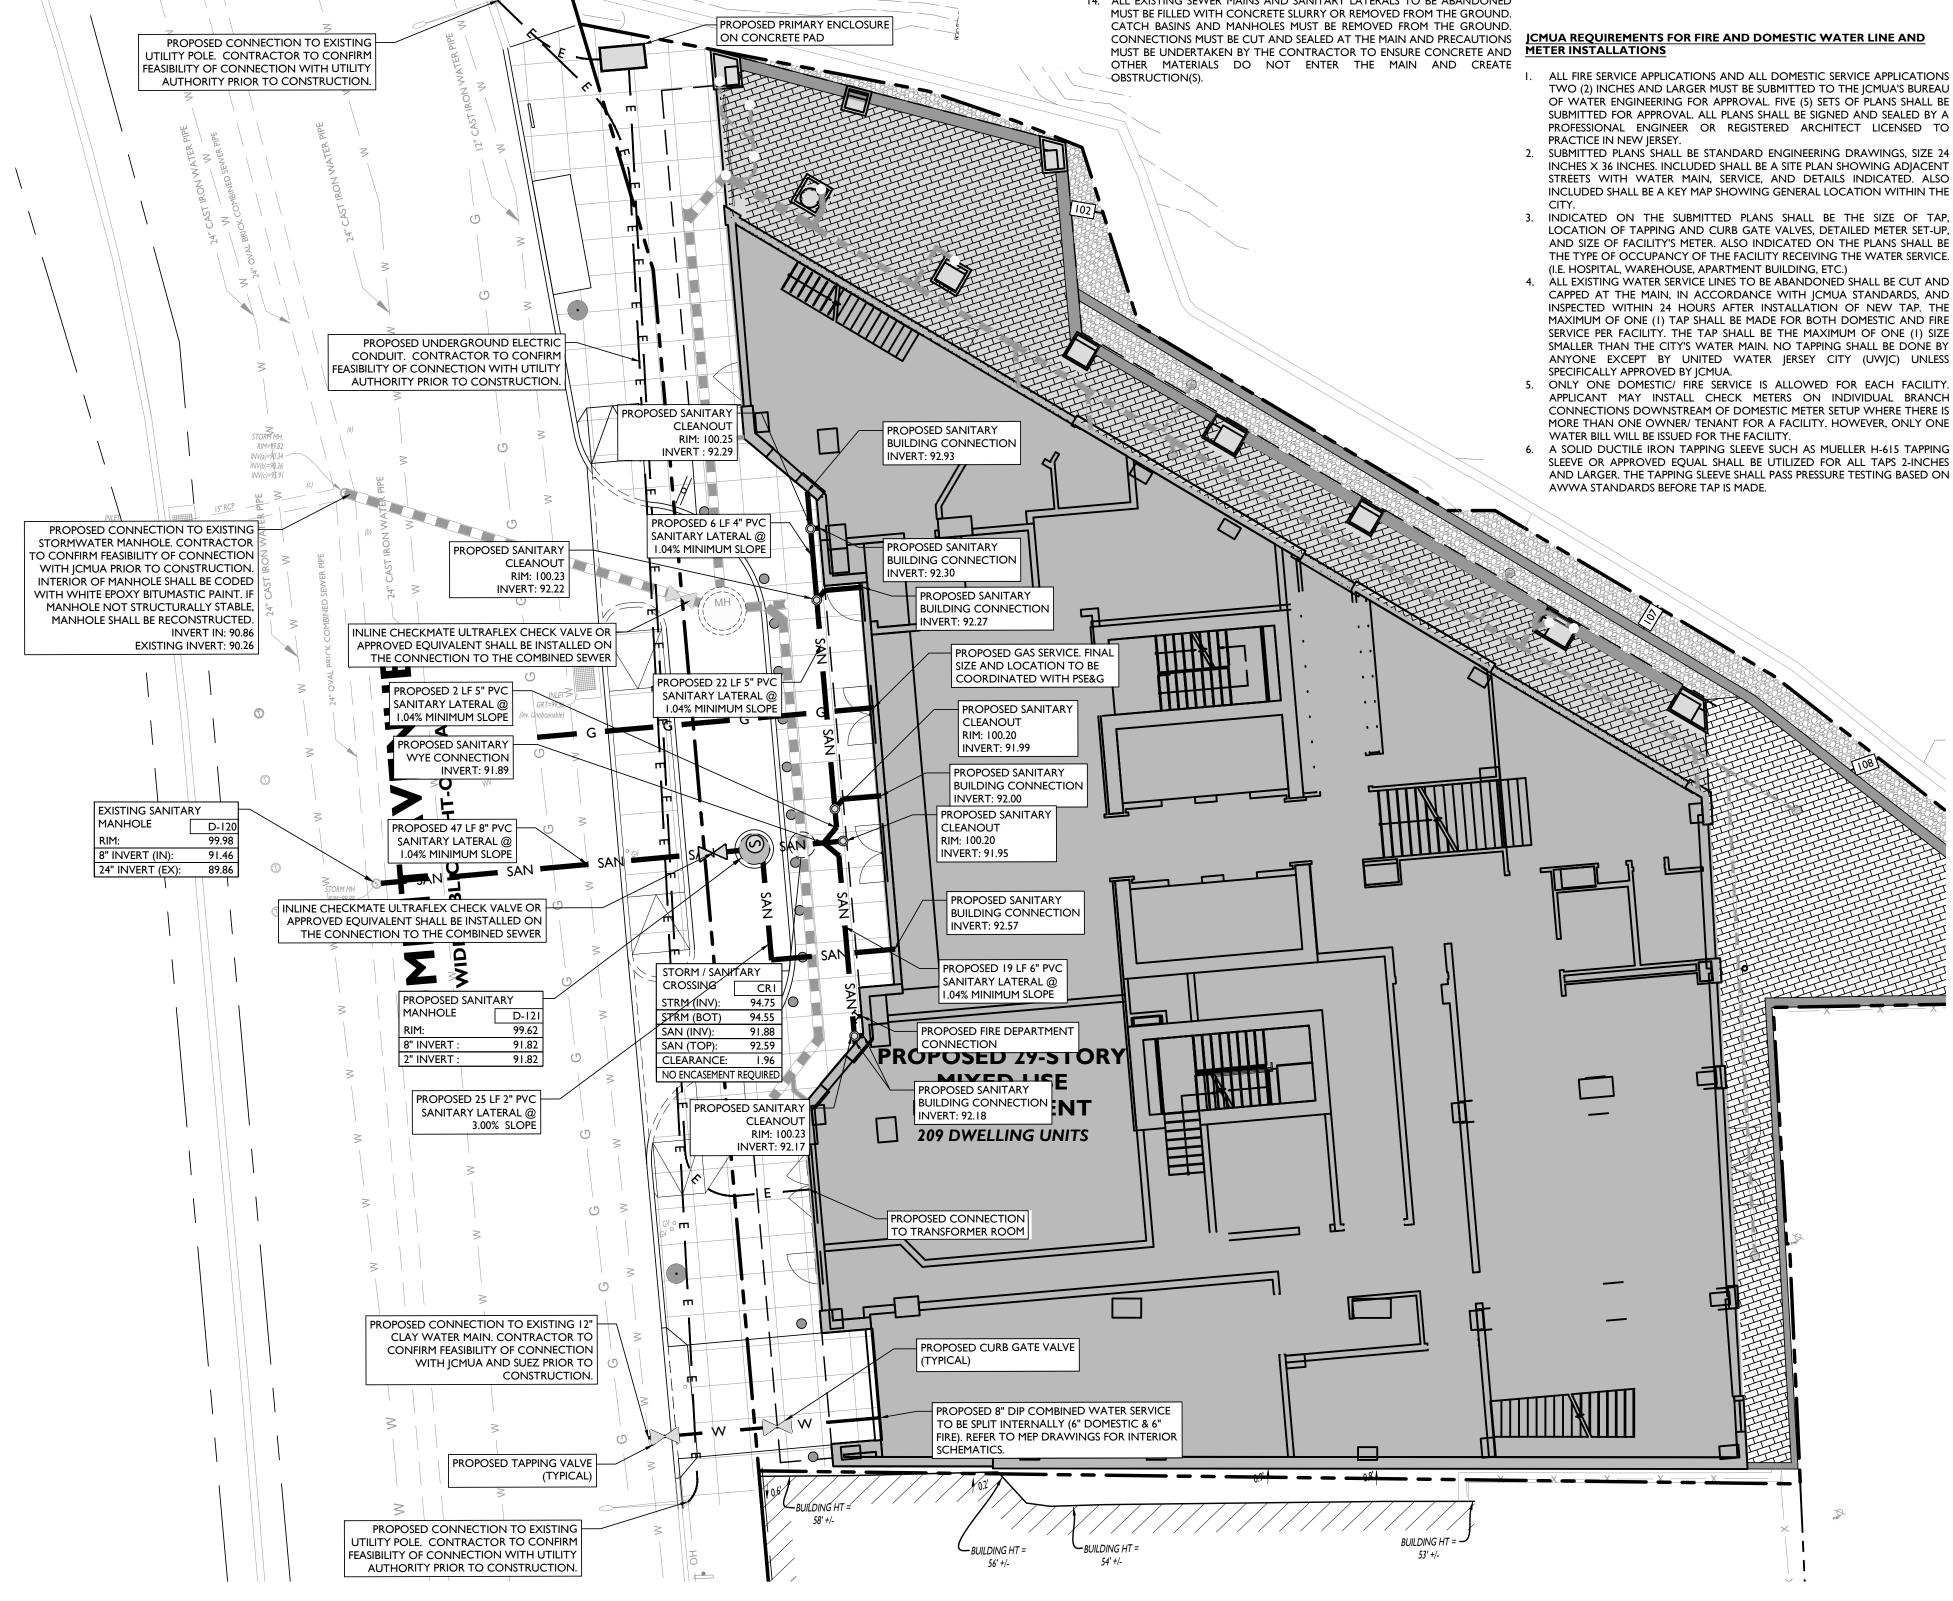

- I. BEDDING AND BACKFILL MATERIAL SHALL COMPLY WITH THE 8. A DETAIL OF ANY PROPOSED MANHOLE OR CATCH BASIN SHOWING ALL 15. ALL PROPOSED INLETS/CATCH BASINS MUST BE CONSTRUCTED WITH A DIMENSIONS IN ADDITION TO RIM, GRATE AND INVERT ELEVATIONS OF THE STRUCTURE AND ALL PIPES CONNECTED TO THE STRUCTURE MUST BE SHOWN ON PLANS. REFER TO JCMUA STANDARD DETAIL DRAWINGS FOR 16. PROPOSED WATER SERVICES REQUIRE THE REVIEW AND APPROVAL OF THE MANHOLES AND CATCH BASINS.
- 2. ALL SEWER SERVICE CONNECTIONS 6-INCHES IN SIZE OR SMALLER MUST BE 9. PROPOSED MANHOLES CONSTRUCTED IN THE PUBLIC R.O.W. ON EXISTING 17. THE CONTRACTOR IS RESPONSIBLE FOR OBTAINING PERMITS FOR STREET OR PROPOSED JCMUA SEWERS SHALL BE FURNISHED WITH CONCENTRIC MANHOLE COVERS AS MANUFACTURED BY CAMPBELL FOUNDRY CO., PATTERN #4428 OR EOUAL WITH OUTSIDE COVER DIAMETER OF 31-3/4 INCHES AND INSIDE COVER DIAMETER OF 24 INCHES. THE LETTERS "JCMUA" AND "SEWER" SHALL BE CAST IN THE INSIDE COVER. MANHOLE FRAMES SHALL BE CAMPBELL FOUNDRY CO. PATTERN #4428 (FOR 30-INCH OPENING) OR #1206 (FOR 41-INCH OPENING) OR EOUAL FURNISHED WITH A PATTERN #4428 CONCENTRIC COVER AS SPECIFIED IN THE PRECEDING PARAGRAPH. REFER TO JCMUA'S STANDARD DETAIL FOR MANHOLE FRAME AND COVERS. CLEANING IN BOTH DIRECTIONS SHOULD BE INSTALLED ON BOTH THE 10. STORM INLETS WHICH ARE CONNECTED DIRECTLY TO JCMUA COMBINED SEWERS MUST BE FURNISHED WITH A SUMP AND TRAP AS PER JCMUA
- STANDARD DETAILS BE MADE ABOVE HORIZONTAL CENTER LINE OF PIPE (REFER TO ATTACHED 11. THE JCMUA HAS A COMBINED SEWER SYSTEM WHICH SURCHARGES DURING WET WEATHER PERIODS RESULTING IN POSSIBLE SEWAGE BACK-UPS THROUGH PLUMBING FIXTURES (SINKS, TOILETS, FLOOR DRAINS, ETC.) BELOW STREET LEVEL. THIS POSSIBILITY MUST BE ADDRESSED DURING THE DESIGN/CONSTRUCTION PHASE.
- DETERMINE IF SAID CONNECTION IS PHYSICALLY POSSIBLE AND PRACTICAL. 12. A DROP MANHOLE CONNECTION SHALL BE USED WHERE THERE IS A DIFFERENCE IN ELEVATION OF TWO (2) FEET OR GREATER BETWEEN THE INVERT OF A SANITARY OR COMBINED INLET PIPE TO MANHOLE AND THE CROWN OF THE OUTLET PIPE FROM MANHOLE. REFER TO ATTACHED JCMUA'S STANDARD DETAIL FOR DROP MANHOLE CONNECTION WHICH MUST BE SHOWN ON SITE PLAN IF REOUIRED 13. TEST PITS MUST BE PERFORMED AT THE DEVELOPER'S EXPENSE DURING THE
 - DESIGN PHASE OF THE PROJECT TO ENSURE THAT PROPOSED SEWERS AND SEWER SERVICES MAY BE CONSTRUCTED AS PROPOSED WITHOUT CONFLICTING WITH OTHER UNDERGROUND UTILITIES OR STRUCTURES. 14. ALL EXISTING SEWER MAINS AND SANITARY LATERALS TO BE ABANDONED

- BICYCLE SAFE GRATE AND CAMPBELL FOUNDRY CO. TYPE 'N' CURBPIECE WHERE REOUIRED
- DIVISION OF WATER ENGINEERING. OPENINGS FROM THE JERSEY CITY BUILDING DEPARTMENT LOCATED AT 30 MONTGOMERY STREET, JERSEY CITY, NJ AND ALL OTHER APPLICABLE PERMITS FROM AGENCIES HAVING JURISDICTION.

NOTE: ICMUA SHALL BE NOTIFIED TWO DAYS IN ADVANCE PRIOR TO MAKING ANY SANITARY AND STORM LATERAL CONNECTIONS.

NOTE: ALL CONSTRUCTION TO BE PERFORMED IN ACCORDANCE WITH THE ICMUA STANDARDS AND SPECIFICATIONS

- TWO (2) INCHES AND LARGER MUST BE SUBMITTED TO THE JCMUA'S BUREAU OF WATER ENGINEERING FOR APPROVAL. FIVE (5) SETS OF PLANS SHALL BE SUBMITTED FOR APPROVAL. ALL PLANS SHALL BE SIGNED AND SEALED BY A PROFESSIONAL ENGINEER OR REGISTERED ARCHITECT LICENSED TO
- INCHES X 36 INCHES. INCLUDED SHALL BE A SITE PLAN SHOWING ADIACENT STREETS WITH WATER MAIN, SERVICE, AND DETAILS INDICATED. ALSO INCLUDED SHALL BE A KEY MAP SHOWING GENERAL LOCATION WITHIN THE
- LOCATION OF TAPPING AND CURB GATE VALVES. DETAILED METER SET-UP. AND SIZE OF FACILITY'S METER. ALSO INDICATED ON THE PLANS SHALL BE THE TYPE OF OCCUPANCY OF THE FACILITY RECEIVING THE WATER SERVICE.
- CAPPED AT THE MAIN, IN ACCORDANCE WITH ICMUA STANDARDS, AND INSPECTED WITHIN 24 HOURS AFTER INSTALLATION OF NEW TAP. THE MAXIMUM OF ONE (1) TAP SHALL BE MADE FOR BOTH DOMESTIC AND FIRE SERVICE PER FACILITY. THE TAP SHALL BE THE MAXIMUM OF ONE (1) SIZE SMALLER THAN THE CITY'S WATER MAIN. NO TAPPING SHALL BE DONE BY ANYONE EXCEPT BY UNITED WATER JERSEY CITY (UWJC) UNLESS
- APPLICANT MAY INSTALL CHECK METERS ON INDIVIDUAL BRANCH CONNECTIONS DOWNSTREAM OF DOMESTIC METER SETUP WHERE THERE IS MORE THAN ONE OWNER/ TENANT FOR A FACILITY. HOWEVER, ONLY ONE 6. A SOLID DUCTILE IRON TAPPING SLEEVE SUCH AS MUELLER H-615 TAPPING
- SLEEVE OR APPROVED EOUAL SHALL BE UTILIZED FOR ALL TAPS 2-INCHES AND LARGER. THE TAPPING SLEEVE SHALL PASS PRESSURE TESTING BASED ON

MUA REQUIREMENTS FOR FIRE AND DOMESTIC WATER LINE AND METER INSTALLATIONS (CONT.

- I. FOR ALL SERVICES INCLUDED HEREIN, TWO (2) GATE VALVES ARE REQUIRED THAT ARE TO BE INSTALLED BY THE APPLICANT; A TAPPING VALVE, LOCATED AT THE TAP AND CURB VALVE, LOCATED IN THE SIDEWALK BEFORE THE METER.
- TAPPING GATES SHALL BE FURNISHED OPENED RIGHT. ALL TAPPING, AND CURB VALVES SHALL BE DOUBLE DISC GATE VALVES AND MEET AWWA STANDARDS. THE WET TAP UP TO 12 INCHES SHALL BE PERFORMED BY UWJC. . FOR TAPS OFF MAINS SIXTEEN (16) INCHES AND LARGER, THE APPLICANT SHALL
- TAPPING VALVE. NO TAPS SHALL BE 3. PERMITTED ON MAINS LARGER THAN TWENTY (20) INCHES UNLESS THERE IS NO ALTERNATIVE WATER SOURCE, AND SPECIAL WRITTEN APPROVAL IS ISSUED BY THE ICMUA.
- 4. VALVE BOX PARTS FOR ALL VALVES SHALL BE PROVIDED BY THE APPLICANT. ALL TAPPING GATE VALVES LARGER THAN 2-INCHES AND ALL CURB VALVES / STOPS REGARDLESS OF SIZE REQUIRE A VALVE BOX WITH THE WORD "WATER" CAST IN THE COVER. BURIED CORPORATION VALVES/ STOPS SHALL BE USED AT THE TAP FOR CLASS K COPPER SERVICES 2-INCHES AND SMALLER.
- 5. ALL SERVICE PIPES, SIZES 2-INCHES THROUGH 12-INCHES, SHALL BE PRESSURE CLASS 350 PSI, CEMENT-LINED DUCTILE IRON PIPE WITH MECHANICAL JOINTS. 6. THE APPLICANT SHALL INSTALL THE METER INSIDE THE BUILDING. IF THE
- PLACE THE METER IN A PIT NEAR THE SIDEWALK OR STREET IN CLOSE PROXIMITY TO THE TAP.
- THAN 2"), A COMBINED REDUCED PRESSURE DETECTOR ASSEMBLY (AMES 5000 SS, AMES 5000 RPDA OR WATTS 909 RPDA*) SHALL BE INSTALLED ON THE MAIN FIRE SERVICE LINE AND A REDUCED PRESSURE BACKFLOW PREVENTER ON THE RYPASS (AMES 4000 SS OR WATTS 909*) (REFER TO FIGURE I), ON THE LIMITED
- FIRE SUPPRESSION SYSTEM (COMBINED SERVICE LINE 1.5" OR 2"), A FIRE LINE DETECTOR CHECK WITH A SINGLE CHECK VALVE (AMES 1000 DCV*) SHALL BE INSTALLED ON THE MAIN FIRE LINE AND A REDUCED PRESSURE BACKFLOW PREVENTER (AMES 4000 SS OR WATTS 909*) SHALL BE INSTALLED DOWNSTREAM OF THE BYPASS (REFER TO FIGURE 2) ALL REGULAR FIRE SUPPRESSION SYSTEMS MUST HAVE OS&Y VALVES: HOWEVER, LIMITED FIRE SUPPRESSION SYSTEMS MAY USE BALL VALVES (VICTAULIC SERIES 728 FIRELOCK*) INSTEAD OF OS&Y VALVES.
- THE FIRE UNIT SHALL BE FURNISHED WITH A 5/8-INCH X 3/4-INCH METERED BYPASS. BYPASS METERS SHALL BE JERSEY CITY STANDARD SINGLE DISPLACEMENT SENSUS METERS WITH TOUCHPAD AND RADIO READ CAPABILITIES. THE SAME RADIO MXU UNIT SHALL BE USED FOR A COMBINED DOMESTIC AND FIRE SERVICE.
- B. FOR DOMESTIC SERVICE, AN APPROVED REDUCED PRESSURE BACKFLOW PREVENTER (AMES 4000 SS OR WATTS 909*) IS REQUIRED WHEN THE [CMUA DETERMINES THAT THERE IS A CROSS-CONNECTION HAZARD AND THE FACILITY PRESENTS A THREAT TO THE CITY'S DISTRIBUTION SYSTEM WATER QUALITY IN ACCORDANCE WITH THE PLUMBING SUBCODE OF THE NEW JERSEY STATE UNIFORM CONSTRUCTION CODE, NJAC 5:23-3.15 AND THE NEW IERSEY SAFE DRINKING WATER ACT NIAC 7:10-10 PHYSICAL CONNECTIONS AND CROSS CONNECTIONS CONTROL BY CONTAINMENT. SOME SERVICES WHICH REQUIRE SUCH DEVICES INCLUDE: A HOSPITAL, SCHOOL, CHEMICAL PLANT, FACTORY, AND A FACILITY WITH SEWAGE EJECTORS.
- 9. IF A REDUCED PRESSURE BACKFLOW PREVENTER IS NOT REQUIRED ON THE DOMESTIC SERVICE, A CHECK VALVE SHOULD BE INSTALLED DOWNSTREAM OF THE TEST TEE
- 10. ALL METERS SIZES 2 INCHES THROUGH 6 INCHES SHALL BE SINGLE COMPOUND METERS AND ALL METERS 8 INCHES AND LARGER SHALL BE DUPLEX COMPOUND MANIFOLD METER
- II. ALL METERS SHALL BE ADEQUATELY RESTRAINED WITH METAL BRACKETS FASTENED TO THE FLOOR OR 12. WALL OR OTHER APPROVED MEANS SUCH AS UNIFLANGES WHERE INTERNAL PIPE PRESSURE AND FLOW WARRANT SUCH RESTRAINTS. METERS, DETECTOR CHECKS, AND VALVES MAY BE SEATED ON CONCRETE BLOCK AND TAPERED SHIMS TO PROVIDE ADEQUATE SUPPORT. METERS SHALL BE INSTALLED
- APPROXIMATELY 36" ABOVE FLOOR GRADE. 13. ALL METER INSTALLATIONS IN METER PIT OR VAULT SHALL BE PRE-APPROVED BY JCMUA AND HAVE PROPER ACCESS OPENINGS FOR METER READING AND REPLACEMENT. 14. EACH COMPOUND METER SHALL HAVE STRAINER INSTALLED ON THE INLET
- SIDE IMMEDIATELY BEFORE THE METER. ALL STRAINERS MUST BE PURCHASED FROM JCMUA OR ITS AUTHORIZED AGENT. 15. ALL METERS 2" AND LARGER SHALL BE FURNISHED WITH SENSUS ECR/WP REMOTE TOUCH PAD MODULES AND RADIO MXU UNITS FOR BOTH TYPES OF READING CAPABILITIES.
- 16. REMOTE TOUCH PAD MODULE WIRE SHALL BE CONNECTED TO THE METER REGISTER UTILIZING A GEL CAP FOR WATERTIGHT SEALING OF ALL TERMINAL CONNECTIONS. TOUCH PADS MAY BE WALL MOUNTED OR LID MOUNTED WHERE A METER PIT IS UTILIZED. TOUCH PADS ARE TO BE INSTALLED ON EXTERIOR BUILDING WALL FACING THE STREET AND LOCATED AS CLOSE AS POSSIBLE TO STREET THE RADIO MYLL LINIT MUST BE INST MOUNTING BRACKET AND LIKEWISE IS TO BE INSTALLED IN PROXIMITY TO
- 17. ALL INSTALLATIONS OF EQUIPMENT AND COMPONENTS SHALL BE PERFORMED IN ACCORDANCE WITH MANUFACTURER'S RECOMMENDATIONS. 18. ALL METERS INCLUDING TOUCH PAD MODULES, AND RADIO MXU UNITS SHALL BE PURCHASED THROUGH THE PERMIT CLERK AT JCMUA OFFICE. APPROVED PLANS MUST BE SUBMITTED TO THE PERMIT CLERK FOR ISSUANCE OF REQUIRED PERMITS
- 19. AFTER OBTAINING THE REQUIRED PERMITS (STREET OPENING, TAP, AND METER) THE APPLICANT SHALL CALL UWIC AT (201) 239-1108 TO SCHEDULE THE TAP. THE EXCAVATION SHALL BE COMPLETED TWENTY-FOUR (24) HOURS PRIOR TO THE SCHEDULED TAP, AND VERIFIED BY JCMUA OR ITS AUTHORIZED AGENT BEFORE THE TAP WILL BE INSTALLED. EXCAVATION SHALL BE CONSTRUCTED IN ACCORDANCE WITH OSHA REQUIREMENTS FOR SHEETING AND SAFETY.
- 20. UPON COMPLETION OF THE INSTALLATION, THE APPLICANT SHALL SUBMIT THREE (3) SETS OF "AS BUILT" PLANS, TO THE JCMUA'S BUREAU OF WATER ENGINEERING. THE JCMUA WILL AUTHORIZE SUPPLY WATER UPON ACCEPTANCE OF THE "AS BUILT" DRAWINGS.

JCMUA WATER DISTRIBUTION SYSTEM STANDARDS

- WATER MAINS SHALL BE CLASS 53, CEMENT LINED, DUCTILE IRON PIPE WITH MECHANICAL IOINTS AND SHALL BE IN CONFORMANCE WITH A.N.S.I. STANDARD A21.5-1976 (A.W.W.A. C151-76). ALL WATER MAINS WILL BE AT LEAST 8" IN DIAMETER. TEN (10") AND 14" DIAMETER MAINS SHALL NOT BE USED. GATE VALVES SHALL BE IN CONFORMANCE WITH A.N.S.I./A.W.W.A. STANDARD C500-80 AND SHALL BE JERSEY CITY STANDARD VALVES, M&H METROPOLITAN MECHANICAL JOINT VALVES AS MANUFACTURED BY DRESSER COMPANY OR APPROVED EQUAL. VALVES SHALL BE NON-RISING STEM, MECHANICAL JOINT SHALL BE FURNISHED WITH A (2") SOUARE OPERATING NUT SHALL OPEN BY TURNING TO THE RIGHT. GATE VALVES (16") AND OVER SHALL BE FURNISHED WITH BY-PASS. VALVE SHALL BE 100% SOLID HEAT CURED EPOXY COATED
- HOLIDAY-FREE IN THE WATERWAY. 3. BUTTERFLY VALVES SHALL BE IN CONFORMANCE WITH A.N.S.I./A.W.W.A. STANDARD C504-80. BUTTERFLY VALVES SHALL BE CLASS 1508, MECHANICAL JOINT, WITH RUBBER SEAT MOUNTED ON THE DISC, SHALL BE FURNISHED WITH A (2") INCH SOUARE OPERATING NUT AND SHALL OPEN BY TURNING TO THE RIGHT. THE VALVE SHALL BE 100%SOLID HEAT CURED EPOXY COATED
- HOLIDAY-FREE IN THE WATERWAY. THE USE OF BUTTERFLY VALVES WILL NOT BE PERMITTED IN MAINS (16") AND UNDER. 4. VALVES BOXES SHALL BE JERSEY CITY "STANDARD" AS MANUFACTURED BY BINGHAM AND TAYLOR, OR APPROVED EQUAL. BOXES SHALL HAVE A MINIMUM OF 8-1/4 INCH DIAMETER AND SHALL BE AN ADJUSTABLE SCREW TYPE WITH THE BOX EXTENDING FROM THE SURFACE TO (3") INCHES ABOVE THE VALVE BONNET BASE. VALVE BOX SHALL BE CAST IRON WITH A STANDARD COAL TAR FOUNDRY DIP WITH CAST IRON WATER DROP COVER AND THE WORK "WATER" CAST IN COVER. VALVE BOX COVER SHALL BE INSTALLED FLUSH WITH THE EXISTING GRADE ELEVATION.
- 5. CONCRETE FOR VALVE SEATS AND THRUST BLOCKS SHALL HAVE A MINIMUM 28 DAY STRENGTH OF 3000 PSI 6. SELECT GRANULAR BACKFILL MATERIAL SHALL BE SOIL AGGREGATE TYPE I-6 (POROUS FILL, CLEAN SAND, GRAVEL OR STONE) OBTAINED FROM DRY SOURCES AND SHALL BE FREE FROM STUMPS, BRUSH, WEEDS, ROOTS, RUBBISH, WOOD AND OTHER MATERIAL THAT MAY DECAY. GRADUATION SHALL
- BACKFILL MATERIAL SHALL BE PLACED AND COMPACTED IN TWELVE (12) INCH LIFTS 7. TIE RODS SHALL BE THREE QUARTER (3/4) INCH DIAMETER THREADED STEEL BARS. RODS SHALL HAVE A MINIMUM YIELD STRESS OF 36,000 PSI. THRUST
- BLOCKS AND TIE RODS SHALL BE INSTALLED AT ALL BENDS AND FITTINGS. 8. COUPLINGS SHALL BE DRESSER STYLE NUMBER 153 FOR PIPE SIZES THROUGH (30") INCH DIAMETER. FOR LARGER DIAMETER PIPE, DRESSER STYLE NUMBER 38 STEEL COUPLINGS SHALL BE USED.
- 9. SHEETING, SHORING AND BRACING SHALL BE CLOSED VERTICAL SHEETING, TONGUE AND GROOVE THAT IS BRACED TO PREVENT THE CAVE-IN OF TRENCHES. ALL LABOR EQUIPMENT, MATERIALS AND METHODS OF CONSTRUCTION SHALL CONFORM TO THE REQUIREMENTS OF THE UNITED STATES OCCUPATIONAL SAFETY AND HEALTH ADMINISTRATION. MATERIALS FOR SHEETING SHALL BE TONGUE AND GROOVE WOODEN PLANKS AND TIMBER OR STEEL CONFORMING TO THE REOUIREMENTS OF THE UNITED STATES OCCUPATIONAL SAFETY AND HEALTH ADMINISTRATION TIMBER SHALL BE A MINIMUM OF 3" THICK. SHEETING SHALL BE LEFT IN PLACE. SHORING AND BRACING SHALL BE REMOVED.

FURNISH AND INSTALL AN ADDITIONAL GATE VALVE ADJACENT TO THE

BUILDING LINE IS IN EXCESS OF 75 FT. FROM THE MAIN, THE APPLICANT SHALL

7. FOR A REGULAR FIRE SUPPRESSION SYSTEM (COMBINED SERVICE LINE LARGER


CONFORM TO TABLE 901-2, FOR TYPE I-6 IN ARTICLE 901.09 OF THE (N.J.D.O.T.) NEW JERSEY DEPARTMENT OF TRANSPORTATION STANDARD SPECIFICATIONS.

DESCRIPTION SYMBOL PROPERTY LINE PROPOSED SANITARY LATERAL _____ SAN _____ PROPOSED DOMESTIC WATER SERVICE PROPOSED FIRE SERVICE ——— E/T/C PROPOSED ELECTRICAL/DATA CONDUITS PROPOSED GAS LINE PROPOSED SANITARY MANHOLE /

JCMUA WATER DISTRIBUTION SYSTEM STANDARDS (CONT.)

CLEANOUT

- BROKEN STONE FOUNDATION CUSHION SHALL BE PLACED IN THOSE AREAS WHERE THE DIRECTOR. DEPARTMENT OF ENGINEERING HAS DEEMED THE SOIL CONDITIONS INFERIOR. BROKEN STONE SHALL CONFORM TO ARTICLE 901.03 OF THE STANDARD SPECIFICATIONS AS CURRENTLY AMENDED. THE SIZE OF BROKEN STONE SHALL BE AS SHOWN ON THE PLANS OR AS DIRECTED BY THE ENGINEER FOR SIZE NUMBER 2, 4, 5, OR 6 AS SHOWN IN TABLE 901-1. STANDARD SIZES OF COARSE AGGREGATES OF THE NEW JERSEY DEPARTMENT OF TRANSPORTATION STANDARD SPECIFICATIONS.
- FILTER CLOTH SHALL BE PLACED IN THOSE AREAS WHERE THE DIRECTOR, DEPARTMENT OF ENGINEERING HAS DEEMED THE SOIL CONDITIONS INFERIOR. AFTER THE ENGINEER HAS INSPECTED THE COMPLETED
- INSTALLATION OF VALVES, AND WATER MAIN, AND BEFORE BACKELLING THE EXCAVATIONS THE CONTRACTOR SHALL FURNISH ALL LABOR, MATERIALS AND EQUIPMENT REQUIRED TO PRESSURE TEST THE PIPE. THE PIPE SHALL BE PRESSURIZED TO 1.5 X THE WORKING PRESSURE FOR A PERIOD OF TWO (2) HOURS. PRESSURE SHALL NOT VARY MORE THAN FIVE (5) PSL. THE VALVED SECTION OF PIPE SHALL BE FILLED WITH WATER SLOWLY, AND THE TEST PRESSURE SHALL BE APPLIED BY MEANS OF A PUMP CONNECTED TO THE PIPE IN A MANNER SATISFACTORY TO THE ENGINEER. BEFORE APPLYING THE TEST PRESSURE, AIR SHALL BE EXPELLED COMPLETELY FROM THE PIPE BY INSTALLING CORPORATION COCKS AT SUCH POINTS SO THAT THE AIR CAN BE EXPELLED AS THE LINE IS FILLED WITH WATER. IF THE JOINTS LEAK, REPAIRS OR REPLACEMENTS Shall be made. Testing shall be in conformance with A.W.W.A. STANDARD C600-77. THE CONTRACTOR SHALL DISINFECT ALL WATER MAINS IN
- ACCORDANCE WITH A.W.W.A. STANDARD FOR "DISINFECTING WATER MAINS" DESIGNATION C-601 COMMERCIAL PRODUCTS SUCH AS "HTH". "PERCHLARON". AND "MAXOXHLOR" MAY BE USED IN FLAKE OR CRYSTAL FORM, BUT IN NO INSTANCE WILL TABLETS BE PERMITTED TO BE USED IN THE DISINFECTION OF WATER MAINS. THE CHLORINE DOSAGE SHALL INITIALLY PRODUCE 50 PPM RESIDUAL TO THE WATER AND MAINTAIN A MINIMUM RESIDUAL OF 25 PPM AFTER 24 HOURS. AFTER SATISFACTORY DISINFECTION OF THE TEST SECTION. THE LINE SHALL BE CONTINUOUSLY FLUSHED UNTIL THE RESULTANT CHLORINE RESIDUAL EQUALS ONE PPM OR THE RESIDUAL OF THE SYSTEM, WHICHEVER IS GREATER, AFTER FINAL FLUSHING AND REFORE THE WATER MAIN IS PLACED IN SERVICE SAMPLES SHALL BE COLLECTED FROM EACH END OF THE MAIN AND TESTED FOR BACTERIOLOGIC QUALITY. IF THE INITIAL DISINFECTION FAILS TO PRODUCE SATISFACTORY SAMPLES, DISINFECTION SHALL BE REPEATED UNTIL SATISFACTORY SAMPLES HAVE BEEN OBTAINED.
- 5. AIR RELEASE VALVES SHALL BE INSTALLED AT THE HIGH POINTS OF THE WATER MAINS. 6. ALL WATER MAINS WILL BE AT LEAST 8" IN DIAMETER. TEN (10") AND 14" DIAMETER MAINS SHALL NOT BE USED.
- 7. THRUST BLOCKS AND TIE RODS SHALL BE INSTALLED AT ALL BENDS AND FITTINGS.
- 8. HYDRANTS SHALL BE TWO (2) PIECE "IERSEY CITY STANDARD" HYDRANTS AS MANUFACTURED BY A.P. SMITH OR APPROVED EQUAL. HYDRANT SPACING SHALL BE A MAXIMUM 300 FEET MEASURED CENTER TO CENTER.
- 9. FOR EITHER NEW CONSTRUCTION OR RELOCATION OF THE FOLLOWING SHALL BE REOUIRED: A. HYDRANTS SHALL BE LOCATED NO CLOSER THAN 20 FEET FROM THE
- POINT OF TANGENCY OR CURVATURE AT INTERSECTIONS. B. ALL ONE PIECE OR HYDRANTS NOT MANUFACTURED BY A.P. SMITH THAT ARE TO BE RELOCATED SHALL BE REMOVED AND DELIVERED TO IERSEY CITY DIVISION OF WATER DISTRIBUTION. A NEW HYDRANT
- WILL BE SUPPLIED BY THE CITY FOR INSTALLATION. HYDRANTS SHALL BE NO CLOSER THAN TEN (10") FEET FROM THE EDGE OF A RESIDENTIAL DRIVEWAY OR (20") FEET FROM THE EDGE OF COMMERCIAL DRIVEWAY. IN THE CASE WHERE DRIVEWAYS ARE EXPANDED OR NEWLY CONSTRUCTED, THE OWNER SHALL BE RESPONSIBLE FOR THE RELOCATION OF AN EXISTING HYDRANT IF ABOVE REOUIREMENTS ARE VIOLATED.
- D. ALL SINGLE GATED HYDRANTS ON (16") INCH OR LARGER MAINS SHALL REQUIRE A NEW VALVE AT THE BASE OF THE RELOCATED HYDRANT
- 19. EXISTING WATER SERVICE LINES SHALL BE SHUT-OFF AND CAPPED AT THE MAIN PRIOR TO THE INSTALLATION OF NEW WATER SERVICES. PRIOR TO NEW SERVICE TAP THE IERSEY CITY WATER DEPARTMENT SHALL INSPECT AND CERTIFY THE ABANDONED SERVICES. 20. WATER MAINS TO ABANDON SHALL BE CUT AND PLUGGED WITH REQUIRED FITTINGS, RODS AND CONCRETE AS CLOSE TO THE
- EXISTING MAIN IN SERVICE AS POSSIBLE. 21. ALL VALVES SHALL BE OPERATED BY JERSEY CITY WATER DEPARTMENT PERSONNEL. THE CONTRACTOR SHALL NOT BE
- PERMITTED TO OPERATE ANY VALVES. THE CONTRACTOR SHALL NOTIFY THE ENGINEER. IN WRITING, FIVE (5) DAYS IN ADVANCE OF VALVE OPERATING REQUIREMENTS. 22. FAILURE TO COMPLY WITH THE ABOVE REQUIREMENTS WILL RESULT
- IN THE IMMEDIATE SHUT-DOWN OF THE PROJECT.

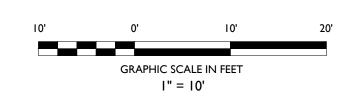

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SEAL

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ARTHUR KUYAN, P.E. NEW JERSEY LICENSE No. 55741 LICENSED PROFESSIONAL ENGINEER

15	01/06/2023	PB RESUBMISSION
14	12/16/2022	JCMUA REVISIONS
13	11/28/2022	FOR BUILDING
15	11/20/2022	PERMIT
12	10/31/2022	PSEG REVISION
11	10/05/2022	PER JCMUA
11	10/05/2022	COMMENTS
10	08/08/2022	PB RESUBMISSION
9	07/20/2022	REVISED DRAINAGE
8	04/20/2022	AMENDED FINAL
0	06/20/2022	SITE PLAN
7	05/12/2022	REVISED GRADING
6	04/22/2022	JCMUA REVISIONS
5	03/25/2022	JCMUA REVISIONS
4	09/03/2021	ISSUED FOR BID
3	07/02/2021	CD 90%
2	06/07/2021	CD 75%
1	04/09/2021	CD 50%
#	Date	Issue

SUMMIT TOWER

622-628 SUMMIT AVE JERSEY CITY, NEW JERSEY 07306 BLOCK 6701, LOT 21.01

Project Description

PROPOSED NEW MIXED USE BUILDING WITH 209 RESIDENTIAL UNITS

Applicant 628 SUMMIT AVE, LLC


Scale

Project Title

Project Number: T-18276 Drawn by KB Checked by KB

Sheet Title UTILITY PLAN (GROUND FLOOR)

As Noted

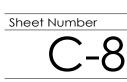

										GENERAL LIGHTING NOTES
			PROPOSED LUMINAIRE						LIGHTING REQUIREMENTS	I. THE LIGHTING LEVELS DEPICTED WITHIN THE PLAN SET ARE CALCULATED UTILIZING DATA OBTAINED FROM THE LISTED
SYMBOL	LABEL	QUANTIT			LLF	MANUFACTURER	IES FILE	CODE SECTION	REQUIRED PROPOSED	MANUFACTURER. ACTUAL ILLUMINATION LEVELS AND PERFORMANCE OF ANY PROPOSED LIGHTING FIXTURE MAY VARY DUE TO
								§ III.F.3.	ADEQUATE LIGHTING SHALL BE PROVIDED TO ENCOURAGE COMPLIES ACTIVE USAGE AND A SENSE OF SECURITY IN THE OPEN	UNCONTROLLABLE VARIABLES SUCH ARE WEATHER, VOLTAGE SUPPLY, LAMP TOLERANCE, EQUIPMENT SERVICE LIFE AND OTHER VARIABLE FIELD CONDITIONS
	A	25	WILLIAMS 4DS DOWNLIGHT L10 OW-OF-CS 3000K	ow	0.90	H.E. WILLIAMS, INC.	4DS-L10-830-DIM-UNV-OW-OF-CS.IES	§ III.G.7.	SPACE. LIGHTING WITHIN THE SITE SHALL SUFFICIENTLY COMPLIES ILLUMINATE ALL AREAS, INCLUDING THOSE AREAS WHERE BUILDING ARE SETBACK OR OFFSET TO PREVENT DARK	VARIABLE FIELD CONDITIONS. 2. WHERE APPLICABLE, THE EXISTING LIGHT LEVELS DEPICTED WITHIN THE PLAN SET SHALL BE CONSIDERED APPROXIMATE. THE EXISTING LIGHT LEVELS ARE BASED ON FIELD OBSERVATIONS AND THE MANUEACTURER'S DATA OF THE ASSUMED OR MOST SIMILAR
	В	14	CAMMAN LIGHTING OW610-24 CARLISLE 3000K	N/A	0.90	CAMMAN	CAMMAN OW610-24-LN.IES	§ III.G.8.	CORNERS. ALL LIGHTING SOURCES MUST BE ADEQUATELY SHIELDED 2.7 FC AVERAGE TO AVOID ANY OFF-SITE GLARE. THE AREA OF 2.7 FC AVERAGE	 MANUFACTURER'S DATA OF THE ASSUMED OR MOST SIMILAR LIGHTING FIXTURE MODEL. 3. UNLESS NOTED ELSEWHERE WITHIN THIS PLAN SET, THE LIGHT LOSS FACTORS USED IN THE LIGHTING ANALYSIS ARE AS FOLLOWS: LIGHT EMITTING DIODES (LED): 0.90
0	с	2	PHILIPS HADCO SIGNATURE LED, T3, 88W,	TYPE III	0.90	PHILIPS HADCO	RL32XDXXXWXXNX4XXXX-GX4.IES	§ 345-69.B.6.b	ILLUMINATION SHALL HAVE A UNIFORM PATTERN OF AT LEAST ONE-HALF (0.5) FOOT CANDLES. MAXIMUM LIGHTING INTENSITY AT PROPERTY LINE SHALL BE 0.5 FOOT CANDLES.	 HIGH PRESSURE SODIUM: 0.72 METAL HALIDE: 0.72 4. THE CONTRACTOR SHALL NOTIFY STONEFIELD ENGINEERING &
			BLACK FINISH					(V) VARIANCE		DESIGN, LLC. IN WRITING, PRIOR TO THE START OF CONSTRUCTION, OF ANY PROPOSED LIGHTING LOCATIONS THAT CONFLICT WITH EXISTING/ PROPOSED DRAINAGE, UTILITY, OR OTHER IMPROVEMENTS.
										 THE CONTRACTOR IS RESPONSIBLE TO PREPARE A WIRING PLAN AND PROVIDE ELECTRIC SERVICE TO ALL PROPOSED LIGHTING FIXTURES.
/	\									THE CONTRACTOR IS REQUIRED TO PREPARE AN AS-BUILT PLAN OF WIRING AND PROVIDE COPIES TO THE OWNER AND STONEFIELD
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٥.2 ٥.٤	0.3	0.4	$\begin{array}{c ccccccccccccccccccccccccccccccccccc$	A. 1 +5. B	6.4 (8')					
⁺ 0.2 ⁺ 0.2	⁺ 0.3	+ 0.4	0.5 0.7 1.1 $1.6 \ge 2.3$ 2.9 3.4 3.5	* 3.5 + 4.2	4.4	ž.6				€ 0.0 0.0 0.0 0.0 0.0 0.0 0.0 0.0 0.0 0.
⁺ ∩ 2 ⁺ ∩ 2	\ +0.2	+			+					
0.2 0.2	0.3	0.3		2.2 2.4		1.8 0.5 B (8')				
[†] 0.1 [†] 0.2	[†] 0,2	0.3	$0.4 \xrightarrow{S}_{Q_{2}}^{\dagger} 0.5_{S_{2}} = 0.6 \xrightarrow{0.8}_{L_{3}} 1.0 \xrightarrow{1.1} 1.2 \xrightarrow{1.3}_{S} 1.3$	[†] .4 [†] .5	1.7 V	2.2			00 00 00 00 00 00 00 00 00 00 00 00 00	
⁺ 0.1 ⁺ 0.2	⁺ 0.2	0.2	13 = 0.4 0.5 0.7 0.7 0.7 0.7 0.7	+	[†] 4	$\frac{1}{2}$ $\frac{1}{2}$ $\frac{1}{2}$ $\frac{1}{2}$ $\frac{1}{2}$ $\frac{1}{2}$ $\frac{1}{2}$ $\frac{1}{2}$ $\frac{1}{2}$				
						A (18')				
⁺ 0.1 ⁺ 0.1	⁺ 0.2	0.2	$\dot{0}.3$ $\dot{0}.4$ $\dot{0}.4$ $\dot{0}.5$ $\dot{0}.6$ $\dot{0}.6$	0. v 0.8	[†] .0	1.9 3.3 4.4				$^{+}0.0$ $^{+}0.0$ $^{+}0.0$ $^{+}0.0$ $^{+}0.0$ $^{+}0.0$ $^{+}0.0$ $^{+}0.0$ $^{+}0.0$ $^{+}0.0$
⁺ 0.1 ⁺ 0.1	⁺ 0.2	⁺ 0.2	0.2 $\dot{0}.3$ $\dot{0}.3$ $\dot{0}.3$ $\dot{0}.4$ $\dot{0}.4$ $\dot{0}.4$ $\dot{0}.4$	Q.5 0.6	⁺ 0.8	1.5 ³ .1 [★] 4.5		M ATT		
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0.1 0.1	0.2	0.2	$\begin{array}{cccccccccccccccccccccccccccccccccccc$	[†] 0.4 [†] 0.5	⁺ 0.6	1.3 3.0 4.5				
⁺ 0.1 ⁺ 0.1	⁺ 0.1	[†] 0.2		⁺ 0.4 ⁺ 0.4	[‡] 0.5	[†] .1 [⁺] 2.6 [†] 4.2				0.0 [†] 0.0
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⁺ 0.1 ⁺ 0.1	⁺ 0. I	⁺ 0.2	0.2 0.2 0.3 0.3 0.3 0.3 0.4 0.4 0.4 0.4 0.4	^{\$ +} 0.5 +0.5	⁺ 0.7	1.2 [‡] .6 [‡] .1		T		
[†] 0.1 [†] 0.1	⁺ 0.1	+		[†] 0.6	+	1.4 [†] 2.8 [†] 3.9				
0.7				3		A (18)				
⁺ 0.1 ⁺ 0.1	⁺ 0.2	0.2	0.2 $\stackrel{\circ}{_{0.3}}$ $\stackrel{\circ}{_{0.4}}$ 0.4 0.5 $\stackrel{\circ}{_{0.6}}$ $\stackrel{\circ}{_{0.6}}$ $\stackrel{\circ}{_{0.6}}$ $\stackrel{\circ}{_{0.8}}$ $\stackrel{\circ}{_{0.8}}$	[†] 0.9	İ.3	1.7 2.7 2.5 B (8')				
⁺ 0.1 ⁺ 0.1	⁺ 0.2	[†] 0.2		≥ †.3 †.5	⁺ 2.0	¹ / _{2.6} ¹ / _{0.9}				x = x $x = x$ x x $x = x$ x x x x x x x x x
+ '	+	+	C)		ł		PROPOSED 29-STC	DRY		
⁺ 0.1 ⁺ 0.1	0.2	0.2	$\begin{array}{c ccccccccccccccccccccccccccccccccccc$	2.0	3.3	4.3 3.5 B (8')	MIXED-USE DEVELOPMENT			⁺ 0.0
[†] 0.1 [†] 0.1	⁺ 0.2	⁺ 0.2	1.3 $^{\circ}0.4$ $^{\circ}0.5$ $\gtrsim^{\circ}0.7$ 1.1 1.5 $^{\circ}2.1$ $^{\circ}2.6$ \bigcirc	3.I ⇒ 3.6	4.8	9.5 H 49	209 DWELLING UNITS			⁺ 0.0
⁺ от тот	⁺∩ ⊃	[†] ∩ 2	b_{3} b_{4} b_{6} b_{9} b_{3} b_{5} b_{10} b_{10}	45		A (16')		∕∥閧		
v.i V.I	0.2	0.2		4.5 4.3	3.9					⁺ 0.0
⁺ 0.1 ⁺ 0.2	⁺ 0.2	⁺ 0.3	1.3 0.5 0.7 1.0 1.6 1.7_{\ge} 4.2 5.2	-	⁺ 3.3	⁵ .7 ⁶ .1 ³ .1				⁺ 0.0
⁺ 0.1 ⁺ 0.2	⁺ 0.2	[†] 0.3	0.3 [†] 0.5 [†] 0.7 [†] .1 [†] .7 [†] .0 [†] 5.0 [†] 5.0	2.8 ≥ 14	[‡] 2.5	A (16 ⁺) ⁺ 5.4 8.2 ⁺ 2.1				⁺ 0.0
Ŧ			>	C) (10')	B (8')				
[†] 0.1 [†] 0.1	⁺ 0.2	0.3	0.3 0.5 0.7 1.1_{\geq} 1.7 2.8 4.8 5.4							⁺ 0.0
⁺ 0.1 ⁺ 0.1	⁺ 0.2	⁺ 0.2 [†] 0.2	$0.3 \stackrel{1}{0.5} \stackrel{1}{0.6} \stackrel{1}{0.9} \stackrel{0}{1.4} \stackrel{1}{2.3} \stackrel{2}{3.7} \stackrel{1}{4.7}$	+① + 5.0 + 4.4 g	⁺ 4.6	A (16') 1.4 ⁵ 6.9 ⁴ .2				[†] 0.0
⁺ · · · ⁺ · ·	+ • • •	+ 0 2	0.3 $\stackrel{\uparrow}{0.4}$ $\stackrel{\downarrow}{0.6}$ $\stackrel{\downarrow}{0.8} \ge 1.1$ $1.7 \ge 2.5$ 3.2	>						
				(D)						⁺ 0.0
⁺ 0.1 ⁺ 0.1	⁺ 0.2	⁺ 0.2 ($\begin{array}{c ccccccccccccccccccccccccccccccccccc$	[‡] .2 [‡] .4	⁺ 2.9					⁺ 0.0
⁺ 0.1 ⁺ 0.1	⁺ 0.1	⁺ 0.2 ⁺	$\begin{array}{c ccccccccccccccccccccccccccccccccccc$	1.3 <u>1.5</u>	1.8	BUILDING HT = 2.4 2.4 58' +/- 1.3	to.0 to.0 to.0 to.0 to.0 to.0	to.0 10.0 10.0		² ¹ 0.0 ¹
				\geq				BUILDING HT =	$\begin{array}{c ccccccccccccccccccccccccccccccccccc$	
U.I 0.I	0.1	0.2 (0.2 0.3 0.4 0.5 0.6 0.7 0.8	0.8 0.9	1.0	0.8 0.4	0.2 0.0 0 ¢0+/- 0.0 0	0.0 0.0 0.0	υ.υ 0.0 0.0 0.0 0.0 0.0 0.0 0.0 0.0 0.0	0.0 0.0 0.0 0.0 0.0 0.0 0.0 0.0 0.0 0.0

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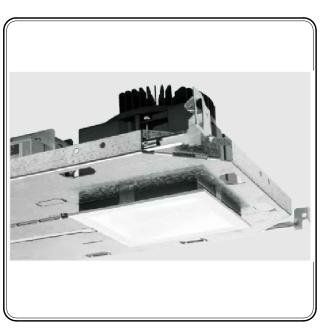
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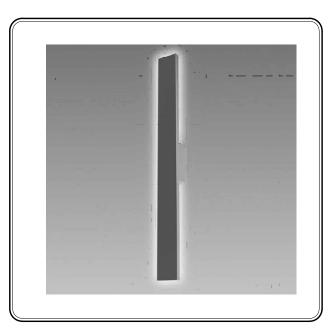
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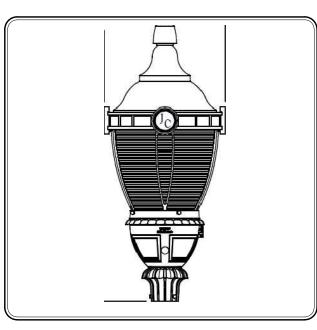
DESCRIPTION
PROPOSED LIGHTING FIXTURE (MOUNTING HEIGHT)
PROPOSED LIGHTING INTENSITY (FOOTCANDLES)
PROPOSED BUILDING MOUNTED LIGHT



CANOPY LIGHTING FIXTURE TYPE 'A'



WALL LIGHTING FIXTURE TYPE 'B'



AREA LIGHTING FIXTURE TYPE 'C'

GRAPHIC SCALE IN FEET 1" = 10'



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> ARTHUR KUYAN, P.E. NEW JERSEY LICENSE No. 55741 LICENSED PROFESSIONAL ENGINEER

15	01/06/2023	PB RESUBMISSION
14	12/16/2022	JCMUA REVISIONS
13	11/28/2022	FOR BUILDING
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9	07/20/2022	REVISED DRAINAGE
8	06/20/2022	AMENDED FINAL
0	0072072022	SITE PLAN
7	05/12/2022	REVISED GRADING
6	04/22/2022	JCMUA REVISIONS
5	03/25/2022	JCMUA REVISIONS
4	09/03/2021	ISSUED FOR BID
3	07/02/2021	CD 90%
2	06/07/2021	CD 75%
1	04/09/2021	CD 50%
#	Date	Issue
Dre	ie et Title	
710	ject Title	

SUMMIT TOWER


622-628 SUMMIT AVE JERSEY CITY, NEW JERSEY 07306 BLOCK 6701, LOT 21.01


Project Description PROPOSED NEW MIXED USE BUILDING WITH 209 RESIDENTIAL UNITS

Applicant	
628 SUMMIT AVE, LLC	


Project Number :T-18276Drawn by:KBChecked by:KBScale:As Noted

Sheet Title LIGHTING PLAN

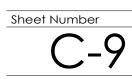

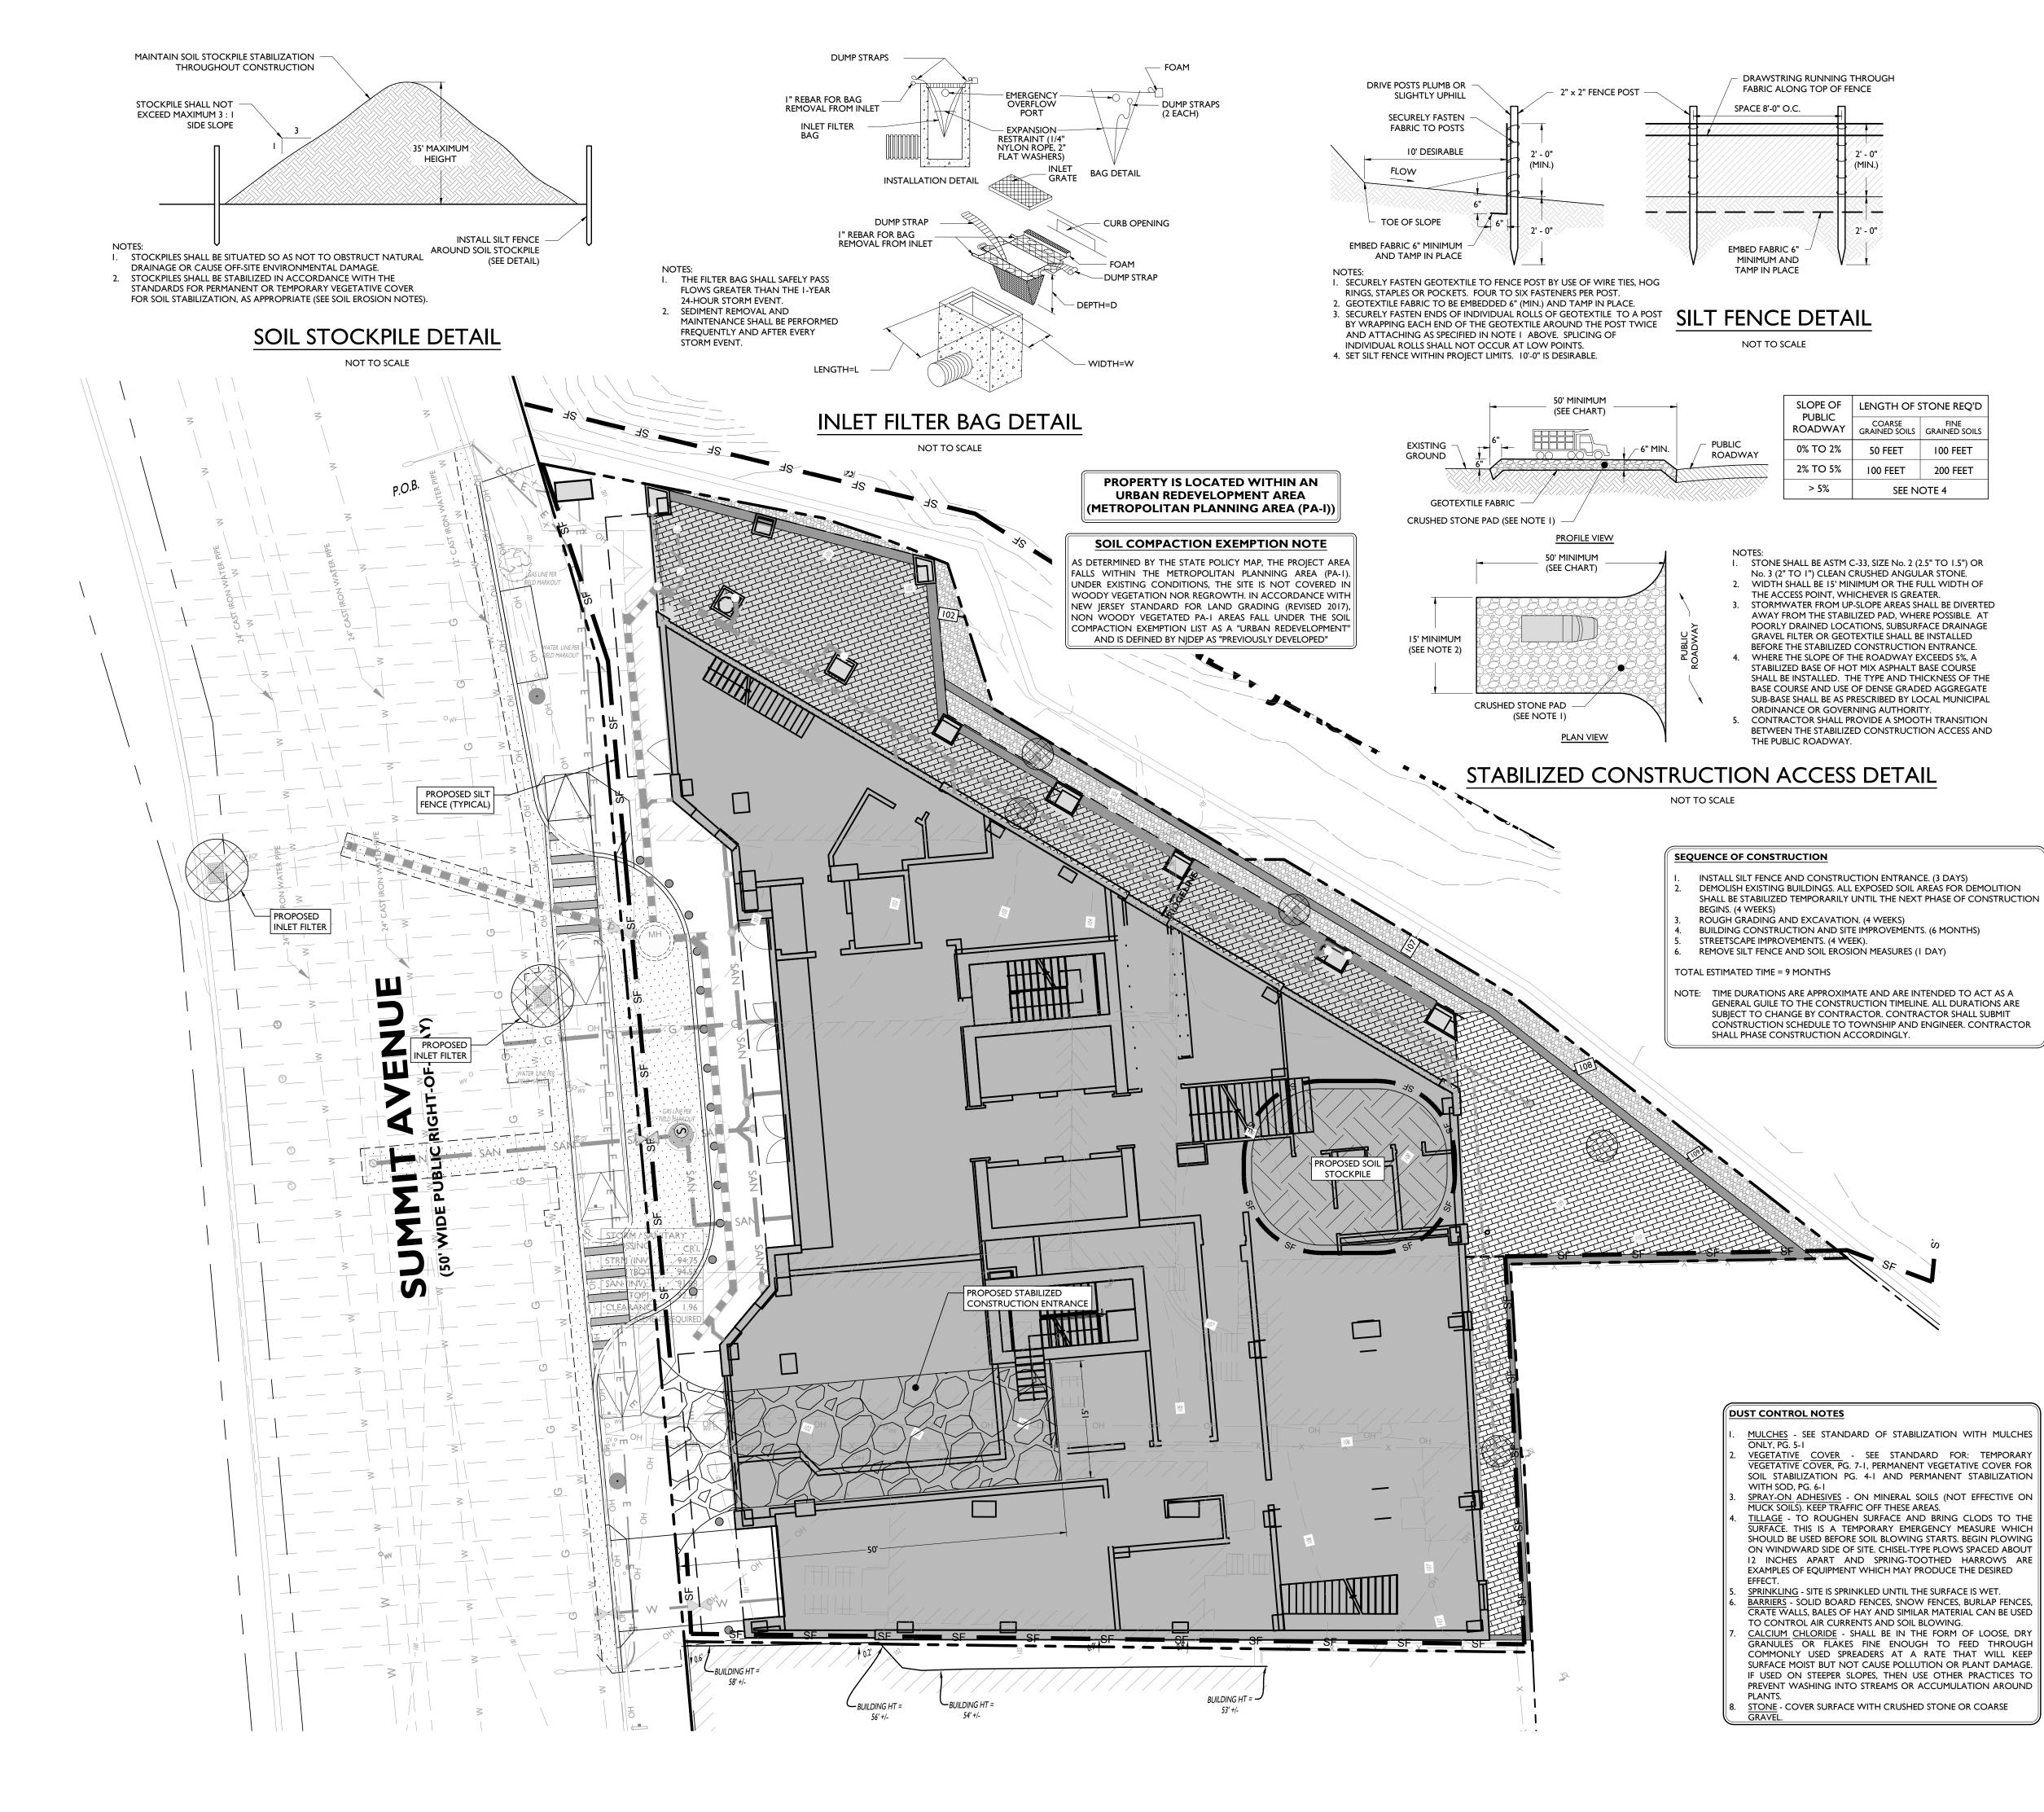

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PROPOSED INLET PROTECTION FILTER

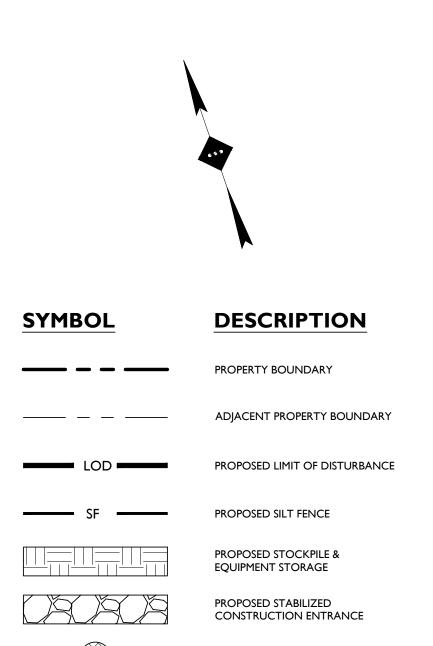HUDSON-ESSEX-PASSAIC SOIL CONSERVATION DISTRICT SOIL EROSION AND SEDIMENT CONTROL NOTES

- I. ALL SOIL EROSION AND SEDIMENT CONTROL PRACTICES ON THIS PLAN WILL BE CONSTRUCTED IN ACCORDANCE WITH THE "NEW JERSEY STANDARDS FOR SOIL EROSION AND SEDIMENT CONTROL" 7TH EDITION LAST REVISED DECEMBER 2017. THESE MEASURES WILL BE INSTALLED PRIOR TO ANY MAJOR SOIL DISTURBANCE OR IN THEIR PROPER SEQUENCE AND MAINTAINED
- UNTIL PERMANENT PROTECTION IS ESTABLISHED. 2. ALL SOIL TO BE EXPOSED OR STOCKPILED FOR A PERIOD OF GREATER THAN 14 DAYS, AND NOT UNDER ACTIVE CONSTRUCTION, WILL BE TEMPORARILY SEEDED AND HAY MULCHED OR OTHERWISE PROVIDED WITH VEGETATIVE COVER. THIS TEMPORARY COVER SHALL BE MAINTAINED UNTIL SUCH TIME WHEREBY PERMANENT RESTABILIZATION IS ESTABLISHED.
- 3. SEEDING DATES: THE FOLLOWING SEEDING DATES ARE RECOMMENDED TO BEST ESTABLISH PERMANENT VEGETATIVE COVER WITHIN MOST LOCATIONS IN THE HEPSCD: SPRING - 3/1-5/15 AND FALL - 8/15 - 10/1 4. SEDIMENT FENCES ARE TO BE PROPERLY TRENCHED AND MAINTAINED
- UNTIL PERMANENT VEGETATIVE COVER IS ESTABLISHED 5. ALL STORM DRAINAGE INLETS SHALL BE PROTECTED BY ONE OF THE PRACTICES ACCEPTED IN THE STANDARDS, AND PROTECTION SHALL REMAIN UNTIL PERMANENT STABILIZATION HAS BEEN ESTABLISHED. STORM DRAINAGE OUTLET POINTS SHALL BE PROTECTED AS REQUIRED
- BEFORE THEY BECOME FUNCTIONAL 6. MULCH MATERIALS SHALL BE UN-ROTTED SMALL GRAIN STRAW APPLIED AT THE RATE OF 70 TO 90 POUNDS PER 1,000 SQUARE FEET AND ANCHORED WITH A MULCH ANCHORING TOOL, LIQUID MULCH BINDERS, OR NETTING TIE DOWN. OTHER SUITABLE MATERIALS MAY BE USED IF APPROVED BY THE SOIL CONSERVATION DISTRICT.
- 7. ALL EROSION CONTROL DEVICES SHALL BE PERIODICALLY INSPECTED, MAINTAINED AND CORRECTED BY THE CONTRACTOR. ANY DAMAGE INCURRED BY EROSION SHALL BE RECTIFIED IMMEDIATELY. 8. THE HUDSON-ESSEX-PASSAIC SOIL CONSERVATION DISTRICT WILL BE
- NOTIFIED IN WRITING AT LEAST 48 HOURS PRIOR TO ANY SOIL DISTURBING ACTIVITIES. FAX-(862)333-4507 OR EMAIL -INFORMATION@HEPSCD.ORG 9. THE APPLICANT MUST OBTAIN A DISTRICT ISSUED
- REPORT-OF-COMPLIANCE PRIOR TO APPLYING FOR THE CERTIFICATE OF OCCUPANCY OR TEMPORARY CERTIFICATE OF OCCUPANCY FROM THE RESPECTIVE MUNICIPALITY. NI -DCA OR ANY OTHER CONTROLLING AGENCY. CONTACT THE DISTRICT AT 862-333-4505 TO REQUEST A FINAL INSPECTION, GIVING ADVANCED NOTICE UPON COMPLETION OF THE RESTABILIZATION MEASURES. A PERFORMANCE DEPOSIT MAY BE POSTED WITH THE DISTRICT WHEN WINTER WEATHER OR SNOW COVER PROHIBITS THE PROPER APPLICATION OF SEED, MULCH, FERTILIZER OR HYDRO-SEED.
- 10. PAVED ROADWAYS MUST BE KEPT CLEAN AT ALL TIMES. DO NOT UTILIZE A FIRE OR GARDEN HOSE TO CLEAN ROADS UNLESS THE RUNOFF IS DIRECTED TO A PROPERLY DESIGNED AND FUNCTIONING SEDIMENT BASIN. WATER PUMPED OUT OF THE EXCAVATED AREAS CONTAINS SEDIMENTS THAT MUST BE REMOVED PRIOR TO DISCHARGING TO RECEIVING BODIES OF WATER USING REMOVABLE PUMPING STATIONS, SUMP PITS, PORTABLE SEDIMENTATION TANKS AND/OR SILT CONTROL BAGS.
- II. ALL SURFACES HAVING LAWN OR LANDSCAPING AS FINAL COVER ARE TO BE PROVIDED TOPSOIL PRIOR TO RE-SEEDING, SODDING OR PLANTING. A DEPTH OF 5.0 INCHES, FIRMED IN PLACE, IS **REQUIRED**, AS PER THE STANDARDS FOR TOPSOILING AND LAND GRADING, LAST REVISED DECEMBER 2017. 12. ALL PLAN REVISIONS MUST BE SUBMITTED TO THE DISTRICT FOR
- PROPER REVIEW AND APPROVAL. 13. A CRUSHED STONE WHEEL CLEANING TRACKING-PAD IS TO BE INSTALLED AT ALL SITE EXITS USING 2 1/2 -1" CRUSHED ANGULAR STONE (ASTM 2 OR 3) TO A MINIMUM LENGTH OF 50 FEET AND MINIMUM DEPTH OF 6". ALL DRIVEWAYS MUST BE PROVIDED WITH CRUSHED STONE UNTIL PAVING IS COMPLETE. 14. STEEP SLOPES INCURRING DISTURBANCE MAY REQUIRE ADDITIONAL
- STABILIZATION MEASURES. THESE "SPECIAL" MEASURES SHALL BE DESIGNED BY THE APPLICANT'S ENGINEER AND BE APPROVED BY THE SOIL CONSERVATION DISTRICT.
- 15.THE HUDSON-ESSEX-PASSAIC SOIL CONSERVATION DISTRICT SHALL BE NOTIFIED, IN WRITING, FOR THE SALE OF ANY PORTION OF THE PROJECT OR FOR THE SALE OF INDIVIDUAL LOTS. NEW OWNERS' INFORMATION SHALL BE PROVIDED. ADDITIONAL MEASURES DEEMED NECESSARY BY DISTRICT OFFICIALS SHALL BE IMPLEMENTED AS CONDITIONS WARRANT.

TYPE OF SOIL URBAN LAND (URTILB) PERCENT OF SITE COVERAGE 100.0%	SOIL CHARACTERISTICS CHART						
	TYPE OF SOIL						
10' 0' 10' 20'	PERCENT OF SI	TE COVERAGE					
10' 0' 10' 20'							
	10'	0'	10'	20'			

Architecture + Design 360 14th St. , Hoboken, NJ, 07030

T. 201-386-0637 E. info@mvmkarchitecture.com www.mvmkarchitecture.com

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ARTHUR KUYAN, P.E. NEW JERSEY LICENSE No. 55741 LICENSED PROFESSIONAL ENGINEER

15	01/06/2023	PB RESUBMISSION	
14	12/16/2022	JCMUA REVISIONS	
13	11/28/2022	FOR BUILDING	
10	11/20/2022	PERMIT	
12	10/31/2022	PSEG REVISION	
11	10/05/2022	PER JCMUA	
	10/03/2022	COMMENTS	
10	08/08/2022	PB RESUBMISSION	
9	07/20/2022	REVISED DRAINAGE	
8	06/20/2022	AMENDED FINAL	
0	00/20/2022	SITE PLAN	
7	05/12/2022	REVISED GRADING	
6	04/22/2022	JCMUA REVISIONS	
5	03/25/2022	JCMUA REVISIONS	
4	09/03/2021	ISSUED FOR BID	
3	07/02/2021	CD 90%	
2	06/07/2021	CD 75%	
1	04/09/2021	CD 50%	
#	Date	Issue	
Project Title			

SUMMIT TOWER

622-628 SUMMIT AVE JERSEY CITY, NEW JERSEY 07306 BLOCK 6701, LOT 21.01

Project Description

PROPOSED NEW MIXED USE BUILDING WITH 209 RESIDENTIAL UNITS

Applicant 628 SUMMIT AVE, LLC

Scale

Project Number: T-18276 Drawn by KB Checked by : KB


As Noted

Sheet Title SOIL EROSION & SEDIMENT CONTROL PLAN

Sheet Number C-10

S		

100 FEET

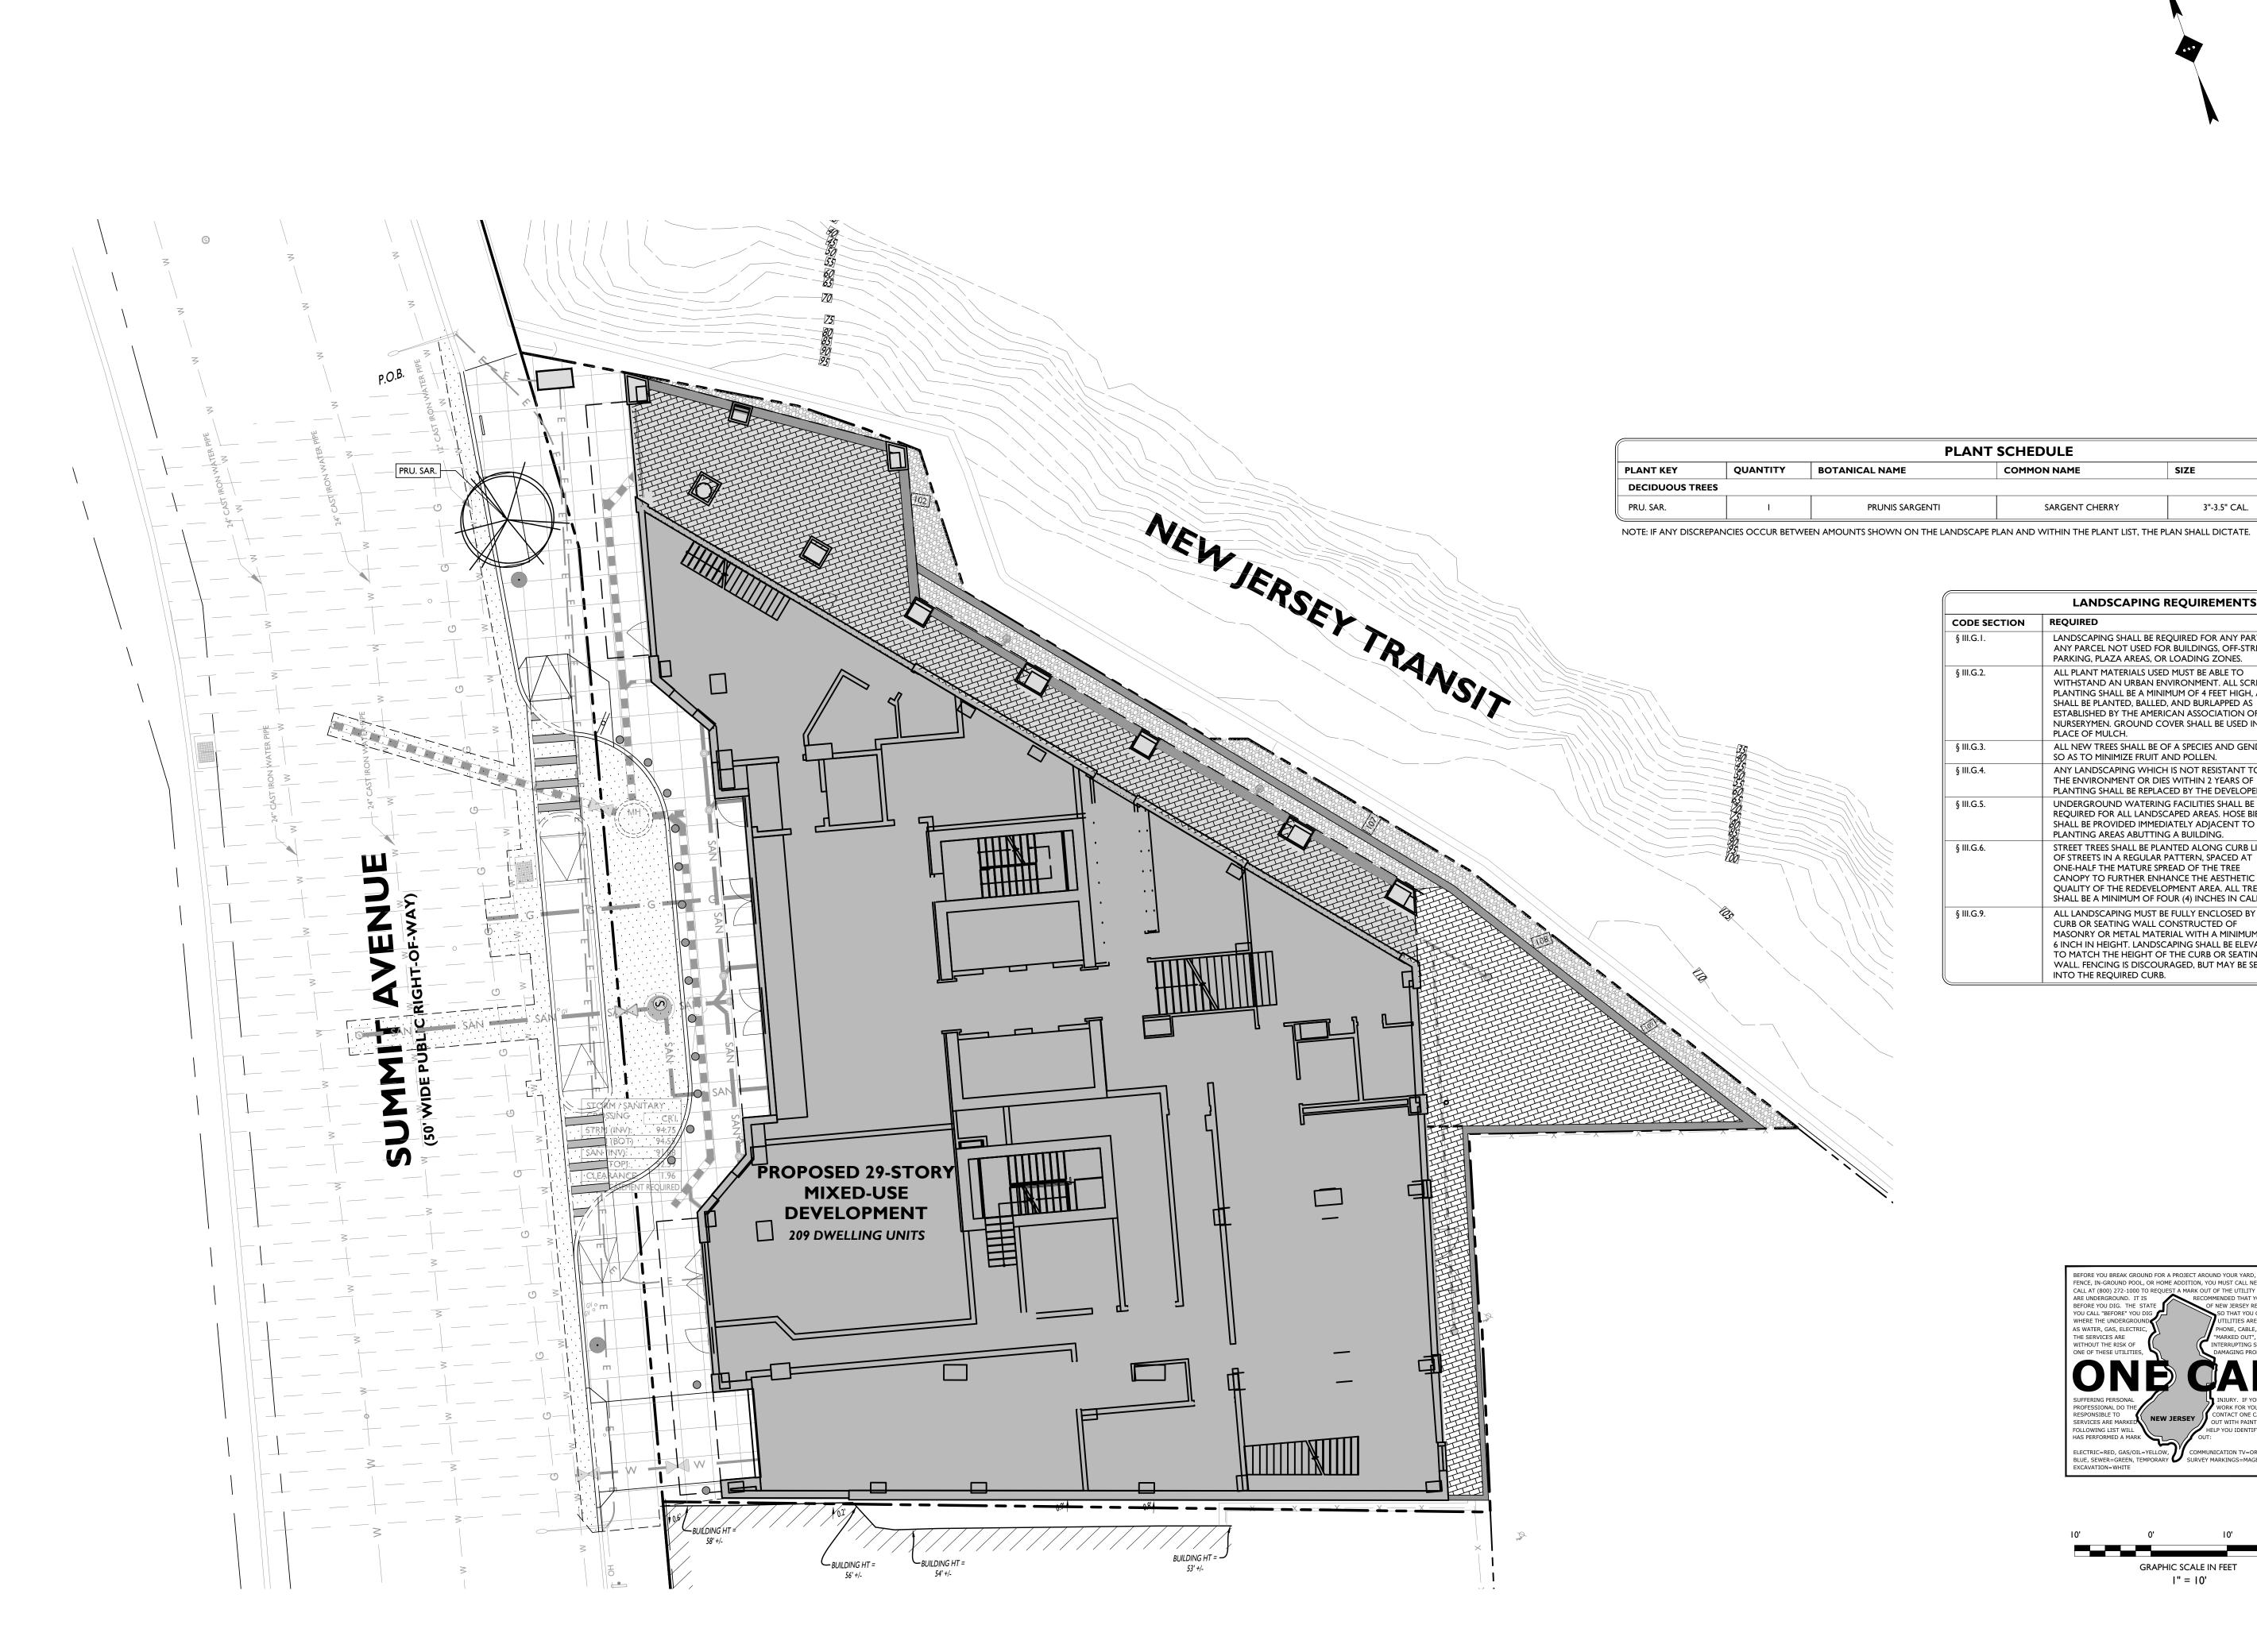

PLANT SCHEDULE				
AL NAME	COMMON NAME	SIZE	REMARKS	
PRUNIS SARGENTI	SARGENT CHERRY	3"-3.5" CAL.	B&B	

LANDSCAPING REQUIREMENTS				
CODE SECTION	REQUIRED	PROPOSED		
§ III.G.1.	LANDSCAPING SHALL BE REQUIRED FOR ANY PART OF ANY PARCEL NOT USED FOR BUILDINGS, OFF-STREET PARKING, PLAZA AREAS, OR LOADING ZONES.	COMPLIES		
§ III.G.2.	ALL PLANT MATERIALS USED MUST BE ABLE TO WITHSTAND AN URBAN ENVIRONMENT. ALL SCREEN PLANTING SHALL BE A MINIMUM OF 4 FEET HIGH, AND SHALL BE PLANTED, BALLED, AND BURLAPPED AS ESTABLISHED BY THE AMERICAN ASSOCIATION OF NURSERYMEN. GROUND COVER SHALL BE USED IN PLACE OF MULCH.	COMPLIES		
§ III.G.3.	ALL NEW TREES SHALL BE OF A SPECIES AND GENDER SO AS TO MINIMIZE FRUIT AND POLLEN.	COMPLIES		
§ III.G.4.	ANY LANDSCAPING WHICH IS NOT RESISTANT TO THE ENVIRONMENT OR DIES WITHIN 2 YEARS OF PLANTING SHALL BE REPLACED BY THE DEVELOPER.	COMPLIES		
§ III.G.5.	UNDERGROUND WATERING FACILITIES SHALL BE REQUIRED FOR ALL LANDSCAPED AREAS. HOSE BIBS SHALL BE PROVIDED IMMEDIATELY ADJACENT TO PLANTING AREAS ABUTTING A BUILDING.	COMPLIES		
§ III.G.6.	STREET TREES SHALL BE PLANTED ALONG CURB LINES OF STREETS IN A REGULAR PATTERN, SPACED AT ONE-HALF THE MATURE SPREAD OF THE TREE CANOPY TO FURTHER ENHANCE THE AESTHETIC QUALITY OF THE REDEVELOPMENT AREA. ALL TREES SHALL BE A MINIMUM OF FOUR (4) INCHES IN CALIPER.	COMPLIES		
§ III.G.9.	ALL LANDSCAPING MUST BE FULLY ENCLOSED BY CURB OR SEATING WALL CONSTRUCTED OF MASONRY OR METAL MATERIAL WITH A MINIMUM OF 6 INCH IN HEIGHT. LANDSCAPING SHALL BE ELEVATED TO MATCH THE HEIGHT OF THE CURB OR SEATING WALL. FENCING IS DISCOURAGED, BUT MAY BE SET INTO THE REQUIRED CURB.	COMPLIES		



GRAPHIC SCALE IN FEET |" = |0'

15	01/06/2023	PB RESUBMISSION
14	12/16/2022	JCMUA REVISIONS
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SUMMIT TOWER


622-628 SUMMIT AVE JERSEY CITY, NEW JERSEY 07306 BLOCK 6701, LOT 21.01

Project Description PROPOSED NEW MIXED USE BUILDING WITH 209 RESIDENTIAL UNITS

Applicant	
628 SUMMIT AVE, LLC	

_	Project Numb	er:	T-18276
	Drawn by	:	КВ
	Checked by	:	КВ
	Scale	:	As Noted

Sheet Title LANDSCAPING PLAN

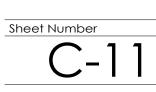


Minervini Vandermark Melia Kelly
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360 14th St. , Hoboken, NJ, 07030 T. 201-386-0637
E. info@mvmkarchitecture.com
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JERSEY CITY 4' X 12' STREET TREE PLANTING DETAIL NOT TO SCALE

- I. THE LANDSCAPE CONTRACTOR SHALL FURNISH ALL MATERIALS AND PERFORM ALL WORK IN ACCORDANCE WITH THESE I. ALL PLANT MATERIAL SHALL CONFORM TO THE AMERICAN STANDARD FOR NURSERY STOCK (ANSI Z60.1-2004) OR LATEST SPECIFICATIONS, APPROVED OR FINAL DRAWINGS, AND INSTRUCTIONS PROVIDED BY THE PROJECT LANDSCAPE DESIGNER, MUNICIPAL OFFICIALS, OR OWNER/OWNER'S REPRESENTATIVE. ALL WORK COMPLETED AND MATERIALS FURNISHED AND INSTALLED SHALL BE IN STRICT ACCORDANCE WITH THE INTENTION OF THE SPECIFICATIONS, DRAWINGS, AND INSTRUCTIONS AND EXECUTED WITH THE STANDARD LEVEL OF CARE FOR THE LANDSCAPE INDUSTRY. 2. WORK MUST BE CARRIED OUT ONLY DURING WEATHER CONDITIONS FAVORABLE TO LANDSCAPE CONSTRUCTION AND TO
- THE HEALTH AND WELFARE OF PLANTS. THE SUITABILITY OF SUCH WEATHER CONDITIONS SHALL BE DETERMINED BY THE PROJECT LANDSCAPE DESIGNER OR GOVERNING MUNICIPAL OFFICIAL 3. IT IS THE RESPONSIBILITY OF THE LANDSCAPE CONTRACTOR, BEFORE ORDERING OR PURCHASING MATERIALS, TO PROVIDE SAMPLES OF THOSE MATERIALS TO THE PROJECT LANDSCAPE DESIGNER OR GOVERNING MUNICIPAL OFFICIAL FOR APPROVAL,
- IF SO REQUESTED. 4. IF SAMPLES ARE REQUESTED, THE LANDSCAPE CONTRACTOR IS TO SUBMIT CERTIFICATION TAGS FROM TREES, SHRUBS AND SEED VERIFYING TYPE AND PURITY.
- 5. UNLESS OTHERWISE AUTHORIZED BY THE PROJECT LANDSCAPE DESIGNER OR GOVERNING MUNICIPAL OFFICIAL, THE LANDSCAPE CONTRACTOR SHALL PROVIDE NOTICE AT LEAST FORTY-EIGHT HOURS (48 HRS.) IN ADVANCE OF THE ANTICIPATED DELIVERY DATE OF ANY PLANT MATERIALS TO THE PROJECT SITE. A LEGIBLE COPY OF THE INVOICE, SHOWING VARIETIES AND SIZES OF MATERIALS INCLUDED FOR EACH SHIPMENT SHALL BE FURNISHED TO THE PROJECT LANDSCAPE DESIGNER, OR GOVERNING MUNICIPAL OFFICIAL
- 6. THE PROJECT LANDSCAPE DESIGNER OR GOVERNING MUNICIPAL OFFICIAL RESERVES THE RIGHT TO INSPECT AND REJECT PLANTS AT ANY TIME AND AT ANY PLACE.

PROTECTION OF EXISTING VEGETATION NOTES:

- I. BEFORE COMMENCING WORK, ALL EXISTING VEGETATION WHICH COULD BE IMPACTED AS A RESULT OF THE PROPOSED CONSTRUCTION ACTIVITIES MUST BE PROTECTED FROM DAMAGE BY THE INSTALLATION OF TREE PROTECTION FENCING. FENCING SHALL BE LOCATED AT THE DRIP-LINE OR LIMIT OF DISTURBANCE AS DEPICTED WITHIN THE APPROVED OR FINAL PLAN SET, ESTABLISHING THE TREE PROTECTION ZONE. FENCE INSTALLATION SHALL BE IN ACCORDANCE WITH THE PROVIDED "TREE PROTECTION FENCE DETAIL." NO WORK MAY BEGIN UNTIL THIS REQUIREMENT IS FULFILLED. THE FENCING SHALL BE INSPECTED REGULARLY BY THE LANDSCAPE CONTRACTOR AND MAINTAINED UNTIL ALL CONSTRUCTION ACTIVITIES HAVE BEEN COMPLETED.
- 2. IN ORDER TO AVOID DAMAGE TO ROOTS, BARK OR LOWER BRANCHES, NO VEHICLE, EQUIPMENT, DEBRIS, OR OTHER MATERIALS SHALL BE DRIVEN, PARKED OR PLACED WITHIN THE TREE PROTECTION ZONE. ALL ON-SITE CONTRACTORS SHALL USE ANY AND ALL PRECAUTIONARY MEASURES WHEN PERFORMING WORK AROUND TREES, WALKS, PAVEMENTS, UTILITIES, AND ANY OTHER FEATURES EITHER EXISTING OR PREVIOUSLY INSTALLED UNDER THIS CONTRACT. 3. IN RARE INSTANCES WHERE EXCAVATING, FILL, OR GRADING IS REQUIRED WITHIN THE DRIP-LINE OF TREES TO REMAIN, THE
- WORK SHALL BE PERFORMED AS FOLLOWS: • TRENCHING: WHEN TRENCHING OCCURS AROUND TREES TO REMAIN, THE TREE ROOTS SHALL NOT BE CUT, BUT THE TRENCH SHALL BE TUNNELED UNDER OR AROUND THE ROOTS BY CAREFUL HAND DIGGING AND WITHOUT INJURY TO
- THE ROOTS. NO ROOTS, LIMBS, OR WOODS ARE TO HAVE ANY PAINT OR MATERIAL APPLIED TO ANY SURFACE. RAISING GRADES: WHEN THE GRADE AT AN EXISTING TREE IS BELOW THE NEW FINISHED GRADE, AND FILL NOT EXCEEDING 6 INCHES (6") IS REQUIRED, CLEAN, WASHED GRAVEL FROM ONE TO TWO INCHES (1" - 2") IN SIZE SHALL BE PLACED DIRECTLY AROUND THE TREE TRUNK. THE GRAVEL SHALL EXTEND OUT FROM THE TRUNK ON ALL SIDES A MINIMUM OF 18 INCHES (18") AND FINISH APPROXIMATELY TWO INCHES (2") ABOVE THE FINISH GRADE AT TREE. INSTALL GRAVEL BEFORE ANY EARTH FILL IS PLACED. NEW EARTH FILL SHALL NOT BE LEFT IN CONTACT WITH THE TRUNK OF ANY TREE REQUIRING FILL. WHERE FILL EXCEEDING 6 INCHES (6") IS REQUIRED, A DRY LAID TREE WELL SHALL BE CONSTRUCTED. IF APPLICABLE, TREE WELL INSTALLATION SHALL BE IN ACCORDANCE WITH THE PROVIDED "TREE WELL DETAIL."
- LOWERING GRADES: EXISTING TREES LOCATED IN AREAS WHERE THE NEW FINISHED GRADE IS TO BE LOWERED, SHALL HAVE RE-GRADING WORK DONE BY HAND TO THE INDICATED ELEVATION, NO GREATER THAN SIX INCHES (6"). ROOTS SHALL BE CUT CLEANLY THREE INCHES (3") BELOW FINISHED GRADE UNDER THE DIRECTION OF A LICENSED ARBORIST. WHERE CUT EXCEEDING 6 INCHES (6") IS REQUIRED, A DRY LAID RETAINING WALL SHALL BE CONSTRUCTED. IF APPLICABLE, THE RETAINING WALL INSTALLATION SHALL BE IN ACCORDANCE WITH THE PROVIDED "TREE RETAINING WALL DETAIL."

SOIL PREPARATION AND MULCH NOTES:

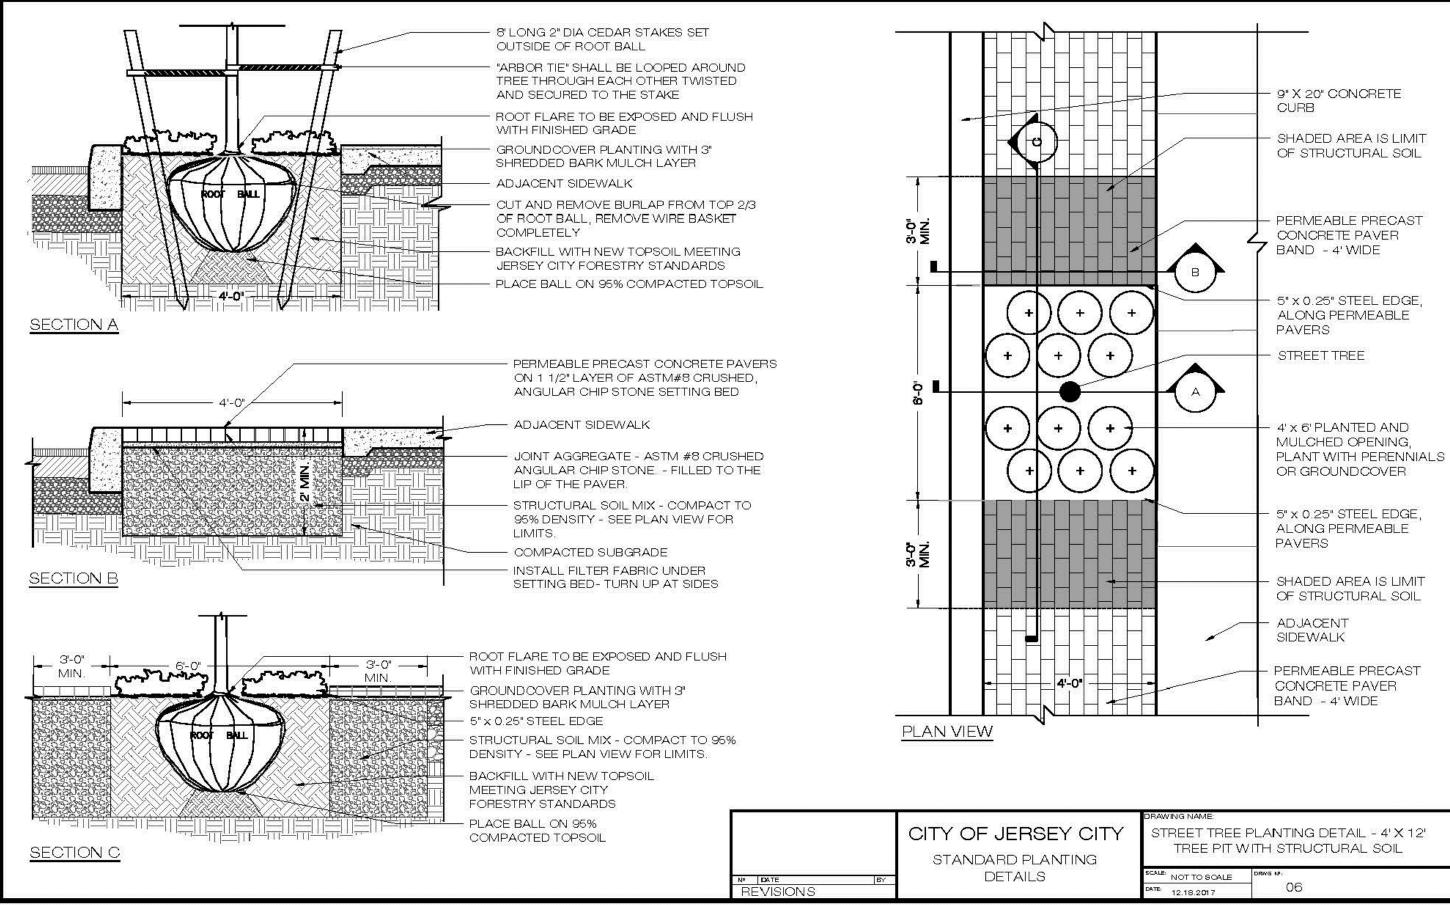- I. LANDSCAPE CONTRACTOR SHALL OBTAIN A SOIL TEST OF THE IN-SITU TOPSOIL BY A CERTIFIED SOIL LABORATORY PRIOR TO PLANTING. LANDSCAPE CONTRACTOR SHALL ALLOW FOR A TWO WEEK TURNAROUND TIME FROM SUBMITTAL OF SAMPLE TO NOTIFICATION OF RESULTS.
- 2. BASED ON SOIL TEST RESULTS, ADJUST THE RATES OF LIME AND FERTILIZER THAT SHALL BE MIXED INTO THE TOP SIX INCHES (6") OF TOPSOIL. THE LIME AND FERTILIZER RATES PROVIDED WITHIN THE "SEED SPECIFICATION" OR "SOD SPECIFICATION" IS APPROXIMATE AND FOR BIDDING PURPOSES ONLY. IF ADDITIONAL AMENDMENTS ARE NECESSARY, ADJUST THE TOPSOIL AS FOLLOWS: • MODIFY HEAVY CLAY OR SILT SOILS (MORE THAN 40% CLAY OR SILT) BY ADDING COMPOSTED PINE BARK (UP TO 30% BY
- VOLUME) OR GYPSUM. MODIFY EXTREMELY SANDY SOILS (MORE THAN 85%) BY ADDING ORGANIC MATTER AND/OR DRY, SHREDDED CLAY LOAM UP TO 30% OF THE TOTAL MIX.
- 3. TOPSOIL SHALL BE FERTILE, FRIABLE, NATURAL TOPSOIL OF LOAMING CHARACTER, WITHOUT ADMIXTURE OF SUBSOIL MATERIAL OBTAINED FROM A WELL-DRAINED ARABLE SITE, FREE FROM ALL CLAY, LUMPS, COARSE SANDS, STONES, PLANTS, ROOTS, STICKS, AND OTHER FOREIGN MATERIAL GREATER THAN ONE INCH (1"). 4. TOPSOIL SHALL HAVE A PH RANGE OF 5.0-7.0 AND SHALL NOT CONTAIN LESS THAN 6% ORGANIC MATTER BY WEIGHT
- 5. OBTAIN TOPSOIL ONLY FROM LOCAL SOURCES OR FROM AREAS HAVING SIMILAR SOIL CHARACTERISTICS TO THAT FOUND AT THE PROJECT SITE. 6. CONTRACTOR SHALL PROVIDE A SIX INCH (6") DEEP LAYER OF TOPSOIL IN ALL PLANTING AREAS. TOPSOIL SHALL BE SPREAD
- OVER A PREPARED SURFACE IN A UNIFORM LAYER TO ACHIEVE THE DESIRED COMPACTED THICKNESS. THE SPREADING OF TOPSOIL SHALL NOT BE CONDUCTED UNDER MUDDY OR FROZEN SOIL CONDITIONS. . UNLESS OTHERWISE NOTED IN THE CONTRACT, THE LANDSCAPE CONTRACTOR SHALL BE RESPONSIBLE FOR THE INSTALLATION OF TOPSOIL AND THE ESTABLISHMENT OF FINE-GRADING WITHIN THE DISTURBED AREA OF THE SITE.
- . LANDSCAPE CONTRACTOR SHALL VERIFY THAT THE SUB-GRADE ELEVATION MEETS THE FINISHED GRADE ELEVATION (LESS REQUIRED TOPSOIL), IN ACCORDANCE WITH THE APPROVED OR FINAL GRADING PLAN. 9. ALL LAWN AND PLANTING AREAS SHALL BE GRADED TO A SMOOTH, EVEN AND UNIFORM PLANE WITH NO ABRUPT CHANGE
- OF SURFACE AS DEPICTED WITHIN THE APPROVED OR FINAL CONSTRUCTION SET UNLESS OTHERWISE DIRECTED BY THE PROJECT LANDSCAPE DESIGNER OR MUNICIPAL OFFICIAL. 10. THE CONTRACTOR SHALL BE RESPONSIBLE FOR PROPER SURFACE AND SUBSURFACE PLANT BED DRAINAGE PRIOR TO THE INSTALLATION OF PLANTINGS. IF POOR DRAINAGE CONDITIONS EXIST, CORRECTIVE ACTION SHALL BE TAKEN PRIOR TO INSTALLATION, ALL PLANTING AND LAWN AREAS SHALL BE GRADED AND MAINTAINED TO ALLOW A FREE FLOW OF SURFACE WATER
- II. DOUBLE SHREDDED HARDWOOD MULCH OR APPROVED EQUAL SHALL BE USED AS A THREE INCH (3") TOP DRESSING IN ALL SHRUB PLANTING BEDS AND AROUND ALL TREES PLANTED BY LANDSCAPE CONTRACTOR, GROUND COVER, PERENNIAL, AND ANNUAL PLANTING BEDS SHALL BE MULCHED WITH A TWO INCH (2") TOP DRESSING. SINGLE TREES OR SHRUBS SHALL BE MULCHED TO AVOID CONTACT WITH TRUNK OR PLANT STEM. MULCH SHALL BE OF SUFFICIENT CHARACTER AS NOT TO BE EASILY DISPLACED BY WIND OR WATER RUNOFF
- 12. WHENEVER POSSIBLE, THE SOIL PREPARATION AREA SHALL BE CONNECTED FROM PLANTING TO PLANTING. 13. SOIL SHALL BE LOOSENED WITH A BACKHOE OR OTHER LARGE COARSE-TILING EQUIPMENT UNLESS THE SOIL IS FROZEN OR EXCESSIVELY WET. TILING THAT PRODUCES LARGE, COARSE CHUNKS OF SOIL IS PREFERABLE TO TILING THAT RESULTS IN FINE GRAINS UNIFORM IN TEXTURE. AFTER THE AREA IS LOOSENED IT SHALL NOT BE DRIVEN OVER BY ANY VEHICLE. 14. APPLY PRE-EMERGENT WEED CONTROL TO ALL PLANT BEDS PRIOR TO MULCHING. ENSURE COMPATIBILITY BETWEEN
- PRODUCT AND PLANT MATERIAL 5. ALL PLANTING SOIL SHALL BE AMENDED WITH THE FOLLOWING:

MYCRO® TREE SAVER - A DRY GRANULAR MYCORRHIZAL FUNGI INOCULANT THAT IS MIXED IN THE BACKFILL WHEN PLANTING TREES AND SHRUBS. IT CONTAINS SPORES OF BOTH ECTOMYCORRHIZAL AND VA MYCORRHIZAL FUNGI (VAM), BENEFICIAL RHIZOSPHERE BACTERIA. TERRA-SORB SUPERABSORBENT HYDROGEL TO REDUCE WATER LEACHING, AND SELECTED ORGANIC MICROBIAL NUTRIENTS.

- DIRECTIONS FOR USE: USE 3-OZ PER EACH FOOT DIAMETER OF THE ROOT BALL, OR 3-OZ PER INCH CALIPER. MIX INTO THE BACKFILL WHEN TRANSPLANTING TREES AND SHRUBS. MIX PRODUCT IN A RING-SHAPED VOLUME OF SOIL AROUND THE UPPER PORTION OF THE ROOT BALL, EXTENDING FROM THE SOIL SURFACE TO A DEPTH OF ABOUT 8 INCHES, AND EXTENDING OUT FROM THE ROOT BALL ABOUT 8 INCHES INTO THE BACKFILL. APPLY WATER TO SOIL SATURATION.
- MYCOR® TREE SAVER® IS EFFECTIVE FOR ALL TREE AND SHRUB SPECIES EXCEPT RHODODENDRONS, AZALEAS, AND MOUNTAIN LAUREL, WHICH REQUIRE ERICOID MYCORRHIZAE. • SOIL PH: THE FUNGI IN THIS PRODUCT WERE CHOSEN BASED ON THEIR ABILITY TO SURVIVE AND COLONIZE PLANT ROOTS
- IN A PH RANGE OF 3 TO 9. • FUNGICIDES: THE USE OF CERTAIN FUNGICIDES CAN HAVE A DETRIMENTAL EFFECT ON THE INOCULATION PROGRAM. SOIL
- APPLICATION OF ANY FUNGICIDE IS NOT RECOMMENDED FOR TWO WEEKS AFTER APPLICATION. OTHER PESTICIDES: HERBICIDES AND INSECTICIDES DO NOT NORMALLY INTERFERE WITH MYCORRHIZAL FUNGAL DEVELOPMENT, BUT MAY INHIBIT THE GROWTH OF SOME TREE AND SHRUB SPECIES IF NOT USED PROPERLY.

HEALTHY START MACRO TABS 12-8-8

• FERTILIZER TABLETS ARE PLACED IN THE UPPER 4 INCHES OF BACKFILL SOIL WHEN PLANTING TREES AND SHRUBS. • TABLETS ARE FORMULATED FOR LONG-TERM RELEASE BY SLOW BIODEGRADATION, AND LAST UP TO 2 YEARS AFTER PLANTING. TABLETS CONTAIN 12-8-8 NPK FERTILIZER, AS WELL AS A MINIMUM OF SEVEN PERCENT (7%) HUMIC ACID BY WEIGHT, MICROBIAL NUTRIENTS DERIVED FROM SEA KELP, PROTEIN BYPRODUCTS, AND YUCCA SCHIDIGERA, AND A COMPLEMENT OF BENEFICIAL RHIZOSPHERE BACTERIA. THE STANDARD 21 GRAM TABLET IS SPECIFIED HERE. DIRECTIONS FOR USE: FOR PLANTING BALLED & BURLAPPED (B&B) TREES AND SHRUBS, MEASURE THE THICKNESS OF THE TRUNK, AND USE ABOUT I TABLET (21-G) PER HALF-INCH. PLACE THE TABLETS DIRECTLY NEXT TO THE ROOT BALL, EVENLY DISTRIBUTED 3. REFERENCE LANDSCAPE PLAN FOR AREAS TO BE SEEDED OR LAID WITH SOD. AROUND ITS PERIMETER, AT A DEPTH OF ABOUT 4 INCHES.

PLANT QUALITY AND HANDLING NOTES:

REVISION AS PUBLISHED BY THE AMERICAN NURSERY AND LANDSCAPE ASSOCIATION. 2. IN ALL CASES, BOTANICAL NAMES LISTED WITHIN THE APPROVED OR FINAL PLANT LIST SHALL TAKE PRECEDENCE OVER

COMMON NAMES 3. ALL PLANTS SHALL BE OF SELECTED SPECIMEN QUALITY, EXCEPTIONALLY HEAVY, TIGHTLY KNIT, SO TRAINED OR FAVORED IN THEIR DEVELOPMENT AND APPEARANCE AS TO BE SUPERIOR IN FORM, NUMBER OF BRANCHES, COMPACTNESS AND SYMMETRY. ALL PLANTS SHALL HAVE A NORMAL HABIT OR SOUND, HEALTHY, VIGOROUS PLANTS WITH WELL DEVELOPED ROOT SYSTEM. PLANTS SHALL BE FREE OF DISEASE, INSECT PESTS, EGGS OR LARVAE. 4. PLANTS SHALL NOT BE PRUNED BEFORE DELIVERY. TREES WITH ABRASION OF THE BARK, SUNSCALDS, DISFIGURING KNOTS OR

FRESH CUTS OF LIMBS OVER ONE AND ONE-FOURTH INCHES (1-1/4") WHICH HAVE NOT COMPLETELY CALLOUSED SHALL BE REIECTED 5. ALL PLANTS SHALL BE TYPICAL OF THEIR SPECIES OR VARIETY AND SHALL HAVE A NORMAL HABIT OF GROWTH AND BE LEGIBLY

TAGGED WITH THE PROPER NAME AND SIZE. 6. THE ROOT SYSTEM OF EACH PLANT SHALL BE WELL PROVIDED WITH FIBROUS ROOTS. ALL PARTS SHALL BE SOUND, HEALTHY, VIGOROUS WELL-BRANCHED AND DENSELY FOLIATED WHEN IN LEAF

7. ALL PLANTS DESIGNATED BALL AND BURLAP (B&B) MUST BE MOVED WITH THE ROOT SYSTEM AS SOLID UNITS WITH BALLS OF EARTH FIRMLY WRAPPED WITH BURLAP. THE DIAMETER AND DEPTH OF THE BALLS OF EARTH MUST BE SUFFICIENT TO ENCOMPASS THE FIBROUS ROOT FEEDING SYSTEMS NECESSARY FOR THE HEALTHY DEVELOPMENT OF THE PLANT. NO PLANT SHALL BE ACCEPTED WHEN THE BALL OF EARTH SURROUNDING ITS ROOTS HAS BEEN BADLY CRACKED OR BROKEN PREPARATORY TO OR DURING THE PROCESS OF PLANTING. THE BALLS SHALL REMAIN INTACT DURING ALL OPERATIONS. ALL PLANTS THAT CANNOT BE PLANTED AT ONCE MUST BE HEELED-IN BY SETTING IN THE GROUND AND COVERING THE BALLS WITH SOIL OR MULCH AND THEN WATERING. HEMP BURLAP AND TWINE IS PREFERABLE TO TREATED. IF TREATED BURLAP IS USED, ALL TWINE IS TO BE CUT FROM AROUND THE TRUNK AND ALL BURLAP IS TO BE REMOVED.

8. PLANTS TRANSPORTED TO THE PROJECT IN OPEN VEHICLES SHALL BE COVERED WITH TARPS OR OTHER SUITABLE COVERS SECURELY FASTENED TO THE BODY OF THE VEHICLE TO PREVENT INJURY TO THE PLANTS. CLOSED VEHICLES SHALL BE ADEQUATELY VENTILATED TO PREVENT OVERHEATING OF THE PLANTS. EVIDENCE OF INADEQUATE PROTECTION FOLLOWING DIGGING, CARELESSNESS WHILE IN TRANSIT, OR IMPROPER HANDLING OR STORAGE SHALL BE CAUSE FOR REJECTION OF PLANT MATERIAL. ALL PLANTS SHALL BE KEPT MOIST, FRESH, AND PROTECTED. SUCH PROTECTION SHALL ENCOMPASS THE ENTIRE PERIOD DURING WHICH THE PLANTS ARE IN TRANSIT, BEING HANDLED, OR ARE IN TEMPORARY STORAGE. 9. ALL PLANT MATERIAL SHALL BE INSTALLED IN ACCORDANCE WITH THE CORRESPONDING LANDSCAPE PLAN AND PLANTING DETAILS.

10. LANDSCAPE CONTRACTOR SHALL MAKE BEST EFFORT TO INSTALL PLANTINGS ON THE SAME DAY AS DELIVERY. IF PLANTS ARE NOT PLANTED IMMEDIATELY ON SITE, PROPER CARE SHALL BE TAKEN TO PLACE THE PLANTINGS IN PARTIAL SHADE WHEN POSSIBLE. THE ROOT BALL SHALL BE KEPT MOIST AT ALL TIME AND COVERED WITH MOISTENED MULCH OR AGED WOODCHIPS. PROPER IRRIGATION SHALL BE SUPPLIED SO AS TO NOT ALLOW THE ROOT BALL TO DRY OUT. PLANTINGS HALL BE UNTIED AND PROPER SPACING SHALL BE ALLOTTED FOR AIR CIRCULATION AND TO PREVENT DISEASE, WILTING, AND LEAF LOSS. PLANTS THAT REMAIN UNPLANTED FOR A PERIOD OF TIME GREATER THAN THREE (3) DAYS SHALL BE HEALED IN WITH TOPSOIL OR MULCH AND WATERED AS REQUIRED TO PRESERVE ROOT MOISTURE. II. NO PLANT MATERIAL SHALL BE PLANTED IN MUDDY OR FROZEN SOIL.

12. PLANTS WITH INJURED ROOTS OR BRANCHES SHALL BE PRUNED PRIOR TO PLANTING UTILIZING CLEAN, SHARP TOOLS. ONLY DISEASED OR INJURED PLANTS SHALL BE REMOVED. 13. IF ROCK OR OTHER UNDERGROUND OBSTRUCTION IS ENCOUNTERED, THE LANDSCAPE DESIGNER RESERVES THE RIGHT TO

RELOCATE OR ENLARGE PLANTING PITS OR DELETE PLANT MATERIAL FROM THE CONTRACT. 14. IF PLANTS ARE PROPOSED WITHIN SIGHT TRIANGLES, TREES SHALL BE LIMBED AND MAINTAINED TO A HEIGHT OF EIGHT FEET (8') ABOVE GRADE, AND SHRUBS, GROUND COVER, PERENNIALS, AND ANNUALS SHALL BE MAINTAINED TO A HEIGHT NOT TO EXCEED TWO FEET (2') ABOVE GRADE UNLESS OTHERWISE NOTED OR SPECIFIED BY THE GOVERNING MUNICIPALITY OR AGENCY

15. INSTALLATION SHALL OCCUR DURING THE FOLLOWING SEASONS:

PLANTS (MARCH 15 - DECEMBER 15) LAWNS (MARCH 15 - JUNE 15 OR SEPTEMBER 1 - DECEMBER 1)

SUSCEPTIBLE TO TRANSPLANT SHO	OCK AND SHALL NOT BE PLANTED DURING THE FALL SEASON
CORNUS VARIETIES	OSTRYA VIRGINIANA
CRATAEGUS VARIETIES	PINUS NIGRA
CUPRESSOCYPARIS LEYLANDII	PLATANUS VARIETIES
FAGUS VARIETIES	POPULUS VARIETIES
HALESIA VARIETIES	PRUNUS VARIETIES
ILEX X FOSTERII	PYRUS VARIETIES
ILEX NELLIE STEVENS	QUERCUS VARIETIES (NOT Q. PALUSTRIS)
ILEX OPACA	SALIX WEEPING VARIETIES
JUNIPERUS VIRGINIANA	SORBUS VARIETIES
KOELREUTERIA PANICULATA	TAXODIUM VARIETIES
LIQUIDAMBAR VARIETIES	TAXUX B REPANDENS
LIRIODENDRON VARIETIES	TILIA TOMENTOSA VARIETIES
MALUS IN LEAF	ULMUS PARVIFOLIA VARIETIES
	CORNUS VARIETIES CRATAEGUS VARIETIES CUPRESSOCYPARIS LEYLANDII FAGUS VARIETIES HALESIA VARIETIES ILEX X FOSTERII ILEX NELLIE STEVENS ILEX OPACA JUNIPERUS VIRGINIANA KOELREUTERIA PANICULATA LIQUIDAMBAR VARIETIES LIRIODENDRON VARIETIES

NYSSA SYLVATICA ZELKOVA VARIETIES 17. IF A PROPOSED PLANT IS UNATTAINABLE OR ON THE FALL DIGGING HAZARD LIST, AN EQUIVALENT SPECIES OF THE SAME SIZE MAY BE REQUESTED FOR SUBSTITUTION OF THE ORIGINAL PLANT. ALL SUBSTITUTIONS SHALL BE APPROVED BY THE PROJECT LANDSCAPE DESIGNER OR MUNICIPAL OFFICIAL PRIOR TO ORDERING AND INSTALLATION.

18. DURING THE COURSE OF CONSTRUCTION/PLANT INSTALLATION, EXCESS AND WASTE MATERIALS SHALL BE CONTINUOUSLY AND PROMPTLY REMOVED AT THE END OF EACH WORK DAY. ALL DEBRIS, MATERIALS, AND TOOLS SHALL BE PROPERLY STORED, STOCKPILED OR DISPOSED OF AND ALL PAVED AREAS SHALL BE CLEANED.

19. THE LANDSCAPE CONTRACTOR SHALL DISPOSE OF ALL RUBBISH AND EXCESS SOIL AT HIS EXPENSE TO AN OFF-SITE LOCATION AS APPROVED BY THE LOCAL MUNICIPALITY. 20. A 90-DAY MAINTENANCE PERIOD SHALL BEGIN IMMEDIATELY AFTER ALL PLANTS HAVE BEEN SATISFACTORILY INSTALLED.

21. MAINTENANCE SHALL INCLUDE, BUT NOT BE LIMITED TO, REPLACING MULCH THAT HAS BEEN DISPLACED BY EROSION OR OTHER MEANS, REPAIRING AND RESHAPING WATER RINGS OR SAUCERS, MAINTAINING STAKES AND GUYS IF ORIGINAL REQUIRED. WATERING WHEN NEEDED OR DIRECTED, WEEDING, PRUNING, SPRAYING, FERTILIZING, MOWING THE LAWN, AND PERFORMING ANY OTHER WORK REQUIRED TO KEEP THE PLANTS IN A HEALTHY CONDITION.

2. MOW ALL GRASS AREAS AT REGULAR INTERVALS TO KEEP THE GRASS HEIGHT FROM EXCEEDING THREE INCHES (3"). MOWING SHALL BE PERFORMED ONLY WHEN GRASS IS DRY. MOWER BLADE SHALL BE SET TO REMOVE NO MORE THAN ONE THIRD (1/3) OF THE GRASS LENGTH. WHEN THE AMOUNT OF GRASS IS HEAVY, IT SHALL BE REMOVED TO PREVENT DESTRUCTION OF THE UNDERLYING TURF. MOW GRASS AREAS IN SUCH A MANNER AS TO PREVENT CLIPPINGS FROM BLOWING ON PAVED AREAS, AND SIDEWALKS. CLEANUP AFTER MOWING SHALL INCLUDE SWEEPING OR BLOWING OF PAVED AREAS AND SIDEWALKS TO CLEAR THEM FROM MOWING DEBRIS.

23. GRASSED AREAS DAMAGED DURING THE PROCESS OF THE WORK SHALL BE THE RESPONSIBILITY OF THE CONTRACTOR, WHO SHALL RESTORE THE DISTURBED AREAS TO A CONDITION SATISFACTORY TO THE PROJECT LANDSCAPE DESIGNER, MUNICIPAL OFFICIAL, OR OWNER/OWNER'S REPRESENTATIVE. THIS MAY INCLUDE FILLING TO GRADE, FERTILIZING, SEEDING, AND MULCHING

24. SHOULD THE OWNER REQUIRE MAINTENANCE BEYOND THE STANDARD 90-DAY MAINTENANCE PERIOD, A SEPARATE CONTRACT SHALL BE ESTABLISHED. 25. LANDSCAPE CONTRACTOR SHALL WATER NEW PLANTINGS FROM TIME OF INSTALL AND THROUGHOUT REQUIRED 90-DAY

MAINTENANCE PERIOD UNTIL PLANTS ARE ESTABLISHED. IF ON-SITE WATER IS NOT AVAILABLE AT THE PROJECT LOCATION, THE LANDSCAPE CONTRACTOR SHALL FURNISH IT BY MEANS OR A WATERING TRUCK OR OTHER ACCEPTABLE MANNER. 26. THE QUANTITY OF WATER APPLIED AT ONE TIME SHALL BE SUFFICIENT TO PENETRATE THE SOIL TO A MINIMUM OF EIGHT INCHES (8") IN SHRUB BEDS AND SIX INCHES (6") IN TURF AREAS AT A RATE WHICH WILL PREVENT SATURATION OF THE SOIL. 27. IF AN AUTOMATIC IRRIGATION SYSTEM HAS BEEN INSTALLED, IT CAN BE USED FOR WATERING PLANT MATERIAL. HOWEVER, FAILURE OF THE SYSTEM DOES NOT ELIMINATE THE LANDSCAPE CONTRACTOR'S RESPONSIBILITY OF PLANT HEALTH AND

PLANT MATERIAL GUARANTEE NOTES:

ESTABLISHMENT.

. THE LANDSCAPE CONTRACTOR SHALL GUARANTEE ALL PLANT MATERIAL FOR A PERIOD OF ONE YEAR (I YR.) FROM APPROVAL OF LANDSCAPE INSTALLATION BY THE PROJECT LANDSCAPE DESIGNER, MUNICIPAL OFFICIAL, OR OWNER/OWNER'S REPRESENTATIVE.

2. THE LANDSCAPE CONTRACTOR SHALL REMOVE AND REPLACE DYING, DEAD, OR DEFECTIVE PLANT MATERIAL AT HIS EXPENSE. THE LANDSCAPE CONTRACTOR SHALL ALSO BE RESPONSIBLE FOR ANY DAMAGES CAUSED BY HIS COMPANY'S OPERATIONS. 3. ALL REPLACEMENT PLANTS SHALL BE OF THE SAME SPECIES AND SIZE AS SPECIFIED ON THE APPROVED OR FINAL PLANT LIST. REPLACEMENTS RESULTING FROM REMOVAL, LOSS, OR DAMAGE DUE TO OCCUPANCY OF THE PROJECT IN ANY PART, VANDALISM, PHYSICAL DAMAGE BY ANIMALS, VEHICLES, ETC., AND LOSSES DUE TO CURTAILMENT OF WATER BY LOCAL AUTHORITIES SHALL BE APPROVED AND PAID FOR BY THE OWNER.

4. THE CONTRACTOR SHALL INSTRUCT THE OWNER AS TO THE PROPER CARE AND MAINTENANCE OF ALL PLANTINGS.

LAWN (SEED OR SOD) NOTES:

I. SEED MIXTURE SHALL BE FRESH, CLEAN, NEW CROP SEED. SOD SHALL BE STRONGLY ROOTED, UNIFORM IN THICKNESS, AND FREE OF WEEDS, DISEASE, AND PESTS

2. SEED OR SOD SHALL BE PURCHASED FROM A RECOGNIZED DISTRIBUTOR AND SHALL BE COMPOSED OF THE MIX OR BLEND WITHIN THE PROVIDED "SEED SPECIFICATION" OR "SOD SPECIFICATION."

4. SEEDING SHALL NOT BE PERFORMED IN WINDY WEATHER. IF THE SEASON OF THE PROJECT COMPLETION PROHIBITS PERMANENT STABILIZATION, TEMPORARY STABILIZATION SHALL BE PROVIDED IN ACCORDANCE WITH THE "TEMPORARY SEEDING SPECIFICATION."

5. PROTECT NEW LAWN AREAS AGAINST TRESPASSING WHILE THE SEED IS GERMINATING. FURNISH AND INSTALL FENCES, SIGNS, BARRIERS OR ANY OTHER NECESSARY TEMPORARY PROTECTIVE DEVICES. DAMAGE RESULTING FROM TRESPASS. FROSION. WASHOUT, SETTLEMENT OR OTHER CAUSES SHALL BE REPAIRED BY THE LANDSCAPE CONTRACTOR AT HIS EXPENSE. REMOVE ALL FENCES, SIGNS, BARRIERS OR OTHER TEMPORARY PROTECTIVE DEVICES ONCE LAWN HAS BEEN ESTABLISHED.

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ARTHUR KUYAN, P.E NEW JERSEY LICENSE No. 55741 LICENSED PROFESSIONAL ENGINEER

15	01/06/2023	PB RESUBMISSION
14	12/16/2022	JCMUA REVISIONS
13	11/28/2022	FOR BUILDING
10	1172072022	PERMIT
12	10/31/2022	PSEG REVISION
11	10/05/2022	PER JCMUA
	10/03/2022	COMMENTS
10	08/08/2022	PB RESUBMISSION
9	07/20/2022	REVISED DRAINAGE
8	06/20/2022	AMENDED FINAL
0	00/20/2022	SITE PLAN
7	05/12/2022	REVISED GRADING
6	04/22/2022	JCMUA REVISIONS
5	03/25/2022	JCMUA REVISIONS
4	09/03/2021	ISSUED FOR BID
3	07/02/2021	CD 90%
2	06/07/2021	CD 75%
1	04/09/2021	CD 50%
#	Date	Issue

SUMMIT TOWER

622-628 SUMMIT AVE JERSEY CITY, NEW JERSEY 07306 BLOCK 6701, LOT 21.01

Project Description

PROPOSED NEW MIXED USE BUILDING WITH 209 RESIDENTIAL UNITS


Applicant 628 SUMMIT AVE, LLC

Project Title

Project Number: T-18276 Drawn by KB Checked by : KB Scale As Noted

Sheet Title LANDSCAPING DETAILS

Sheet Number

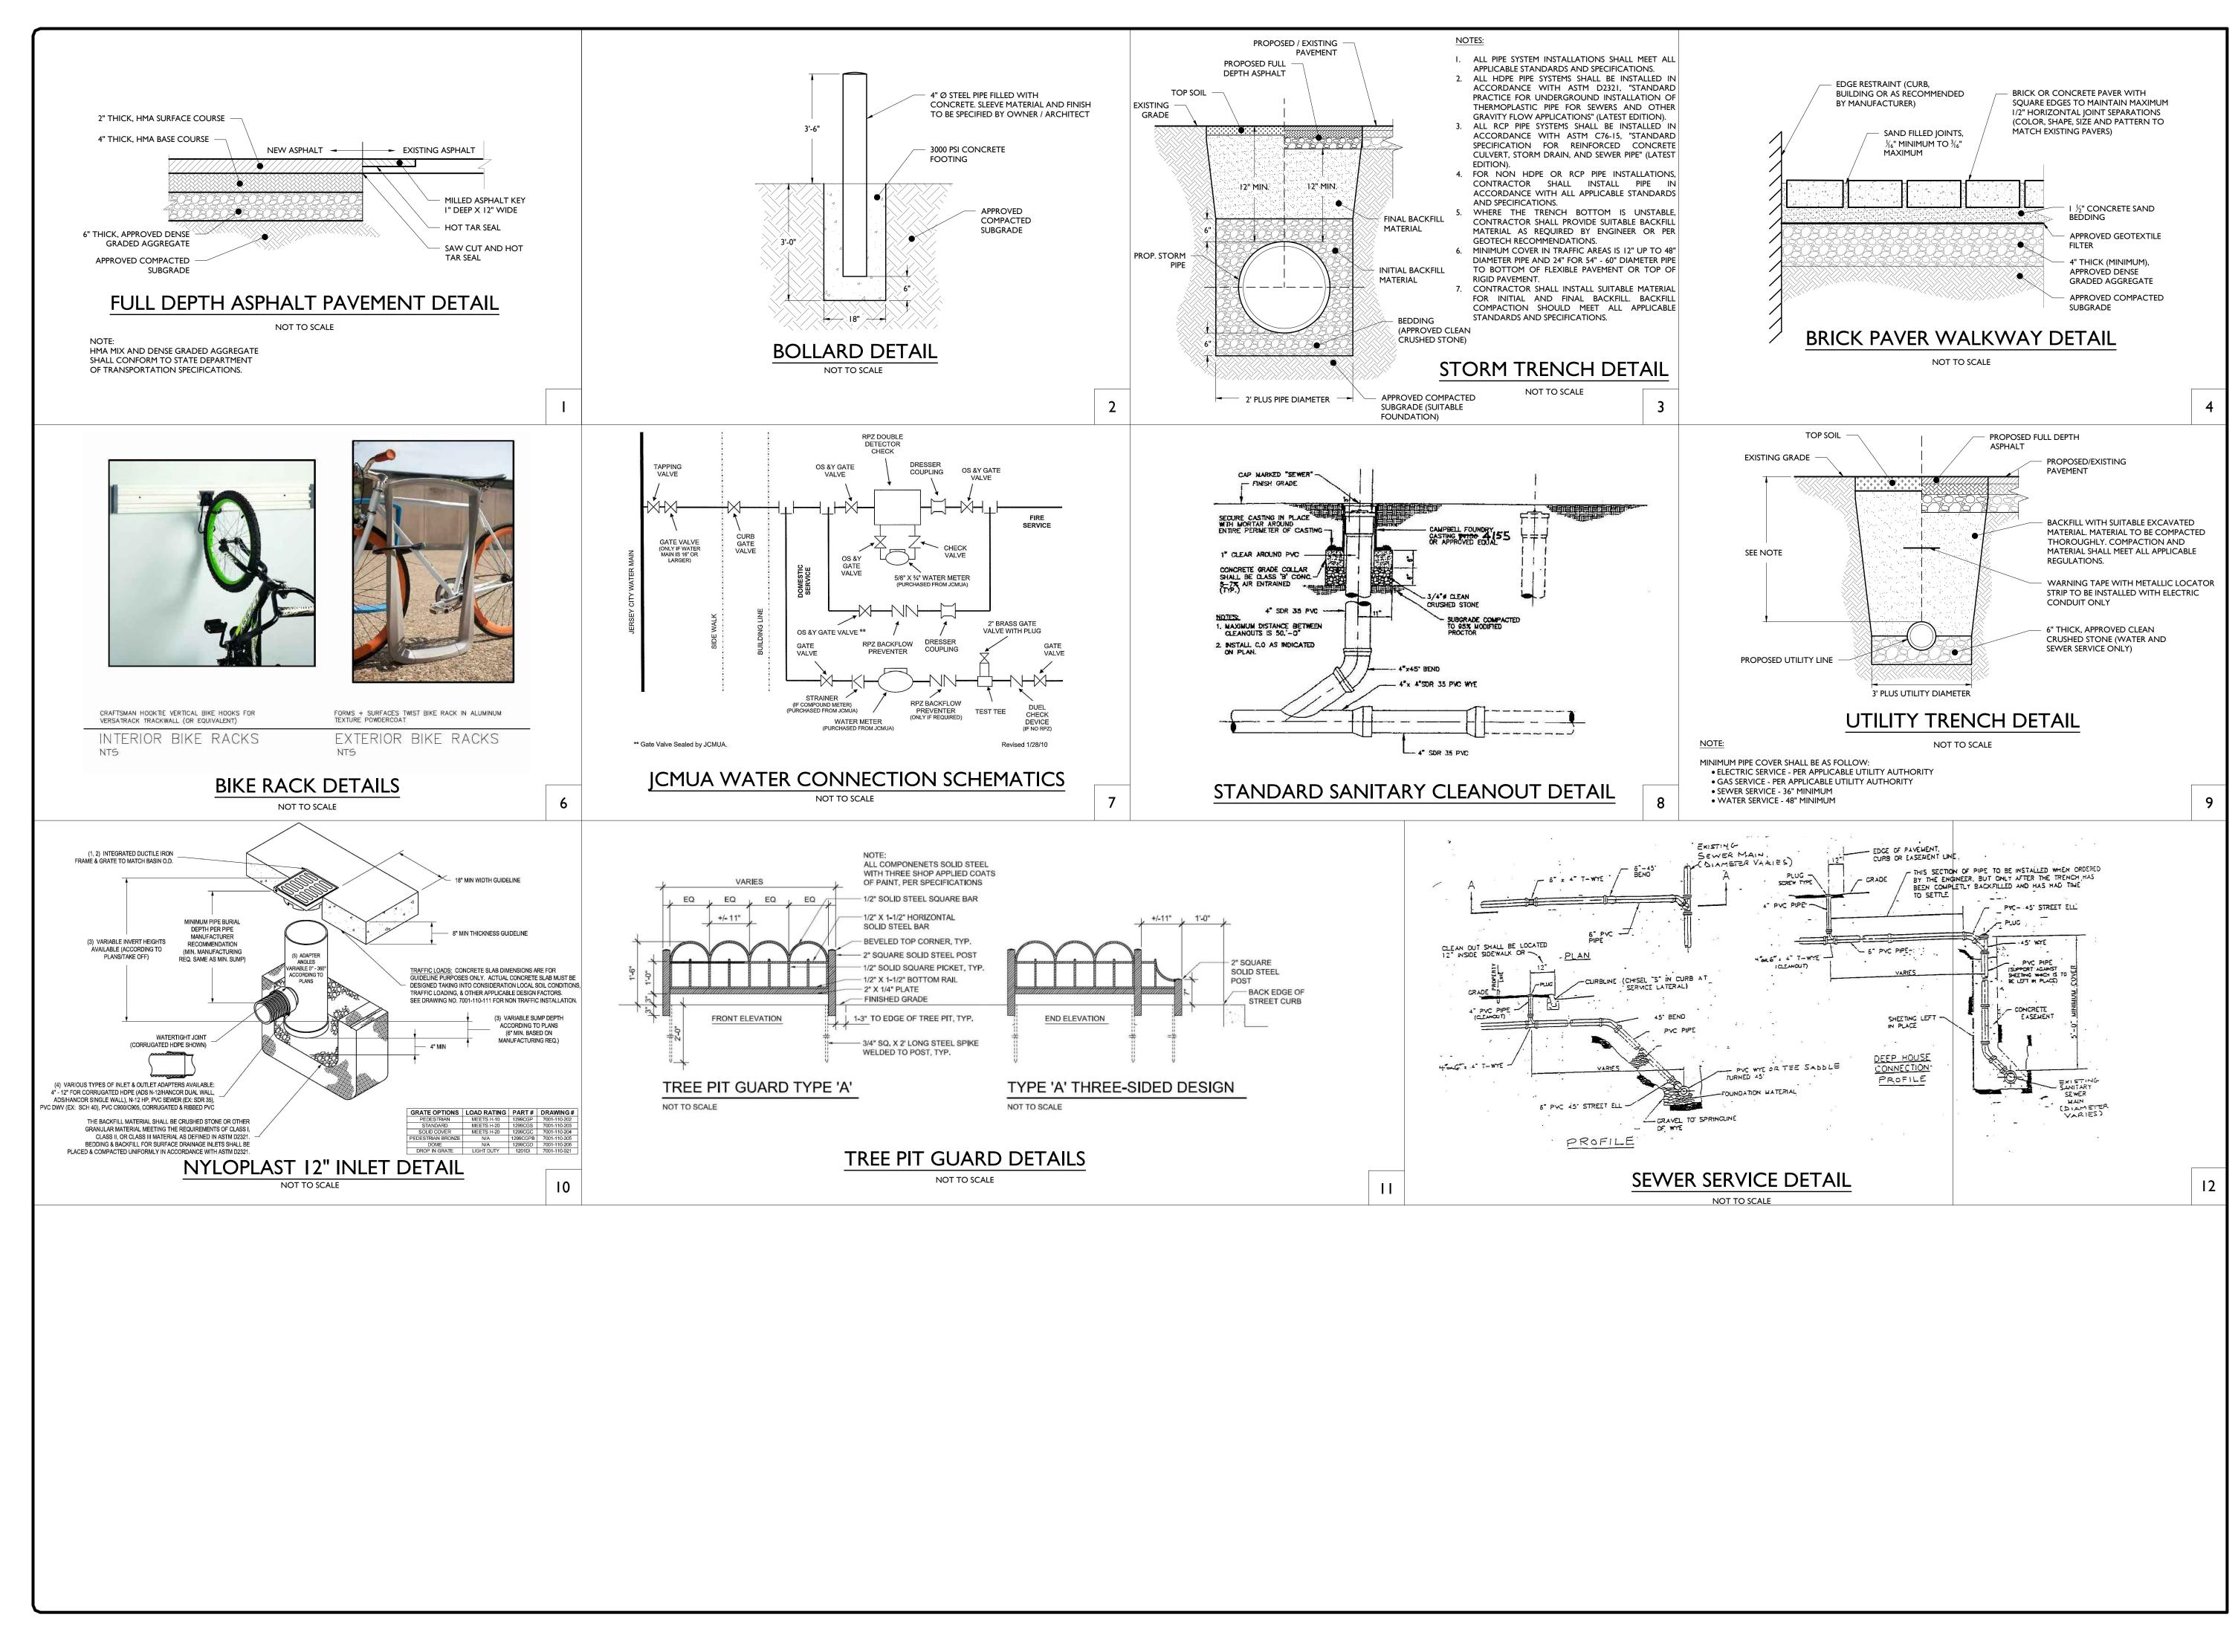

Architecture + Design 360 14th St. , Hoboken, NJ, 07030 T. 201-386-0637 E. info@mvmkarchitecture.com www.mvmkarchitecture.com SEAL Frank J. Minervini, AIA NJ License # 12576 NY License # 03 0297 63 Anthony C. Vandermark, Jr. AIA NJ License # 17698 NY License # 32710-1 Adrian Melia, AIA NJ License # 18738 Ciaran Kelly, AIA NJ License # 18866

1944 Minervini Vandermark Melia Ke



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ARTHUR KUYAN, P.E. NEW JERSEY LICENSE No. 55741 LICENSED PROFESSIONAL ENGINEER

15	01/06/2023	PB RESUBMISSION
14	12/16/2022	JCMUA REVISIONS
13	11/28/2022	FOR BUILDING
10	1172072022	PERMIT
12	10/31/2022	PSEG REVISION
11	10/05/2022	PER JCMUA
	10,00,2022	COMMENTS
10	08/08/2022	PB RESUBMISSION
9	07/20/2022	REVISED DRAINAG
8	06/20/2022	AMENDED FINAL
<u> </u>	00,20,2022	SITE PLAN
7	05/12/2022	REVISED GRADING
6	04/22/2022	JCMUA REVISIONS
5	03/25/2022	JCMUA REVISIONS
4	09/03/2021	ISSUED FOR BID
3	07/02/2021	CD 90%
2	06/07/2021	CD 75%
1	04/09/2021	CD 50%
#	Date	Issue

SUMMIT TOWER


622-628 SUMMIT AVE JERSEY CITY, NEW JERSEY 07306 BLOCK 6701, LOT 21.01


Project Description PROPOSED NEW MIXED USE BUILDING WITH 209 RESIDENTIAL UNITS

Applicant 628 SUMMIT AVE, LLC


Project Number :T-18276Drawn by:KBChecked by:KBScale:As Noted

Sheet Title CONSTRUCTION DETAILS

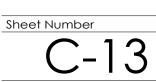

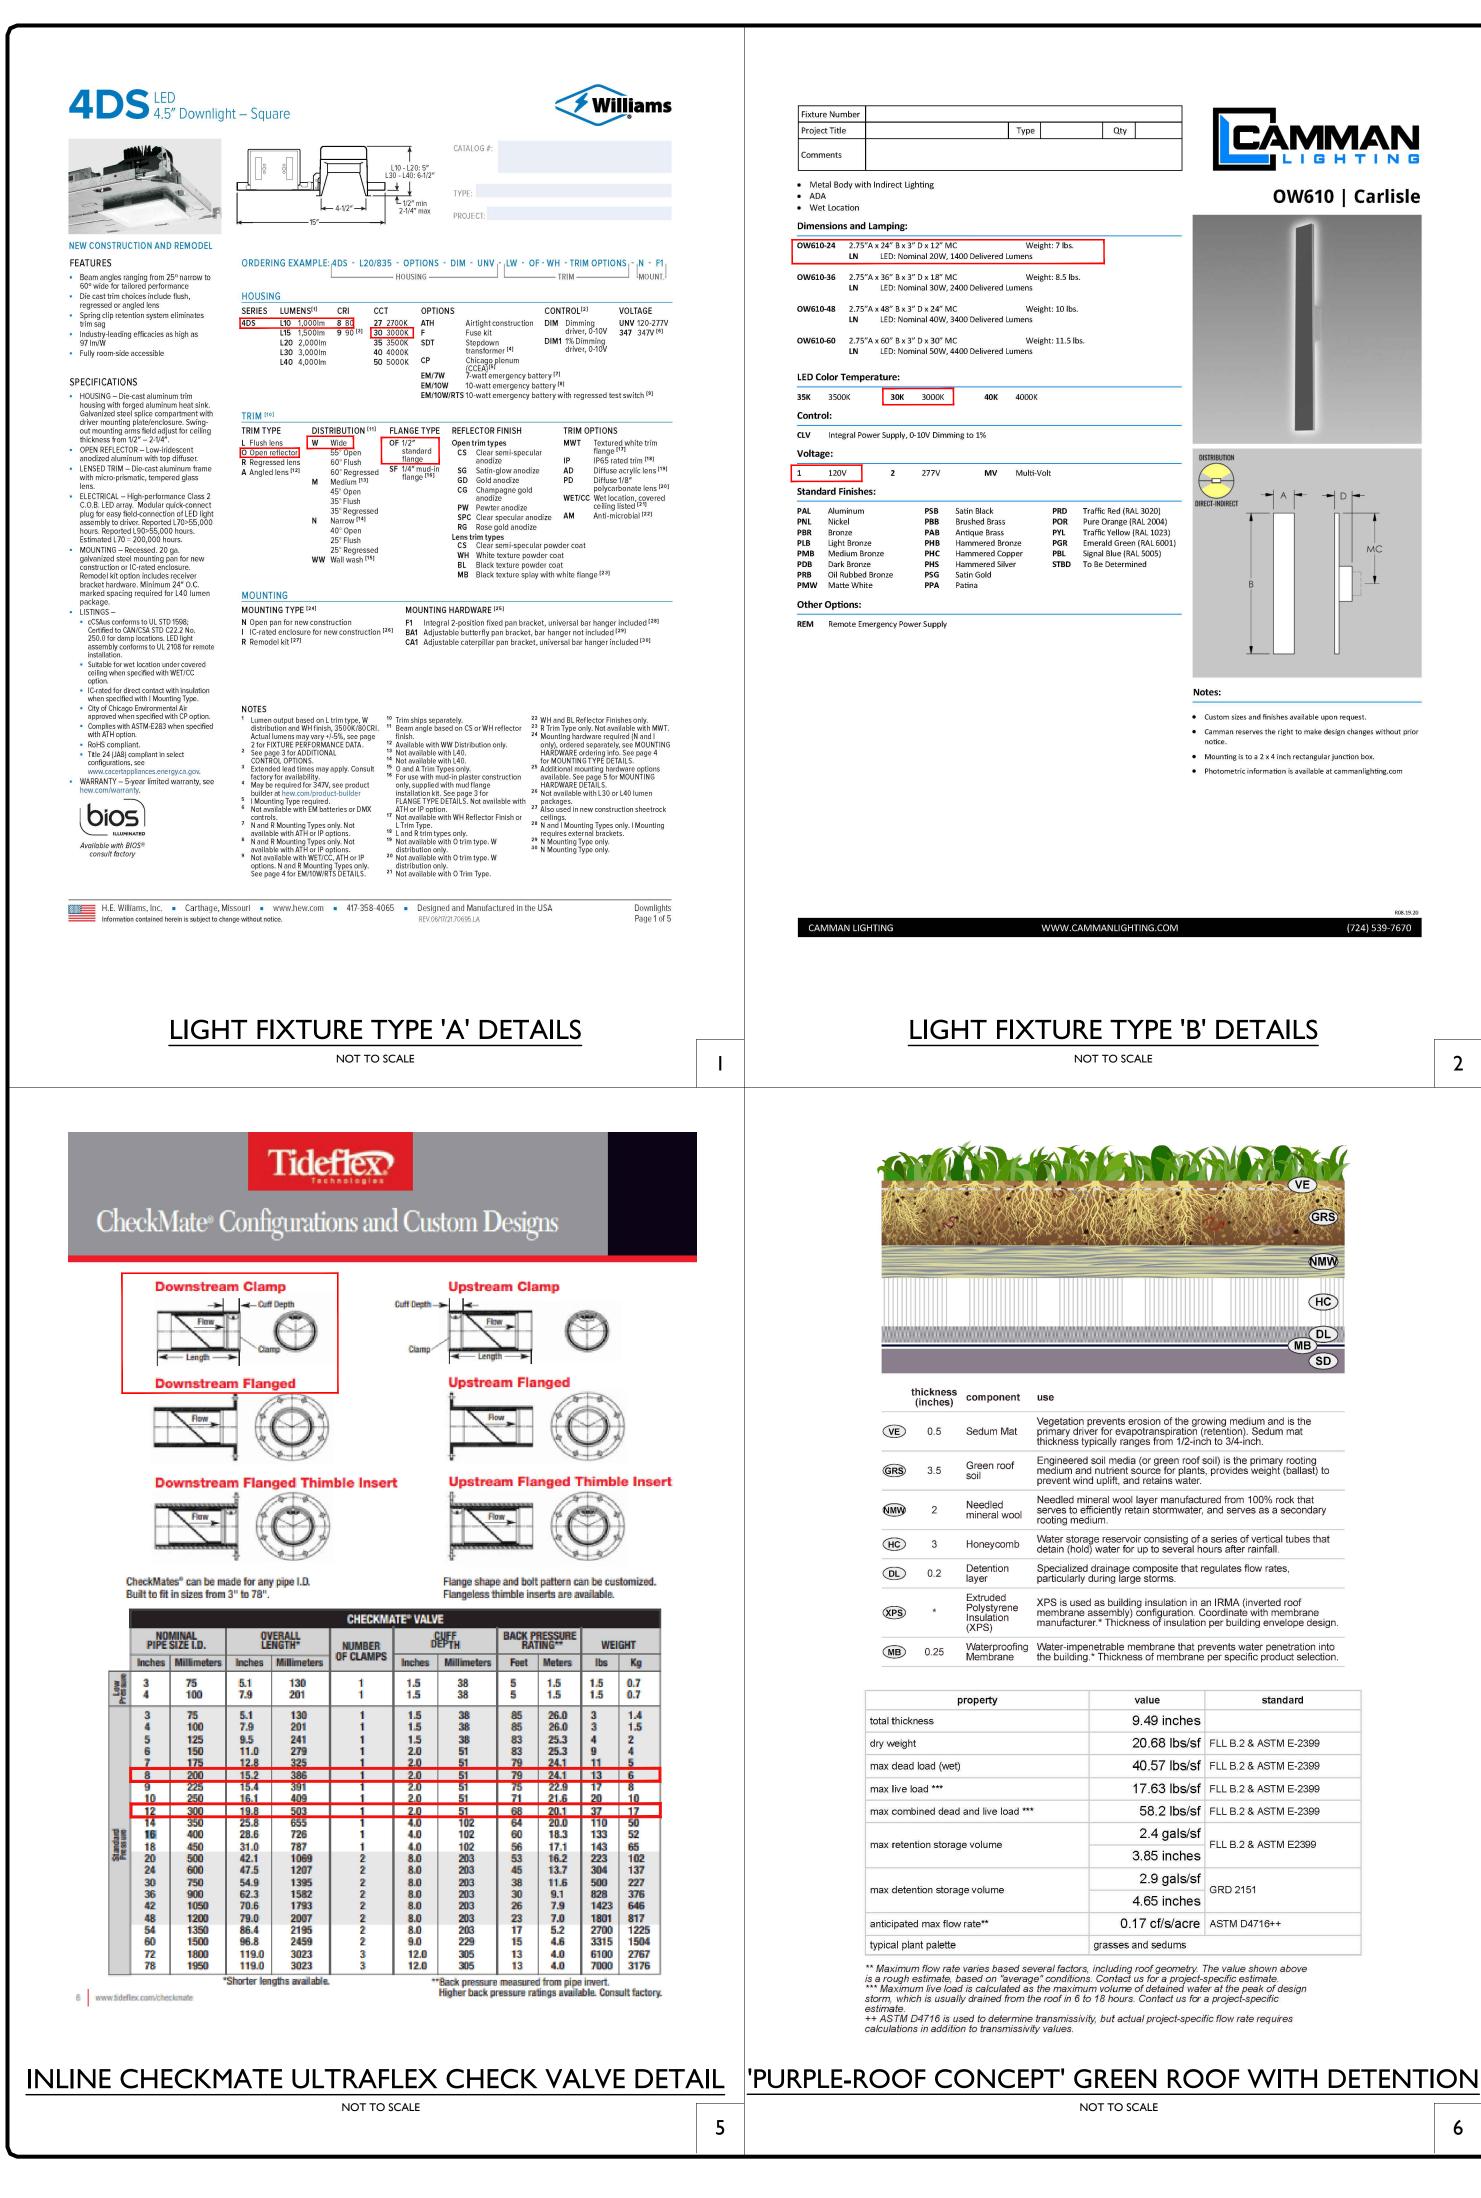

Fixture	Number	-						
Project	t Title					Туре		
Comm	ents							
ADAWet	al Body wit Location sions and			hting				
OW610-	24 2.75 LN			D x 12" M inal 20W,	IC 1400 Delivered L		ht: 7 lbs.	
OW610-	36 2.75 LN			D x 18" M inal 30W, 1	IC 2400 Delivered L		ht: 8.5 lb:	š.
OW610-	48 2.75 LN			D x 24" M inal 40W, 1	IC 3400 Delivered L		ht: 10 lbs	
OW610-	60 2.75 LN			D x 30" M inal 50W, 4	IC 4400 Delivered L		ht: 11.5 ll	3 5.
LED Co	lor Temp	erat	ure:					
35K	3500K		30K	3000K	40K	4000K		
Contro	l:				-			
CLV	Integral Po	wer	Supply, 0	-10V Dimn	ning to 1%			
Voltage	e:							
1	120V		2	277V	MV	Multi-V	olt	
	rd Finish	00.						
								_
PAL PNL	Aluminum Nickel			PSB PBB	Satin Black Brushed Brass		PRD POR	Traf Pure
PBR	Bronze			PAB	Antique Brass		PYL	Traf
PLB	Light Bron	ze		PHB	Hammered Bro	nze	PGR	Eme
PMB	Medium B		•	PHC	Hammered Cop		PBL	Sigr
PDB	Dark Bronz			PHS	Hammered Silv	er	STBD	To E
PRB PMW	Oil Rubbed Matte Whi		nze	PSG PPA	Satin Gold Patina			
Other (Options:							

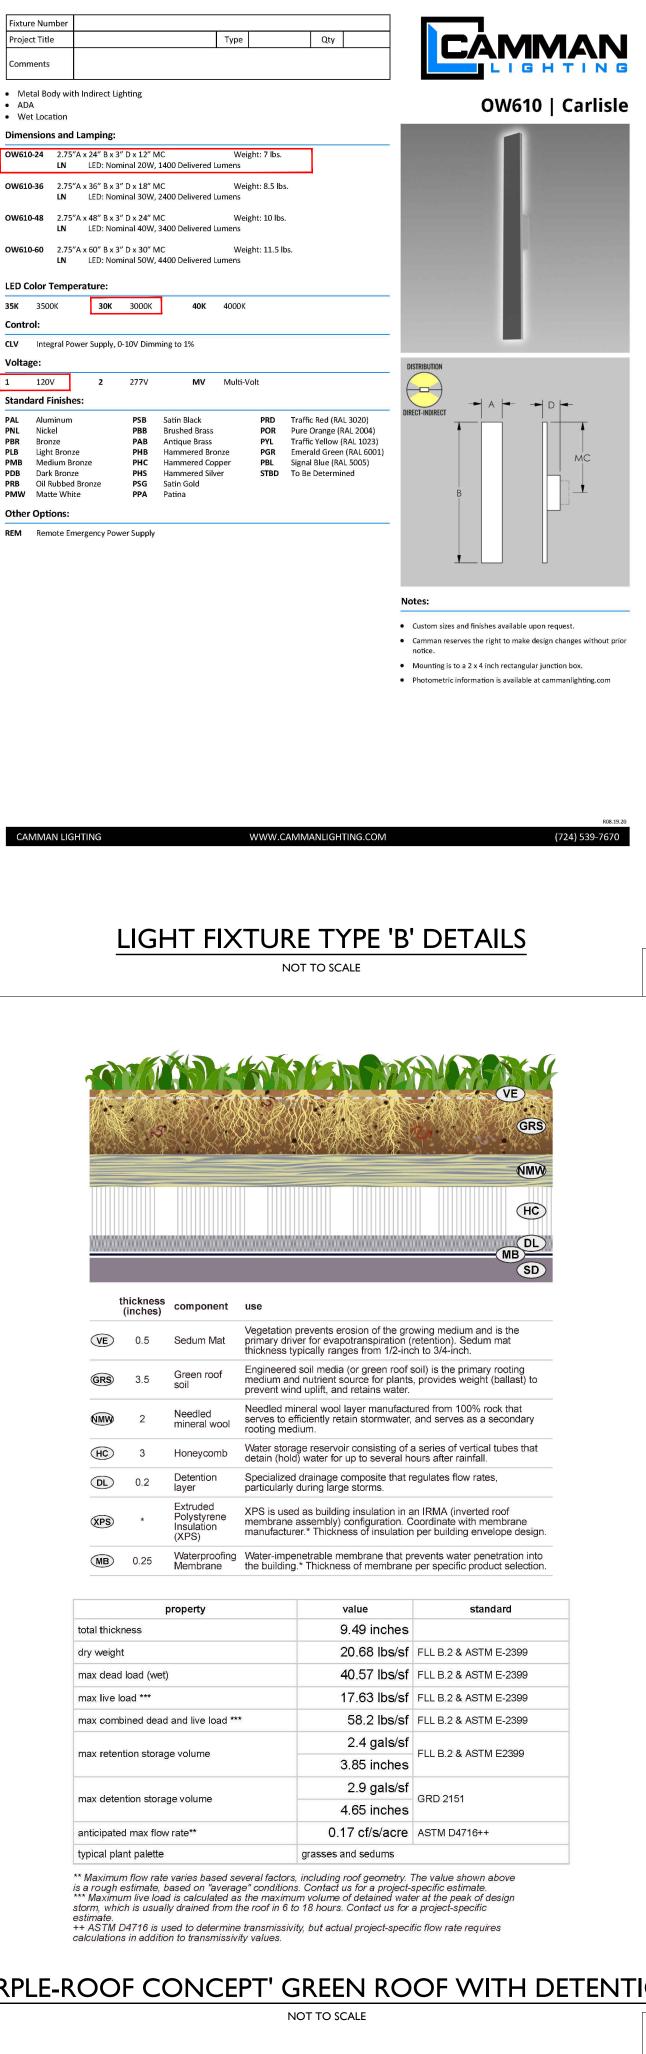


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6

9	-	mineral wool	rooting mediu
\geq	3	Honeycomb	Water storage detain (hold) v
.)	0.2	Detention layer	Specialized dr particularly du
S	*	Extruded Polystyrene Insulation (XPS)	XPS is used a membrane as manufacturer.
3)	0.25	Waterproofing Membrane	Water-impene the building.*

property	
otal thickness	
dry weight	
max dead load (wet)	
max live load ***	
max combined dead and live load ***	
nax retention storage volume	
nax detention storage volume	
anticipated max flow rate**	
ypical plant palette	ç
ypical plant palette Maximum flow rate varies based several fa a rough estimate, based on "average" cond * Maximum live load is calculated as the ma form, which is usually drained from the roof stimate. + ASTM D4716 is used to determine transm alculations in addition to transmissivity value	nctors, i ditions. aximum in 6 to nissivity

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CITY OF JERSEY CITY TYPE 'C' LIGHT DETAIL

NOT TO SCALE

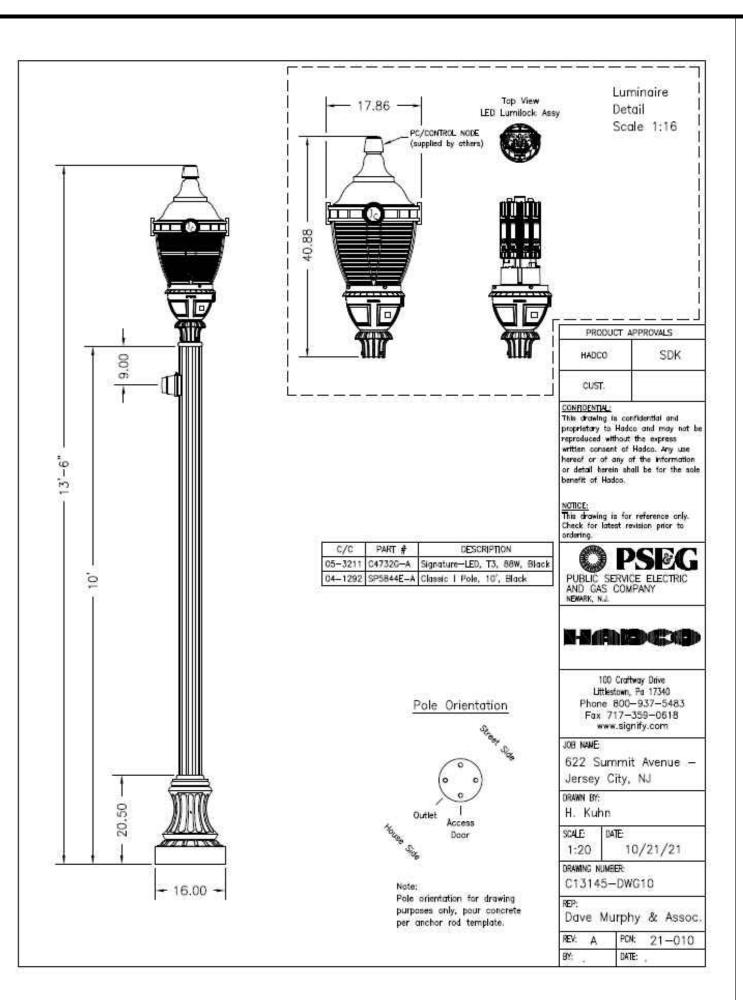3

(PV) thickness component use

	(inches)	component	use
PV	3	Pavers	Pedestrian pavers, such as precast concrete, teak, or porcelain.
PP	1	Paver Pedestals	Pedestals to support pedestrian pavers. Coordinate with paver manufacturer.
NMW)	2	Needled mineral wool	Needled mineral wool layer manufactured from 100% rock that serves to efficiently retain stormwater, and serves as a secondary rooting medium.
НС	3	Honeycomb	Water storage reservoir consisting of a series of vertical tubes that detain (hold) water for up to several hours after rainfall.
	0.2	Detention layer	Specialized drainage composite that regulates flow rates, particularly during large storms.
XPS	*	Extruded Polystyrene Insulation (XPS)	XPS is used as building insulation in an IRMA (inverted roof membrane assembly) configuration. Coordinate with membrane manufacturer.* Thickness of insulation per building envelope design.
MB	0.25	Waterproofing Membrane	Water-impenetrable membrane that prevents water penetration into the building.* Thickness of membrane per specific product selection.


thickr	ness		9.49 inches	
		property	value	standard
MB	0.25	Waterproofing Membrane	Water-impenetrable membrane that pro- the building.* Thickness of membrane	
PS	*	Extruded Polystyrene Insulation (XPS)	XPS is used as building insulation in a membrane assembly) configuration. Co manufacturer.* Thickness of insulation	pordinate with membrane
DL	0.2	Detention layer	Specialized drainage composite that reparticularly during large storms.	egulates flow rates,
HC	3	Honeycomb	Water storage reservoir consisting of a detain (hold) water for up to several ho	
			rooting medium.	

property	value	standard	
total thickness	9.49 inches		
dry weight	25.21 lbs/sf	FLL B.2 & ASTM E-2399	
max dead load (wet)	34.73 lbs/sf	FLL B.2 & ASTM E-2399	
max live load ***	15.26 lbs/sf	FLL B.2 & ASTM E-2399	
max combined dead and live load ***	49.99 lbs/sf	FLL B.2 & ASTM E-2399	
	1.1 gals/sf		
max retention storage volume	1.76 inches	FLL B.2 & ASTM E2399	
	2.1 gals/sf	CPD 2151	
max detention storage volume	3.37 inches	GRD 2151	
anticipated max flow rate**	0.17 cf/s/acre	ASTM D4716++	
typical plant palette	mosses	1	

estimate. ++ ASTM D4716 is used to determine transmissivity, but actual project-specific flow rate requires calculations in addition to transmissivity values.

'PURPLE-ROOF CONCEPT' DETENTION PAVER

NOT TO SCALE

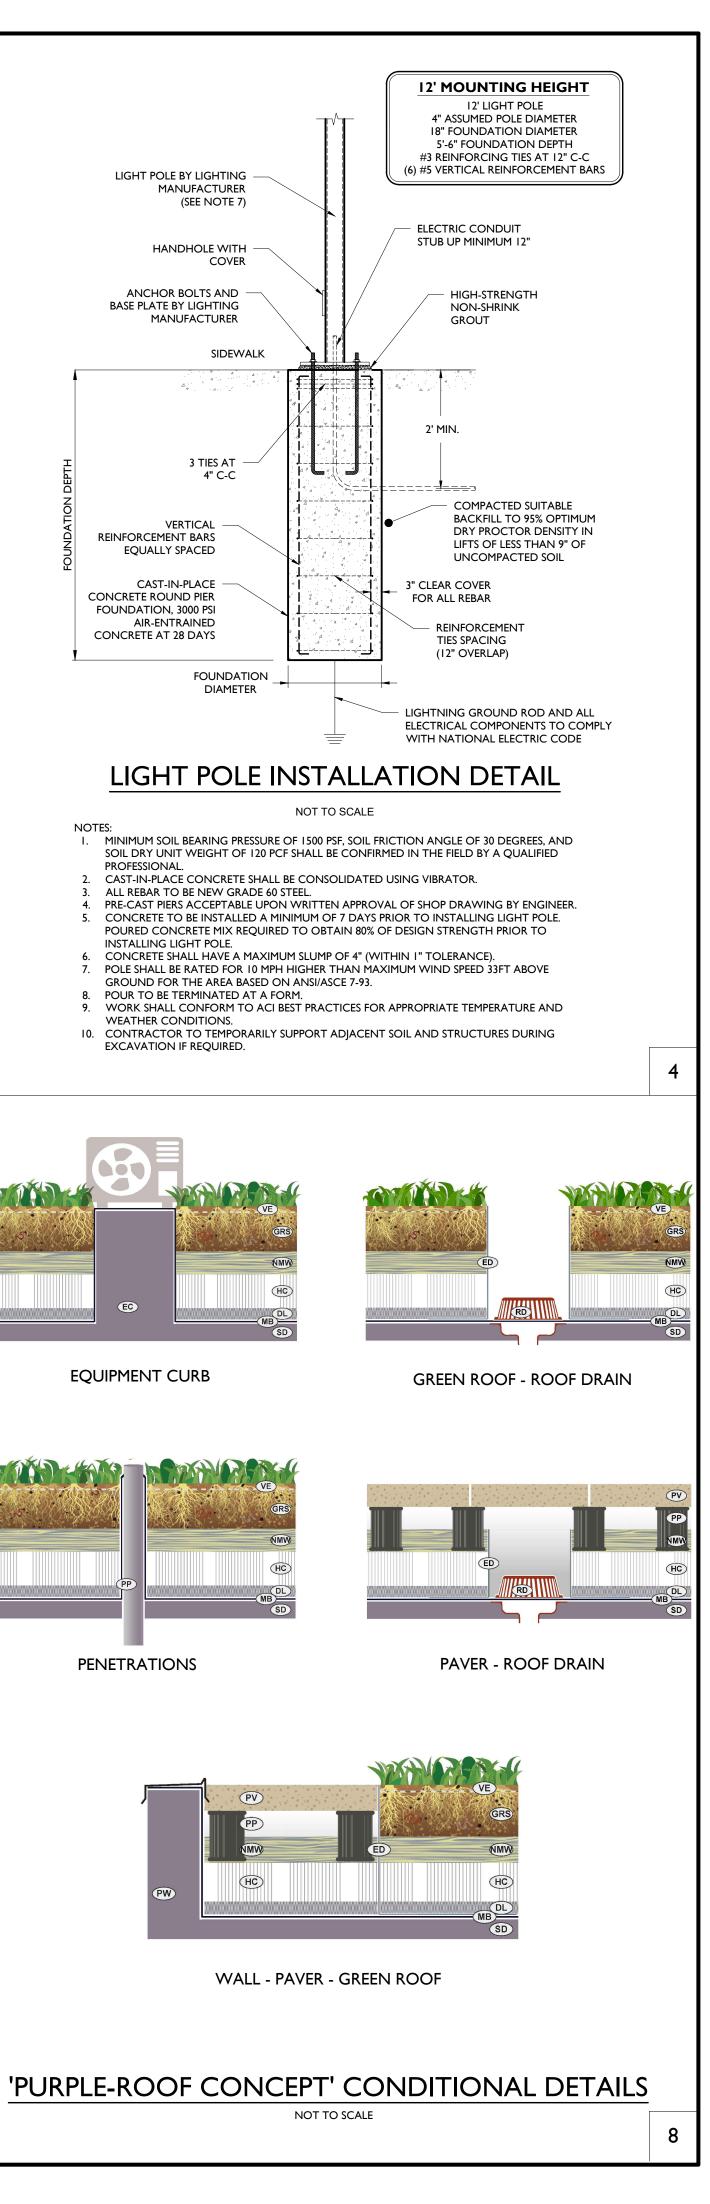

1944 Melia Kel Architecture + Design 360 14th St. , Hoboken, NJ, 07030 T. 201-386-0637 E. info@mvmkarchitecture.com www.mvmkarchitecture.com SEAL Frank J. Minervini, AIA NJ License # 12576 NY License # 03 0297 63 Anthony C. Vandermark, Jr. AIA NJ License # 17698 NY License # 32710-1 Adrian Melia, AlA NJ License # 18738 Ciaran Kelly, AIA NJ License # 18866 engineering & design Rutherford, NJ · New York, NY Princeton, NJ \cdot Tampa, FL \cdot Detroit, MI www.stonefieldeng.com Headquarters: 92 Park Avenue, Rutherford, NJ 07070 Phone 201.340.4468 · Fax 201.340.4472 ARTHUR KUYAN, P.E. NEW JERSEY LICENSE No. 55741 LICENSED PROFESSIONAL ENGINEER

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	Date	Issue

SUMMIT TOWER

622-628 SUMMIT AVE JERSEY CITY, NEW JERSEY 07306 BLOCK 6701, LOT 21.01

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Applicant


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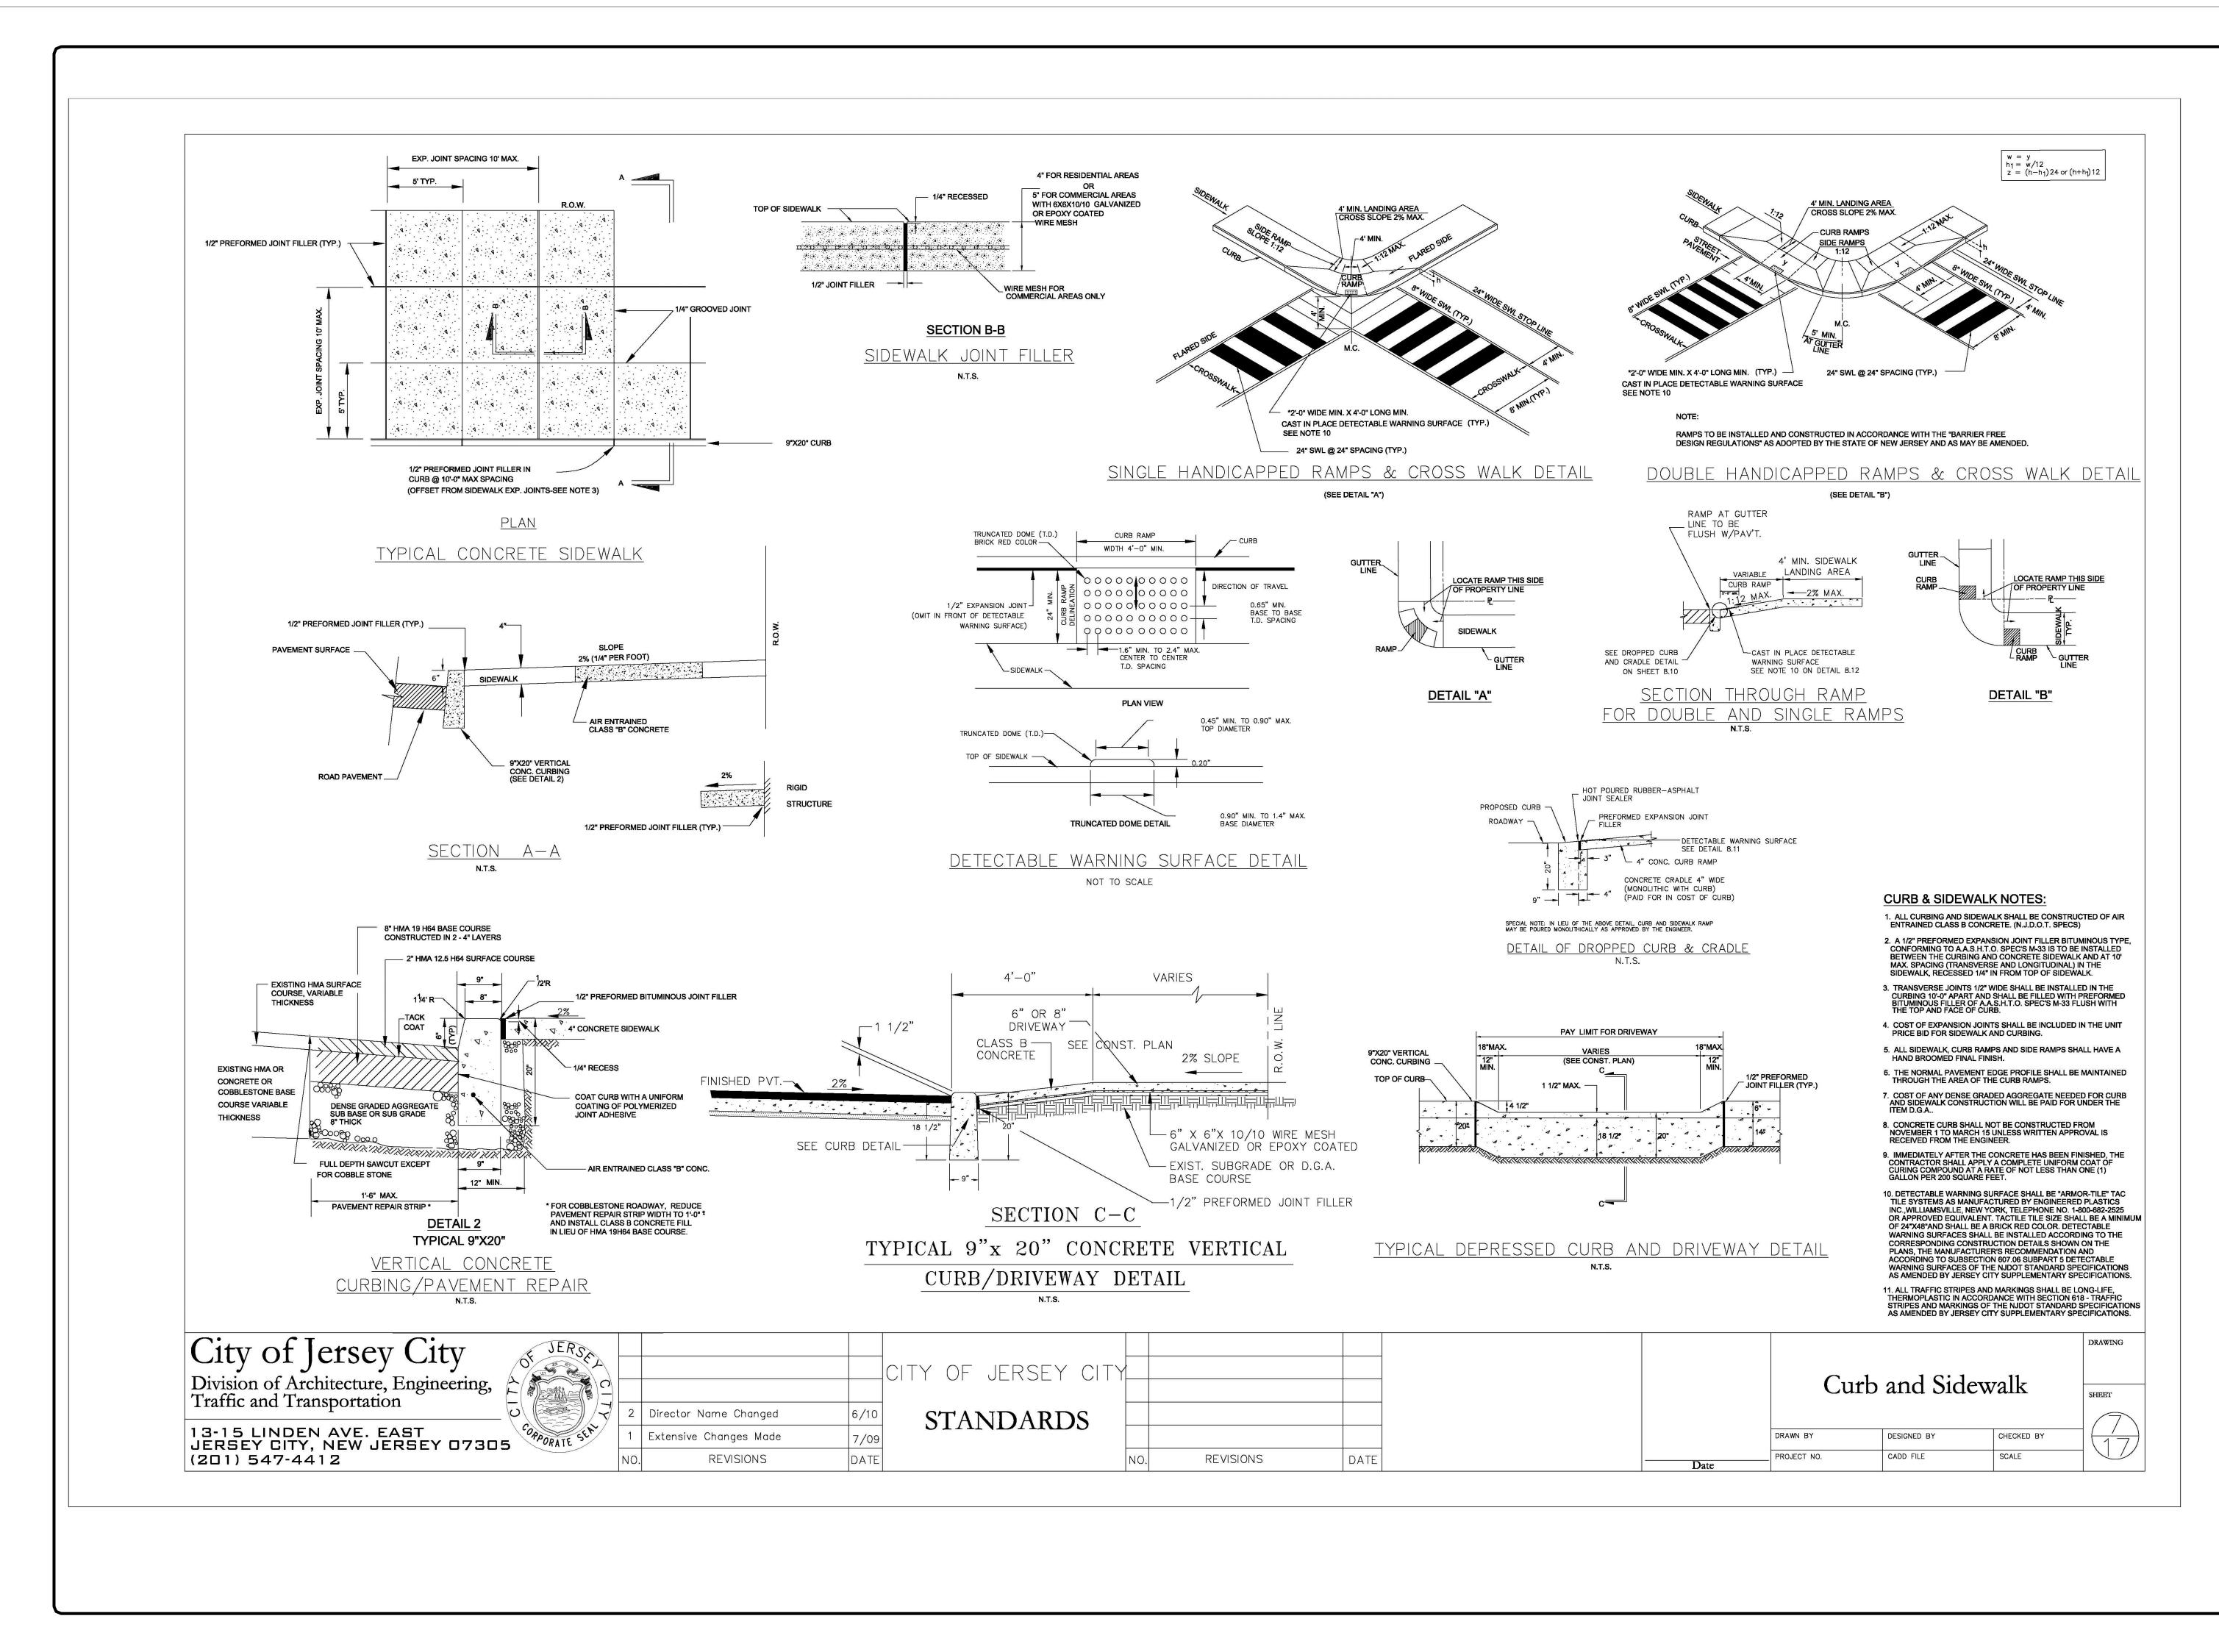
As Noted

Scale Sheet Title

628 SUMMIT AVE, LLC

CONSTRUCTION DETAILS




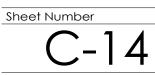

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C	I License # 18738 iaran Kelly, A J License # 18866	IA
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		KUYAN, P.E. / LICENSE No. 55741
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		JCMUA REVISIONS FOR BUILDING PERMIT PSEG REVISION
14 13 12 11	12/16/2022 11/28/2022 10/31/2022 10/05/2022	JCMUA REVISIONS FOR BUILDING PERMIT PSEG REVISION PER JCMUA COMMENTS
14 13 12 11 10 9	12/16/2022 11/28/2022 10/31/2022 10/05/2022 08/08/2022 07/20/2022	JCMUA REVISIONS FOR BUILDING PERMIT PSEG REVISION PER JCMUA COMMENTS PB RESUBMISSION
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14 13 12 11 10 9 8 7 6	12/16/2022 11/28/2022 10/31/2022 10/05/2022 08/08/2022 07/20/2022 06/20/2022 05/12/2022 04/22/2022	JCMUA REVISION FOR BUILDING PERMIT PSEG REVISION PER JCMUA COMMENTS PB RESUBMISSION REVISED DRAINAC AMENDED FINAL SITE PLAN REVISED GRADING JCMUA REVISION
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14 13 12 11 10 9 8 7 6 5 4 3 2 1 10 9 8 7 6 5 4 3 2 1 # Pro BUI App 628 Pro Ct Sc She	12/16/2022 11/28/2022 10/031/2022 00/05/2022 08/08/2022 07/20/2022 06/20/2022 05/12/2022 04/22/2022 04/22/2022 04/22/2022 04/22/2022 04/22/2022 04/22/2022 04/22/2022 04/09/2021 04/00	JCMUA REVISIONS FOR BUILDING PERMIT PSEG REVISION PER JCMUA COMMENTS PB RESUBMISSION REVISED DRAINAG AMENDED FINAL SITE PLAN REVISED GRADING JCMUA REVISIONS JCMUA REVISIONS ISSUED FOR BID CD 90% CD 75% CD 50% ISSUE CD 50% ISSUE FORVER AVE W JERSEY 07306 T21.01 tion V MIXED USE 209 RESIDENTIAL UN E, LLC er : T-18276 : KB : KB : KB
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C-15




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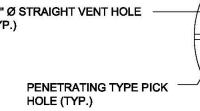
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6/10	STANDARDS				
7/09					
DATE		NO.	REVISIONS	DATE	

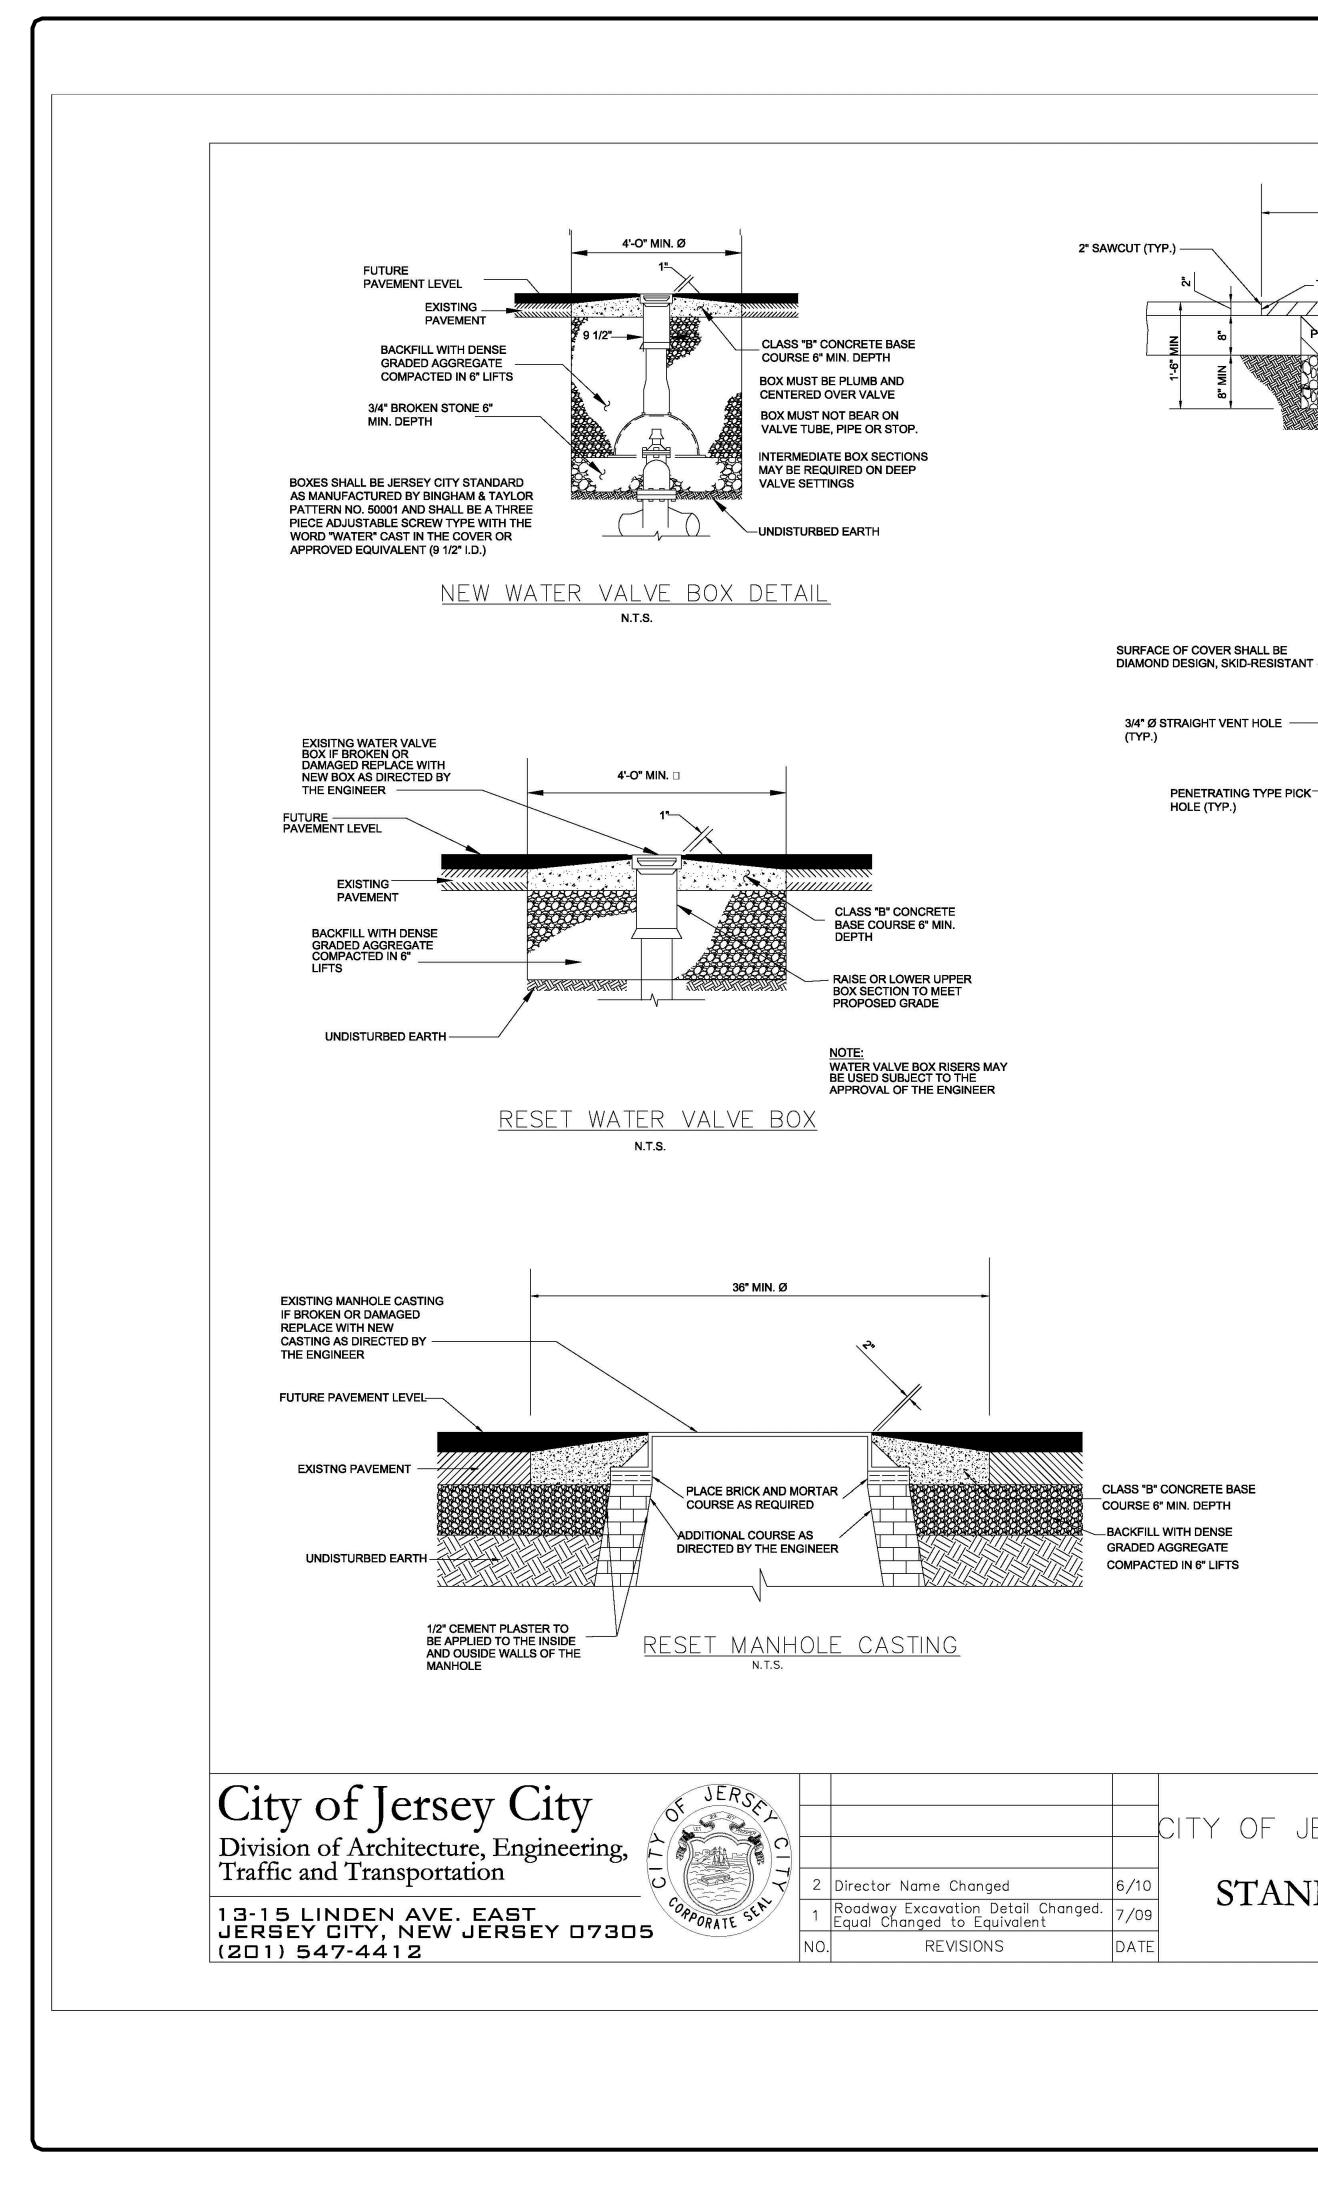

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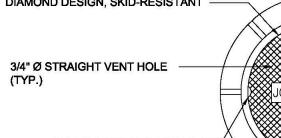
<u>SECTION</u>



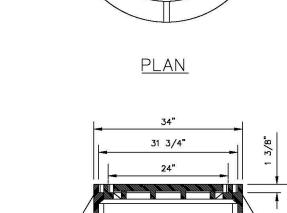

XJCMUA SEWER

<u>Plan</u>



IF FULL WIDTH MILLING AND PAVING IS NOT INCLUDED IN THE PROJECT, **REPAIR WIDTH AND LENGTH (MILLING &** PAVING) TO BE A MINIMUM OF 3' PAST

TRENCH OPENNING OR AS DETERMINED BY THE

- DENSE GRADED ADDREGATE BASE COURSE

ROADWAY EXCAVATION,

HOT MIX ASPHALT PAVEMENT REPAIR


N.T.S.

UNCLASSIFIED PAY LIMITS

HOT MIX ASPHALT 19464 BASE COURSE, CONSTRUCTED IN 2 FOUR INCHLIPTS

ENGINEER OR AS SHOWN ON THE PLANS


- TACK COAT

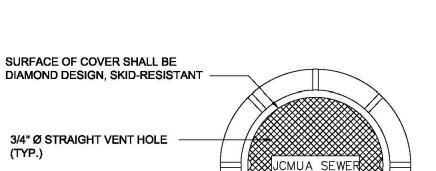

STANDARD J.C.M.U.A.

MANHOLE FRAME AND COVER

(FOR EXISTING MANHOLE CASTING REPLACEMENT ON MANHOLES WITH 24" OPENING)

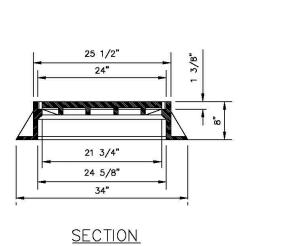

FINISHED SUBGRADE

- HOT MIX ASPHALT 12.5H64 OR 76 SURFACE COURSE

UNDISTURBED SUITABLE SOIL

TO BE DETERMINED BY THE

ENGINEER

EXIST. PAVEMENT

(TYPE & DEPTH VARIES

PROPOSED

PROPOSED GRADE

EXISTING GRADE


CUT LINE


LIMIT OF EXIST.


J.B. REMOVAL


#4 @ 12" DOWELS (TIE TO EXIST.

REINFORCEMENT AS REQ'D.)

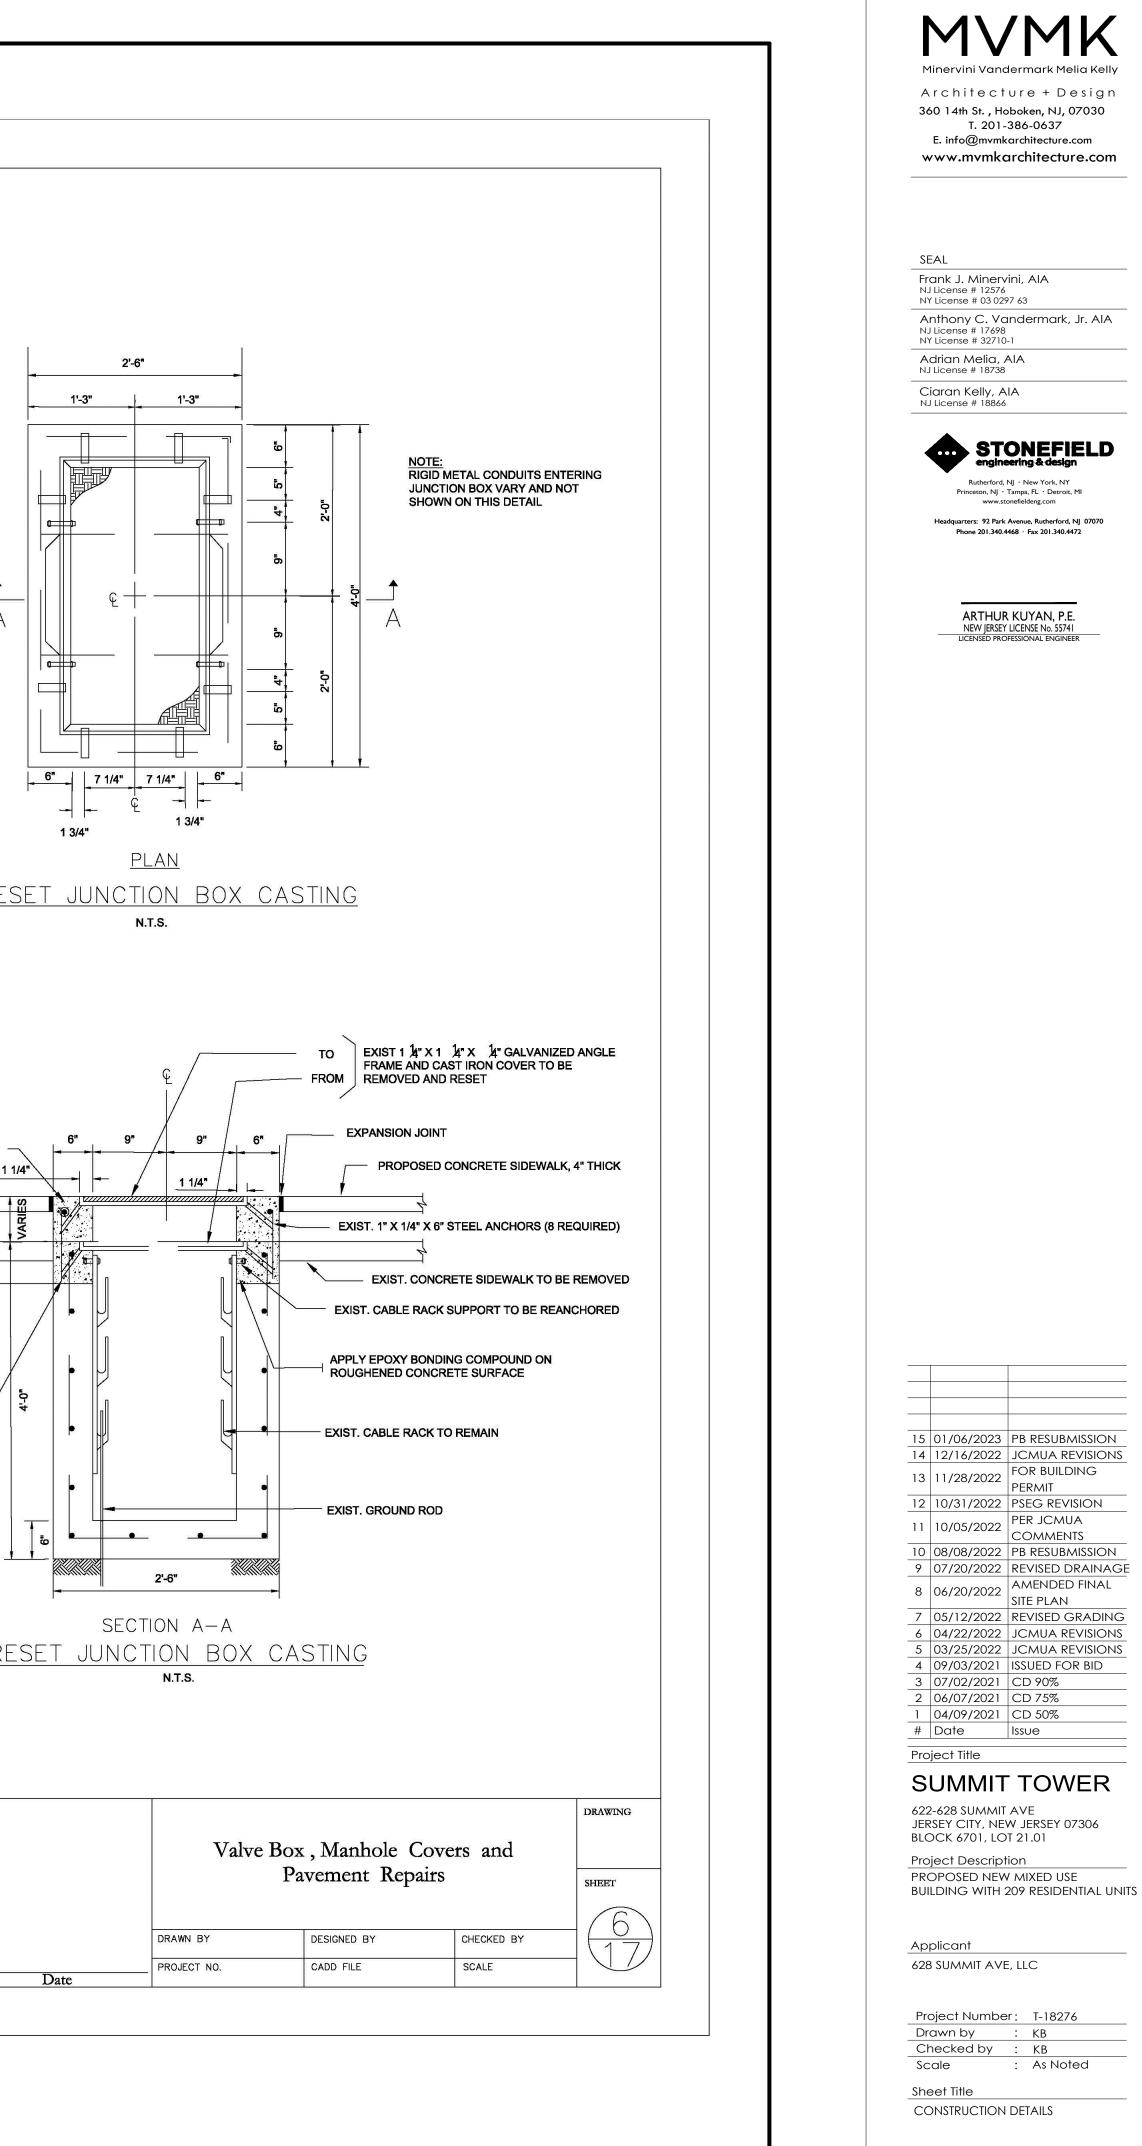

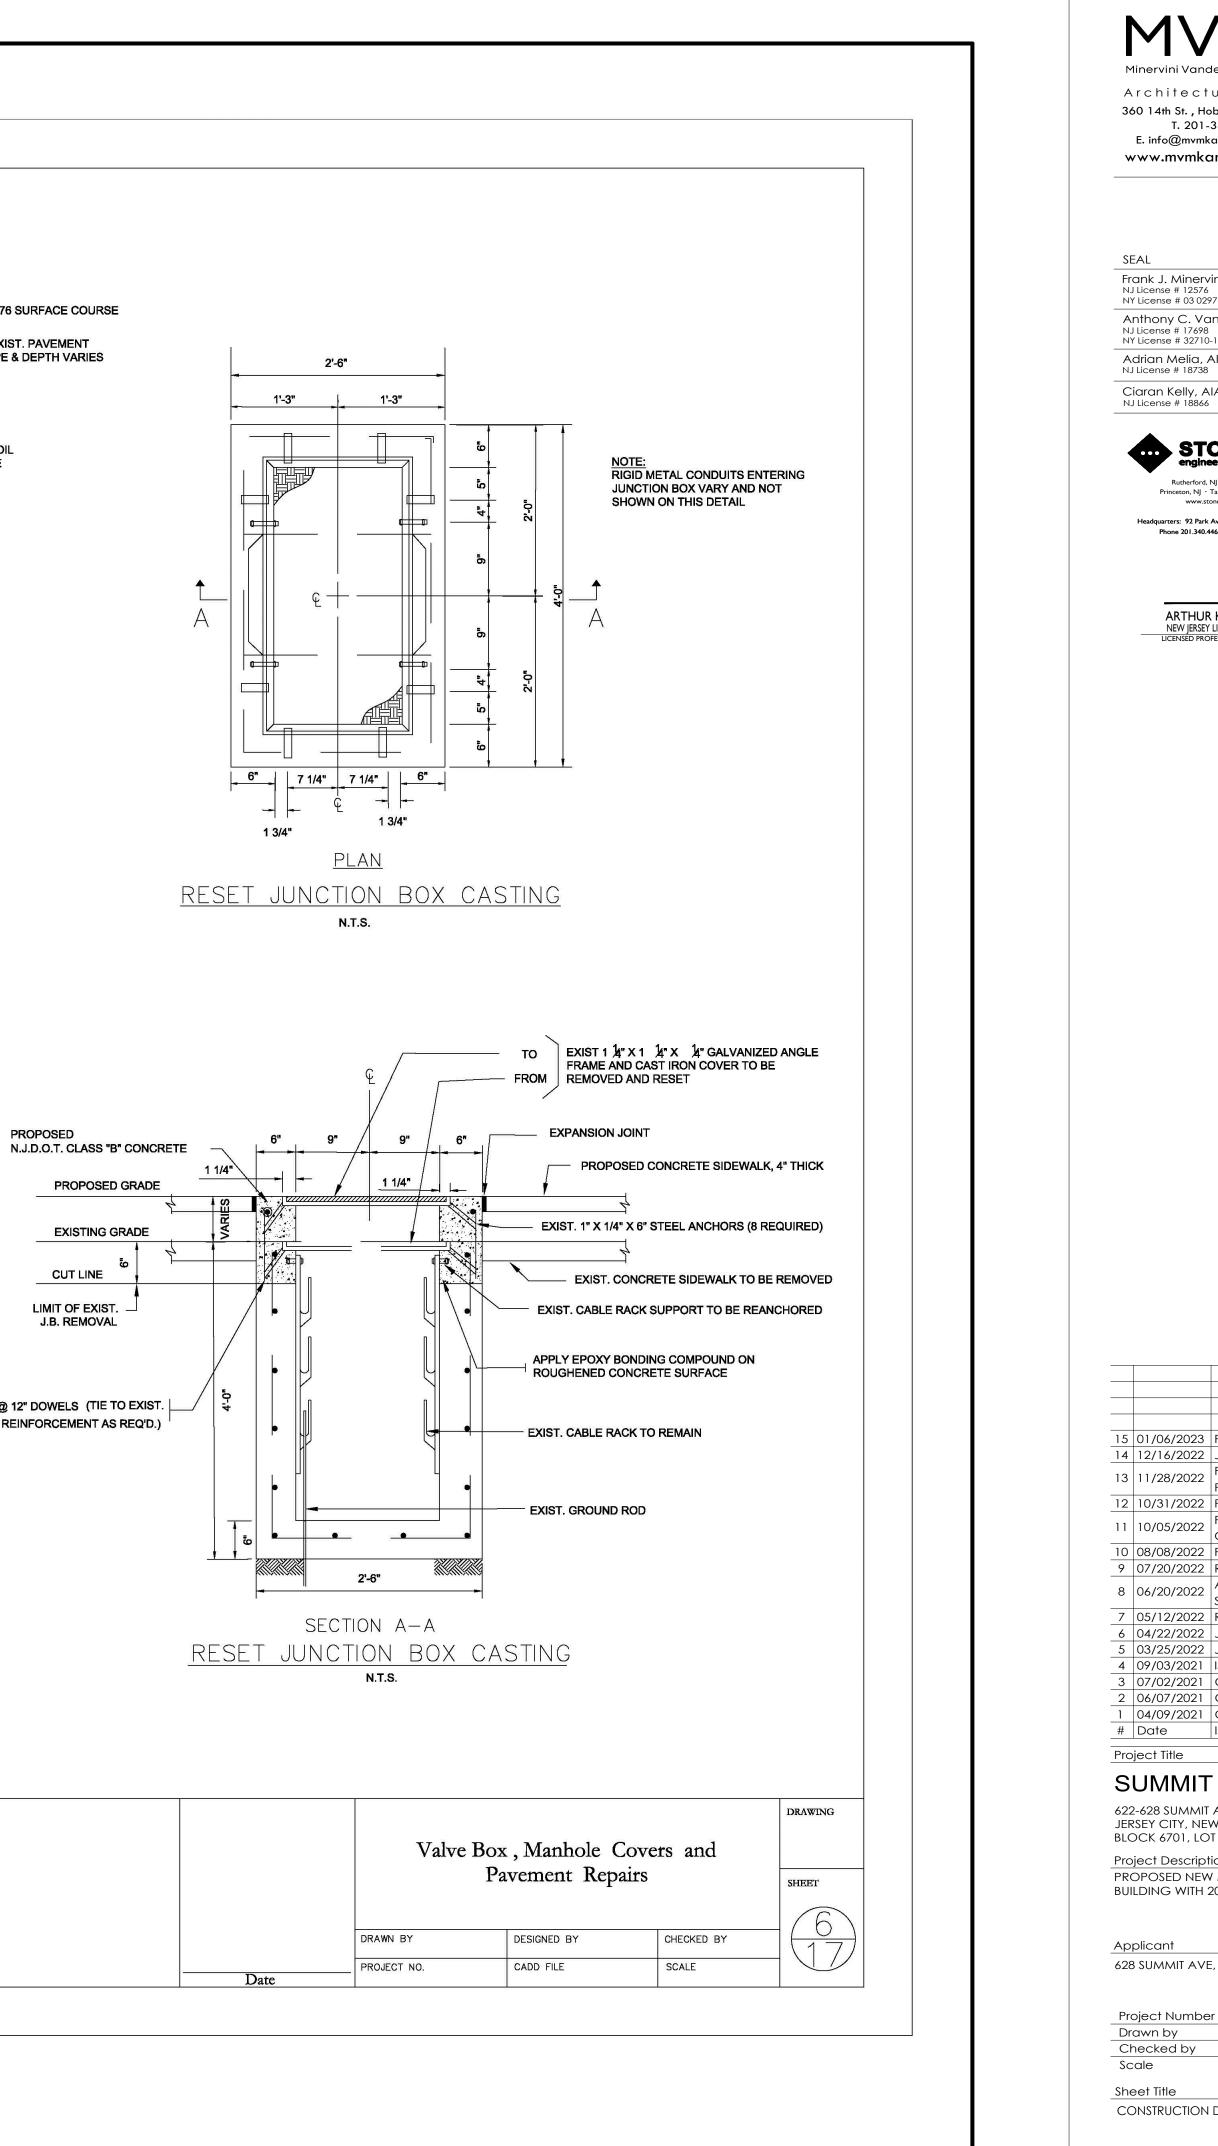


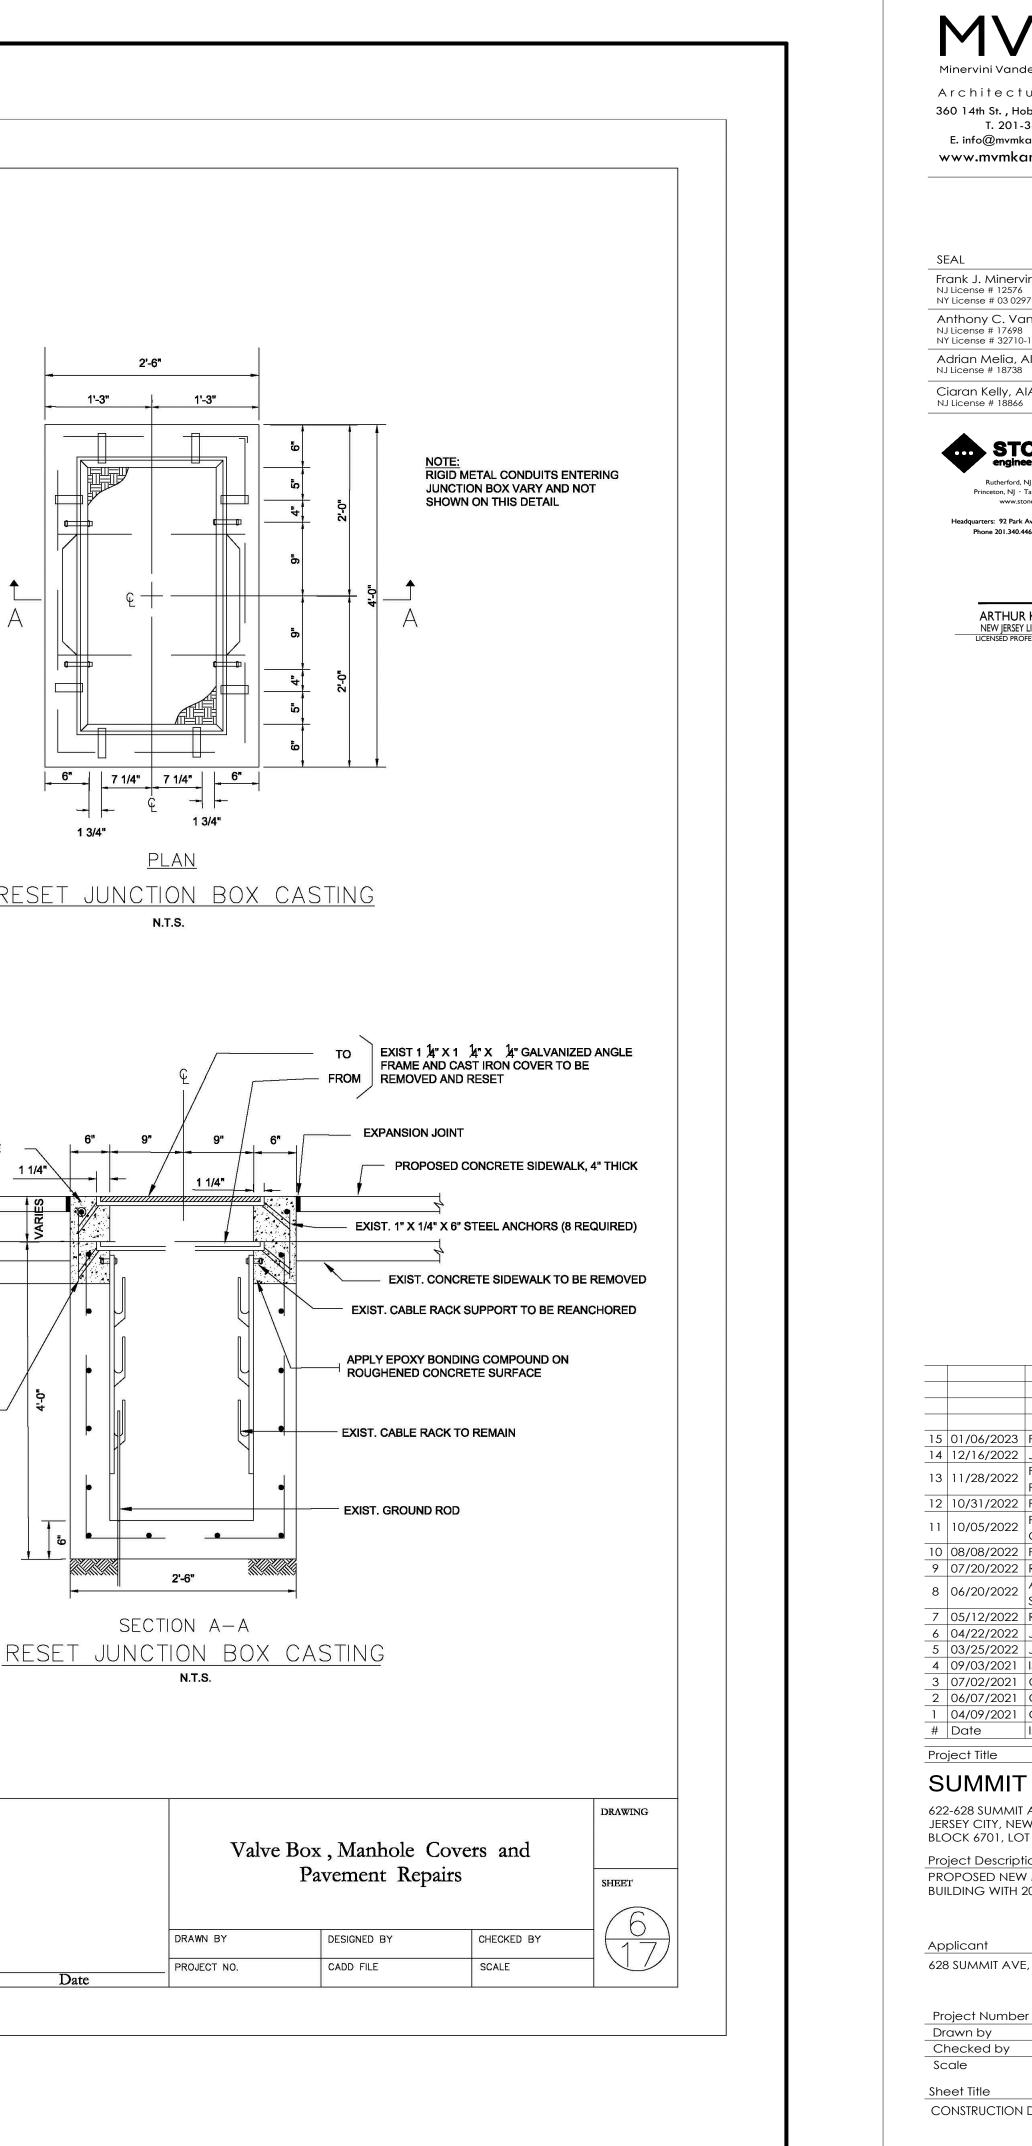

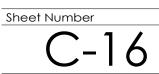

KB

As Noted

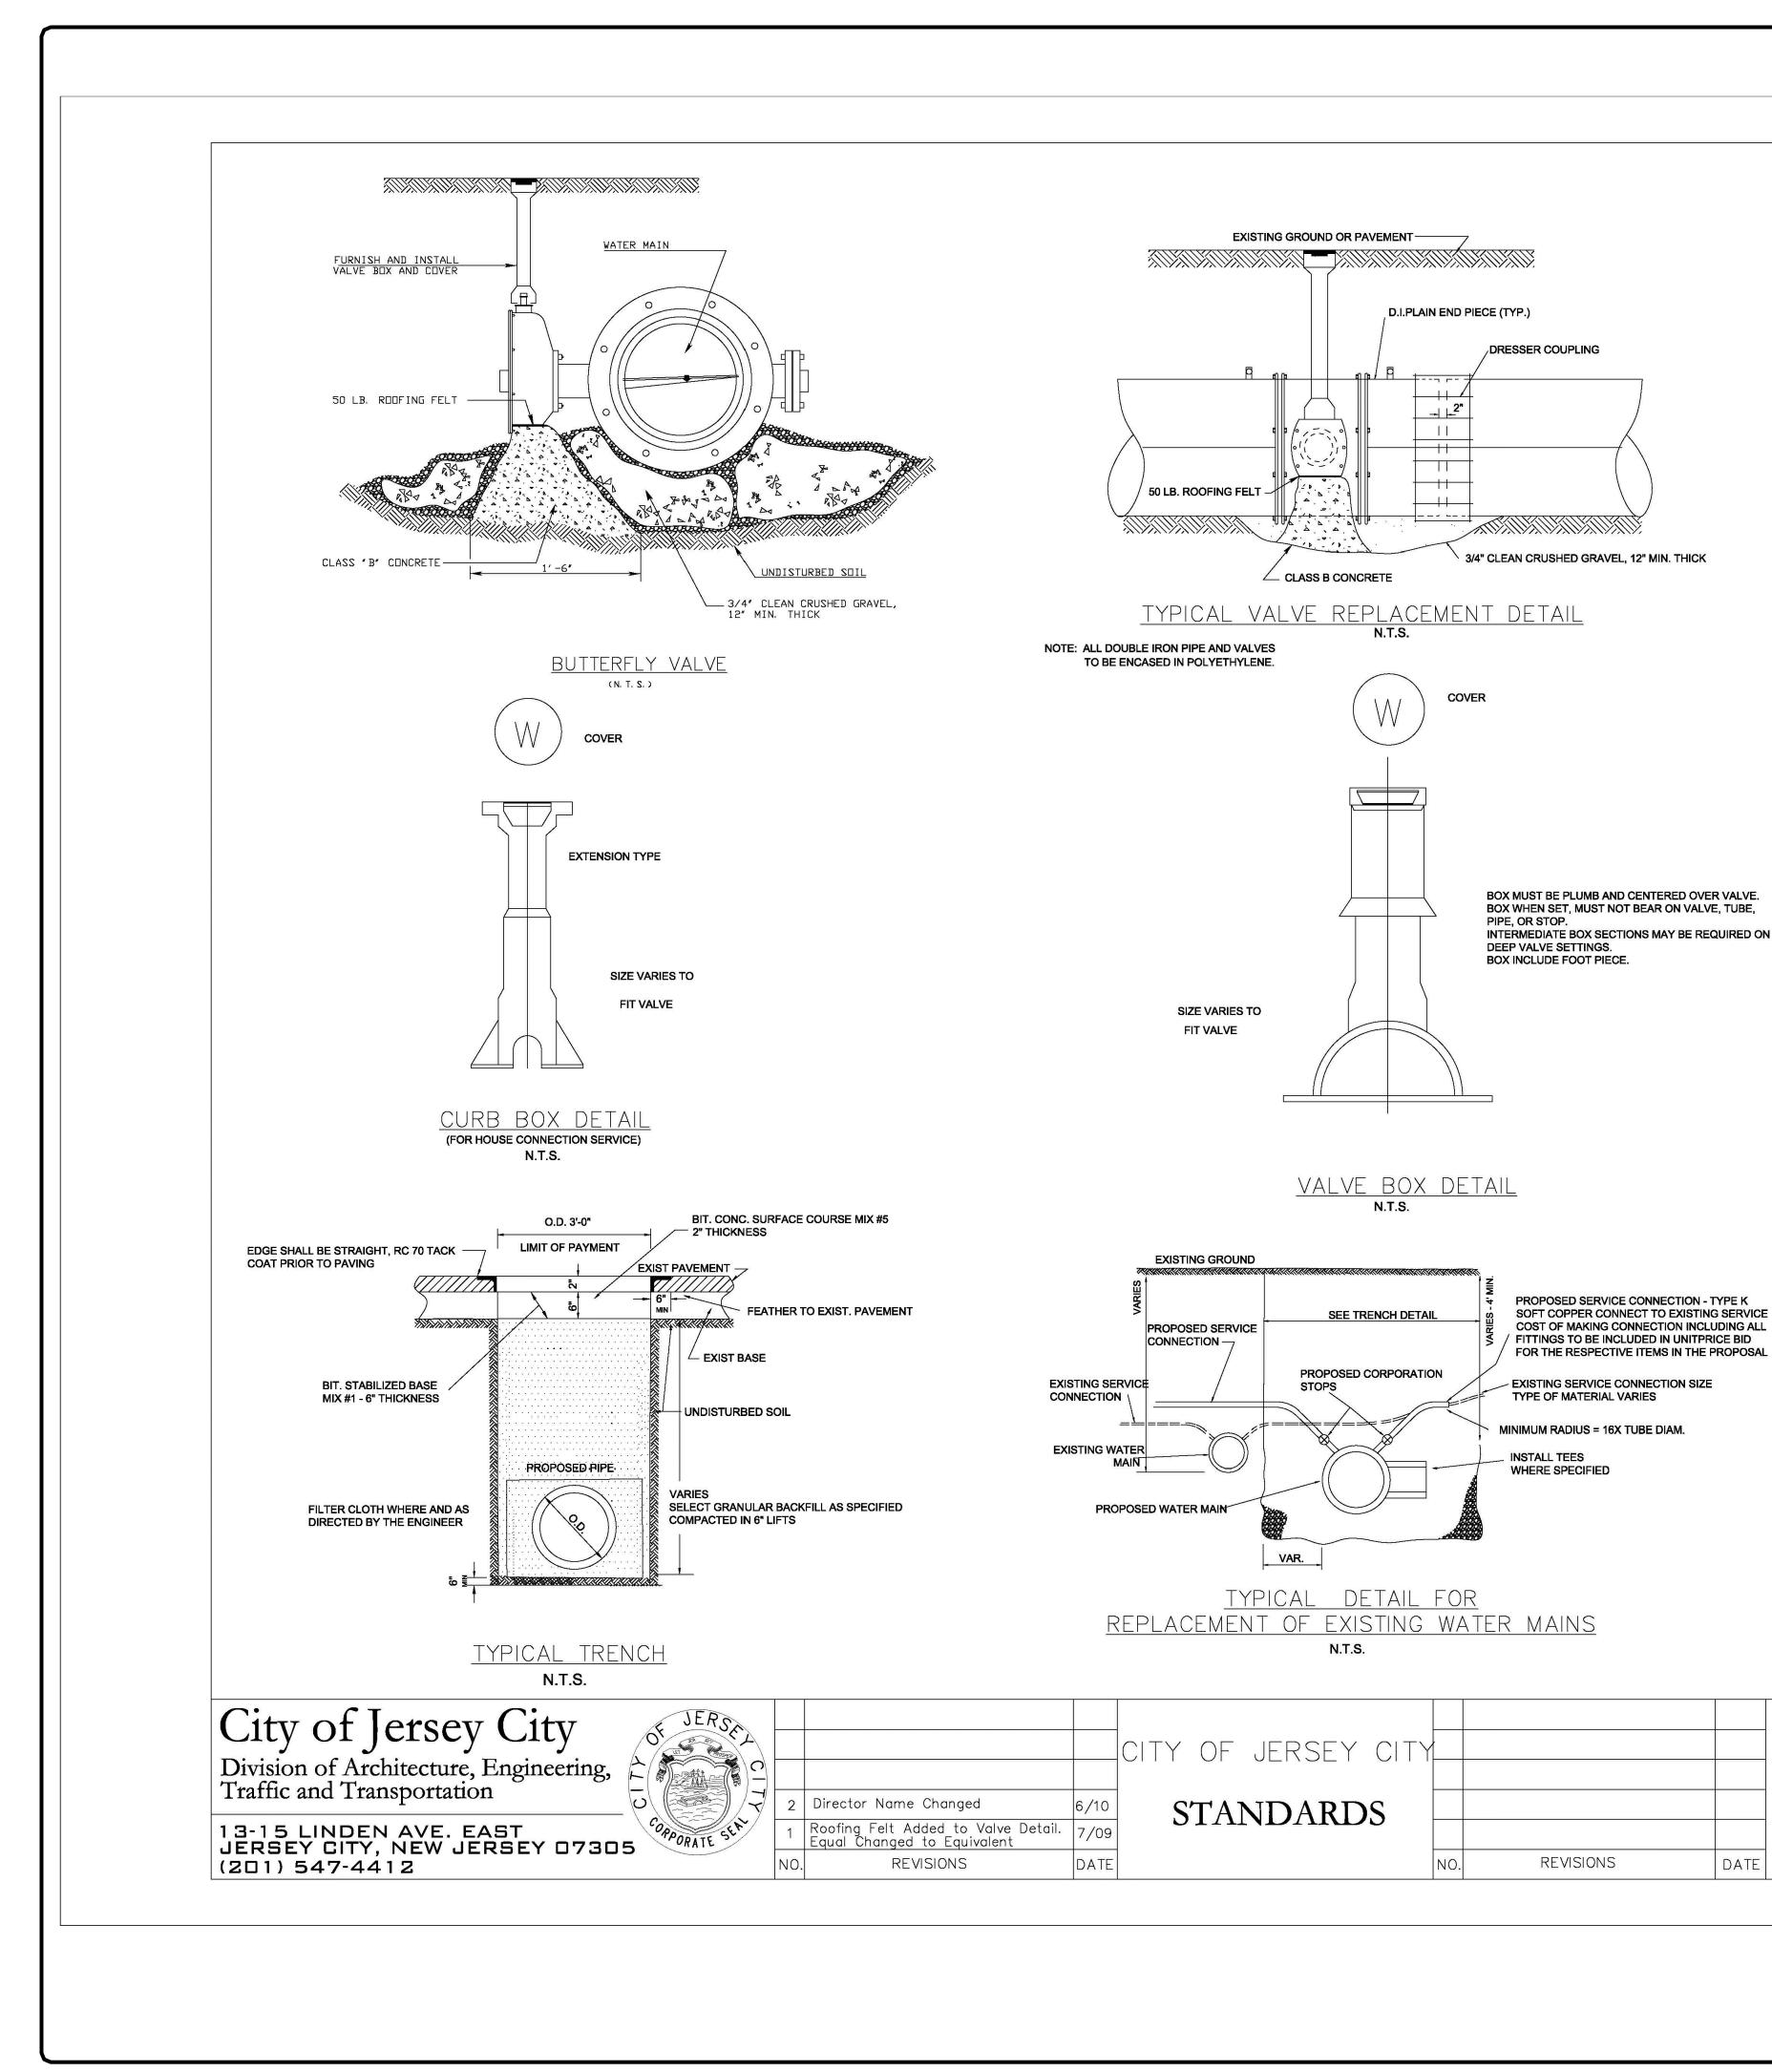

NOTES ON WATER MAINS AND VALVES

1) WATER MAINS SHALL BE CLASS 53, CEMENT LINED, DUCTILE IRON PIPES WITH MECHANICAL JOINTS AND SHALL BE IN CONFORMANCE WITH A.N.S.I. STANDARD A21.5-1976 [A.W.W.A. C151-76]

2) GATE VALVES SHALL BE IN CONFORMANCE WITH A.N.S.I./A.W.W.A. STANDARD C500-80 AND SHALL BE JERSEY CITY STANDARD VALVES, M&M METROPOLITAN JOINT VALVES AS MANUFACTURED BY DRESSER COMPANY OR APPROVED EQUIVALENT BY A MUNICIPAL ENGINEER. VALVES SHALL BE NON-RISING STEM; MECHANICAL JOINTS SHALL BE FURNISHED WITH A (2") SQUARE OPERATING NUT AND SHALL OPEN BY TURNING TO THE RIGHT. GATE VALVES (16") AND OVER SHALL BE FURNISHED WITH BY-PASS. VALVE SHALL BE 100% SOLID HEAT CURED EPOXY COATED HOLIDAY-FREE IN THE WATERWAY.

3) BUTTERFLY VALVES SHALL BE IN CONFORMANCE WITH A.N.S.I/A.W.W.A. STANDARD C504-80. BUTTERFLY VALVES SHALL BE CLASS 150B, MECHANICAL JOINT, WITH RUBBER SEAT MOUNTED ON THE DISC, SHALL BE FURNISHED WITH A (2") SQUARE OPERATING NUT AND SHALL OPEN BY TURNING TO THE RIGHT. VALVE SHALL BE 100% SOLID HEAT CURED EPOXY COATED HOLIDAY-FREE IN THE WATERWAY. THE BUTTERFLY VALVES WILL NOT BE PERMITTED IN MAINS (16") AND UNDER.

4)VALVE BOXES SHALL BE JERSEY CITY "STANDARD" AS MANUFACTURED BY BINGHAM AND TAYOLR, OR APPROVED EQUIVALENT BY A MUNICIPAL ENGINEER. BOXES SHALL HAVE A MIN. OF 8-1/4 INCH DIAMETER AND SHALL BE AN ADJUSTABLE SCREW TYPE WITH THE BOX EXTENDING FROM THE SURFACE TO (3") ABOVE THE VALVE BONNET BASE. VALVE BOX SHALL BE CAST FROM WATER DROP COVER AND THE WORK "WATER" CAST IN COVER. VALVE BOX COVER SHALL BE INSTALLED FLUSH WITH THE EXISTING GRADE ELEVATION.

5)CONCRETE FOR VALVE SEATS AND THRUST BLOCKS SHALL HAVE A MINIMUM OF 28 DAYS STRENGTH OF 3000 PSI.

6)SELECT GRANULAR BACKFILL MATERIAL SHALL BE SOIL AGGREGATE TYPE I-6 (POROUS FILL, CLEAN SAND, GRAVEL OR STONE) OBTAINED FROM DRY SOURCES AND SHALL BE FREE FROM STUMPS, BRUSH, WEEDS, ROOTS, RUBBISH, WOOD, AND OTHER MATERIALS THAT MAY DECAY. GRADATION SHALL CONFORM TO TABLE 801-2, FOR TYPE I-6 IN ARTICLE 901.09 OF THE NJDOT STANDARD SPECIFICATIONS. BACKFILL MATERIAL SHALL BE PIECED AND COMPACTED IN 12 INCH LIFTS.

7)TIE RODS SHALL BE THREE QUARTER (3/4) INCH DIAMETER THREADED STEEL BARS. RODS SHALL HAVE A MINIMUM YEILD STRESS OF 36,000 PSI.

8) COUPLINGS SHALL BE DRESSER STYLE NUMBER 153 FOR PIPE SIZES THROUGH (30") INCH DIAMETER. FOR LARGER DIAMETER PIPE, DRESSER STYLE NUMBER 38 STEEL COUPLINGS SHALL BE USED.

9) SHEETING, SHORING, AND BRACING SHALL BE CLOSED VERTICAL SHEETING, TONGUE AND GROOVE WHICH IN BRACED TO PREVENT THE CAVE-IN OF TRENCHED. ALL LABOR EQUPIMENT, MATERIALS, AND METHODS OF CONSTRUCTION SHALL CONFORM TO THE REQUIRMENTS OF THE US OCCUPATIONAL SAFTEY AND HEALTH ADMINISTRATION.

MATERIALS FOR SHEETING SHALL BE TONGUE AND GROOVE WOODEN PLANKS AND TIMBER OR STEEL CONFORMING TO THE REQUIREMENTS OF THE US OCCUPATIONAL SAFTEY AND HEALTH ADMINISTRATION. TIMBER SHALL BE A MIN. OF 3" THICK

SHEETING SHALL BE LEFT IN PLACE. SHORING AND BRACING SHALL BE REMOVED.

10) BROKEN STONE FOUNDATION CUSHION SHALL BE PLACED IN THESE AREAS WHERE THE DIRECTOR, DEPT. OF ENGINEERING HAS DEEMED THE SOIL CONDITIONS INFERIOR. BROKEN STONE SHALL CONFORM TO ARTICLE 901.03 OF THE STANDARD SPECIFICATION AS CURRENTLY AMENDED. THE SIZE OF THE BROKEN STONE SHALL BE SHOWN ON THE PLANS OR AS DIRECTED BY THE ENGINEER OF SIZE NUMBER 2,4,5 OR 6 AS SHOWN IN TABLE 901-1. STANDARD SIZES OF COARSE AGGREGATES OF THE NEW JERSEY DEPT. OF TRANSPORTATION STANDARD SPECIFICATIONS.

11) FILTER CLOTH SHALL BE PLACED IN THOSE AREAS WHERE THE DIRECTOR DEPT. OF ENGINEERING HAS DEEMED THE SOIL CONDITIONS INFERIOR.

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12) AFTER THE ENGINEER HAS INSPECTED THE COMPLETED INSTALLATION OF VALVES, AND WATER MAIN, AND BEFORE BACKFILLING THE EXCAVATIONS. THE CONTRACTOR SHALL FURNISH ALL LABOR, MATERIALS, AND EQUIPMENT REQUIRED TO PRESSURE TEST THE PIPE. THE PIPE SHALL BE PRESSURIZED TO 1.5X THE WORKING PRESSURE FOR A PERIOD OF 2 HOURS. PRESSURE SHALL NOT VARY MORE THAN 5 PSI. THE VALVED SECTION OF THE PIPE SHALL BE APPLIED BY MEANS OF A PUMP CONNECTED TO THE PIPE IN A MANNER SATISFACTORY TO THE ENGINEER. BEFORE APPLYING THE TEST PRESSURE, AIR SHALL BE EXPELLED AS THE LINE IS FILLED WITH WATER. IF THE JOINT LEAKS, REPAIRS OR REPLACEMENTS SHALL BE MADE. TESTING SHALL BE IN CONFORMANCE WITH A.W.W.A. STANDARD C600-77.

13) THE CONTRACTOR SHALL DISINFECT ALL WATER MAINS IN ACCORDANCE WITH A.W.W.A. STANDARD FOR DISINFECTING WATER MAINS DESIGNATION C-601. COMMERCIAL PRODUCTS SUCH AS THE "HTH", "PERCHLORON", AND "MAXOXHLOR" MAY BE USED IN FLAKE OR CRYSTAL FORM. BUT IN NO INSTANCE WILL TABLETS BE PERMITTED TO BE USED IN THE DISINFECTION OF WATER MAINS.

THE CHLORINE DOSAGE SHALL INITIALLY PRODUCE 50 PPM RESIDUAL TO THE WATER AND MAINTAIN A MIN RESIDUAL OF 25 PPM AFTER 24 HOURS. AFTER SATISFACTORY DISINFECTION OF THE TEST SECTION. THE LINE SHALL BE CONTINUOUSLY FLUSHED UNTIL THE RESULTANT CHLORINE RESIDUAL EQUALS 1 PPM OR THE RESIDUAL OF THE SYSTEM, WHICHEVER IS GREATER. AFTER FINAL FLUSHING AND BEFORE THE WATER MAIN IS PLACED IN SERVICE SAMPLES SHALL BE COLLECTED FROM EACH END OF THE MAIN AND TESTED FOR BACTERIOLOGIC QUALITY. IF THE INITIAL DISINFECTION SHALL BE REPEATED UNTIL SATISFACTORY SAMPLES HAVE BEEN OBATINED.

14) AIR RELEASE VALVES SHALL BE INSTALLED AT THE HIGH POINTS OF THE WATER MAINS.

15) ALL WATER MAINS WILL BE LEAST 8" DIAMETER. TEN (10") AND 14" DIAMETER MAINS SHALL NOT BE USED.

16) THRUST BLOCKS AND THE RODS SHALL BE INSTALLED AT ALL BONDS AND FITTINGS.

17) HYDRANTS SHALL BE 2 PIECE "JERSEY CITY STANDARD" HYDRANTS AS MANUFACTURED BY A.P. SMITH OR APPROVED EQUIVALENT. HYDRANT SPACING SHALL BE A MAX 200 FT. MEASURED CENTER TO CENTER.

18) FOR EITHER NEW CONSTRUCTION ON OR RELOCATION THE FOLLOWING SHALL BE REQUIRED: A. HYDRANTS SHALL BE LOCATED NO CLOSER THAN 20 FEET FROM THE POINT OF TANGENCY OR CURVATURE AT INTERSECTIONS. B. ALL ONE PIECE OR HYDRANTS NOT MANUFACTURED BY A.P. SMITH THAT ARE TO BE RELOCATED SHALL BE REMOVED AND DELIVERED TO JERSEY CITY DIVISION OF WATER DISTRIBUTION. A NEW HYDRANT WILL BE SUPPLIED BY THE CITY FOR INSTALLATION. C. HYDRANTS SHALL BE NO CLOSER THAN 12 FEET FROM THE EDGE OF A RESIDENTIAL DRIVEWAY. IN THE CASE WHERE DRIVEWAYS ARE EXPANDED OR NEWLY CONSTRUCTED, THE OWNER SHALL BE RESPONSIBLE FOR THE RELOCATION OF AN EXISTING HYDRANT IF ABOVE REQUIRMENTS ARE VIOLATED. D. ALL SINGLE GATED HYDRANTS ON 16" INCH OR LARGER MAINS SHALL REQUIRE A NEW VALVE AT THE BASE OF THE RELOCATED

HYDRANT. E. NEW GATE VALVES AND BOXES ARE REQUIRED AT THE BASE OF RELOCATED HYDRANTS WHEN MORE THAN 10 FEET OF PIPE IS REQUIRED.

19) EXISTING WATER SERVICE LINES SHALL BE SHUT-OFF AND CAPPED AT THE MAIN PRIOR TO THE INSTALLATION OF NEW WATER SERVICES. PRIOR TO NEW SERVICE TAPE THE JERSEY CITY WATER DEPARTMENT SHALL INSPECT AND CERTIFY THE ABANDONED SERVICE.

20) WATER MAINS TO ABANDON SHALL BE CUT AND PLUGGED WITH REQUIRED FITTINGS, RODS, AND CONCRETE AS CLOSE TO THE EXISTING MAIN IN SERVICE AS POSSIBLE.

21)ALL VALVES SHALL BE OPERATED BY JERSEY CITY WATER DEPT. PERSONNEL. THE CONTRACTOR SHALL NOT BE PERMITTED TO OPERATE ANY VALVES. THE CONTRACTOR SHALL NOTIFY THE ENGINEER, IN WRITING, FIVE(5) DAYS IN ADVANCE OF VALVE OPERATING REQUIREMENTS.

22) FAILURE TO COMPLY WITH ABOVE REQUIREMENTS WILL RESULT IN THE IMMEDIATE SHUTDOWN OF THE PROJECT.

Water	Mains and	d Valves	DRAWING
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		CHECKED BY	-177

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Minervi	ni Vanderı	mark	Melic	ı Kelly
Archi	tectur	e +	Des	ign

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SEAL

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ARTHUR KUYAN, P.E. NEW JERSEY LICENSE No. 55741 LICENSED PROFESSIONAL ENGINEER

15	01/06/2023	PB RESUBMISSION		
14	12/16/2022	JCMUA REVISIONS		
13	11/28/2022	FOR BUILDING		
15	11/20/2022	PERMIT		
12	10/31/2022	PSEG REVISION		
11	10/05/2022	PER JCMUA		
	10/03/2022	COMMENTS		
10	08/08/2022	PB RESUBMISSION		
9	07/20/2022	REVISED DRAINAGE		
8	06/20/2022	AMENDED FINAL		
0	00/20/2022	SITE PLAN		
7	05/12/2022	REVISED GRADING		
6	04/22/2022	JCMUA REVISIONS		
5	03/25/2022	JCMUA REVISIONS		
4	09/03/2021	ISSUED FOR BID		
3	07/02/2021	CD 90%		
2	06/07/2021	CD 75%		
1	04/09/2021	CD 50%		
#	Date	Issue		
Project Title				

SUMMIT TOWER

622-628 SUMMIT AVE JERSEY CITY, NEW JERSEY 07306 BLOCK 6701, LOT 21.01

Project Description

PROPOSED NEW MIXED USE BUILDING WITH 209 RESIDENTIAL UNITS

Applicant 628 SUMMIT AVE, LLC

Project Number: T-18276 Drawn by KB Checked by : KB Scale As Noted

Sheet Title CONSTRUCTION DETAILS

