

SCALE: I" = 500'±

AMENDED FINAL MAJOR SITE PLAN **FOR**

PROPOSED 28-STORY MIXED-USE DEVELOPMENT

BLOCK 6701, LOTS 21-24 622 - 628 SUMMIT AVENUE CITY OF JERSEY CITY, HUDSON COUNTY, NEW JERSEY

500 FT SITE RADIUS

200 FT SITE RADIUS

ZONE 74 BLOCK 6502

ZONING RELIEF TABLE

APPLICANT/OWNER

JERSEY CITY, NEW JERSEY 07302

8LOCK 6702

AERIAL MAP SCALE: I" = 150'±



PLANS PREPARED BY:



CITY OF JERSEY CITY 200' PROPERTY OWNERS LIST





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TAX & ZONING MAP

SCALE: I" = 150'±

PLAN REFERENCE MATERIALS:

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MVMK

Frank J. Minervini, AIA 10 borne # 12575 11 cucese # 03 0297 as Anthony C. Vandermark, J.	SEAL	
1) Fucense # C3 SS9 Fe3		
	Std Linesense	H 17674

Adrian Melia, AlA



Cl. D. Ch CHARLES D. OUVO, P.E.

SUMMIT TOWER

		TABLE OF L	AND USE AND	ZONING			
		aro	CK 6701, LOTS 21 - 24				
	ı		HO REDEVELOPHENT				
PROPOSED USE							
MULTI- FAMILY RESIDENTIAL	PERMITTED USE		··				
AETAIL STORE	PERMITTED USE						
ZOMMG REQUIREMENT	AEQUIRED	EXISTING LOT 21	EXISTING LOT 22	EXISTING LOT 23	EXISTING LOT 24	PREVIOUSLY APPROVED	PAOPOSED
MINIMUM LOT AREA	7.500 SF	2.716 SF (.06 AC)	2,430 SF (0.06 AC)	9'411 21 (012 VC)	2.5(8.5F (0.06 AC)	14.077 SF(0.32 AC)	NO CHANGE
HIMBUH LOT WIDTH	75 Ff	25.0 FT	312 FT	49.9 FT	49.8 FT	1003 FT	NO CHANGE
HINIMUM LOT DEPTH	100 F7	[01.0 FT	109.5 FT	BS 5 FT	33.0 FT	\$50.0 FT	NO CHANGE
MAXIMUM SHAPE FACTOR	28 [MENIMETER/JAKEA]	26.3	26.5 (EN)	22.6	23.4	12.0	NO CHANGE
HENTHUM BUILDING HEGHT	S STORIES52 FT	1 STONES	2 STONES	15TONES	4 STORES	27 STORIES / 285 FT	28 STORIES / 295 FT
MAXIMUM BUILDING HEIGHT	25 STOMES/LIS FT +2 BONUS OFFICE STOMES / 28 FT	1 STONES	2 STORES	TALONE	4570/65	27 STONES / 285 FT	28 STONES / 195 FT (V)
MINIMUM FRONT BUILDING STEPBACK							
IST FLOOR	NONE	N/A	N/A	N/A	NA	1 FT	NO CHANGE
2ND TO 5TH FLOOR	NONE	N/A	N/A	N/A	NIA	8 FT	NO CHANGE
STH TO 10TH FLOOR	NONE	N/A	N/A	N/A	N/A	15 FT	NO CHANGE
11TH TO 18TH FLOOR	IDFT	NA	N/A	N/A	N/A	ISF	NO CHANGE
19TH FLOOR AND UP	RÉFER TO TOWER ON A BASE SECTION VILC (15 FT)	N/A	N/A	N/A	N/A	ISFT	NO CHANGE
MINIMUM ROE BLILLING STEPBACK	1						
IST ROOR	NONE	N/A	NA	NIA	N/A	0.87	NO CHANGE
"THO TO STH FLOOR	NONE	N/A	N/A	NIA	N/A	0 FT	NO CHANGE
6TH TO 19TH FLOOR	NONE	N/A	N/A	NA	N/A	3.08 FT	NO CHANGE
ISTH TO STITLE OF HTS	ISF	N/A	NIA	N/A	N/A	3.05 FT	NO CHANGE
19TH FLOOK AND UP	RÉFER TO TOWER ON A BASE SECTION VII C (20 FT)	N/A	N/A	N/A	N/A.	J.04 FT	NO CHANGE
MINIHUM REAR BUILDING STEPHACK			1				
IST PLOOR	NONE	NA	N/A	N/A	NVA	SFT	NO CHANGE
2ND TO STH FLOOR	UFT	N/A	N/A	N/A	N/A	SFT	NO CHANGE
ETH TO BOTH FLOOR	20 FT	N/A	N/A	NA	N/A	15.97 FT	NO CHANGE
()TH TO ()TH PLOOR	30 FT	N/A	N/A	N/A	N/A	43 FT	NO CHANGE
197H FLOOR AND UP	REFER TO TOWER ON A BASE SECTION VII.C	NUA	N/A	N/A	NIA	AS FT	NO CHANGE
HTOW XJAW3OS NUHMM	08	24.0 FT	13 FT	67 FT	11.3 FT	S FT (V)	7 FT
HINIMUM EKONT YAND SETBACK,	MINIMUM 15 FT SIDEWALK	N/A	N/A	N/A	N/A	\$ FT (V)	NO CHANGE
"XXXXTER CARY SOE HUHIMM	0.FT	वा हर	DOFT	0.6 FT	U FF	Q0 FT	NO CHANGE
MINIMUM REAR YARD SETBACK	4 Е	DOFT	20 FT	40.0 FT	1.6 FT	Q0 FT	NO CHANGE

SIGNAGE REQUIREMENTS							
CODE SECTION	REQUIRED	PREVIOUSLY	PROPOSED				
ĮWBĮ.	THE BUILDING ADDRESSIS REQUIRED TO BE PLACED ON BITHER THE HIAN BITAY DOOR, TRANSON WINDOW, BUILDING, OR AWAING PLAF AT A MAXIMUM FONT HEIGHT OF TOUNCHES.	WILCOMMY	NO CHANG				
\$[Y.8.4(4)	•	MILCOMPLY	NO CHANG				
11V.B.4 (a)(i)	EACH USE FRONTING A PUBLIC STREET MAY SE PERHTTED ONE (\$) EXTENOR SIGN PER STORE PRONT SAY ON EACH STREET FRONTAGE.	WIT COMMTA	NO CHANG				
\$1Y.B.4.(a)(ii)	MARINUM SEN HEIGHT SHALL BE INJUNCHES.	WILL COMPLY	NO CHANG				
şivci.	ALL SIGNS SHALL BE ATTACHED TO THE FIRST ROOK LEVEL OF THE BUILDING ONLY. ATTHOUGH BLADE SIGNS HAY BE ATTACHED TO THE FIRST ON SECOND ROOK FACADE.	WILL COMPLY	NO CHANG.				
PIA'C'S	ALL WALL SIGNS SHALL BE FLUSH MOUNTED.	WILL COHPLY	NO CHANG				
liv.c3	ALL BLADE SIGNS SHALL PROJECT NO MORE THAN 30 INCHES FROM THE FACADE AND THE BOTTON OF THE SIGN MUST BE A MINHUM OF 9 RET ABOVE THE SIDEWALK.	WIT CONFLA	NO CHANG				
(IV.C.4	MINDOW SIGNS OTHER THAN LETTERNO AND LOGGES AS HEROPALLY PREMITTED; SHALL BE MONBITED. LETTERNG ON LOGGES HALL BE WITHER OF DECOMBINE HET LEAR. FANT BLACK OR STCHED? PROFITED LASS STILL BETTERN AND SHALL BENIFFED TO HENDARS OF THE SHALL BENIFFED TO HENDARS OF THE SHALL STORE STILL BETTER SHALL SOVE NO HOLE THAN TWENTY (BYS) OF THE MINDOW MET THAN TWENTY (BYS) OF THE WINDOW MET THAN TYPESTY (BYS) OF THE WINDOW MET.	WILL COMPLY	NO CHANG				
\$1 V.C. 7.	SIGNS MAY BE UT FROM BACKUT HALO, AND URUGHTS.	WILL COMPLY	NO CHANG				
-	STORERONT WINDOWS SHALL NOT SE SLOCKED BY ANY INTEROR DISPLAY CASE OR OTHER FORM OF BAMBER. ROSESTAMMS ON THE STREET SHALL HAVE THE ABILITY TO SEE INTO THE SHOP AND YEW THE ACTIVITY WITHIN.	AMITICONNTA	NO CHANG				
\$I∧'⊂ĕ	GENS PLAYENCLUDE THE NAME OF THE STORE ONLY. BUILDING ADDRESS PHONE NUMBER OFFERTING HOURS AND OTHER ADDITIONALINFORMATION HAY SE STENGLED ON THE DOOR.	WIT COMPLY	NO CHANG				

DRAINAGE AND UTILITY NOTES

- THE CONTRACTOR TO PENDIN A TEST RT PRIOR TO CONTRIUCTION (AECOMPIEND 3D DAYS PRIOR) AT LOCATIONS OF EXSTING UTILITY COSSINGS FOR STORMWATER IMPROVEMENTS. SHOULD A COMPLECT
 CONTRACTOR SMALLI-INFECTION OF STORM USES AT THE LOWEST MAKER AND WORK INCREASED.
 CONTRACTOR SMALLISANT COSSINGS WITH USES AT THE LOWEST MAKER AND WORK INCREASED.
 CONTRACTOR SMALLISANT COSSINGS WITH USES AT THE LOWEST MAKER AND WORK INCREASED.
 THE LOWEST CONTRACTOR IS EXCUSED TO COMPRIANT HE PROSECUTED AND WORK INCREASED.
 THE LOWEST CONTRACTOR IS EXCUSINED TO COMPRIANT HE PROSECUTED AND WORK INCREASED.
 THE LOWEST CONTRACTOR IS EXCUSINED TO COMPRIANT HE PROSECUTED AND WORK INCREASED.
 THE LOWEST CONTRACTOR IS EXCUSINED TO COMPRIANT HE PROSECUTED AND WORK INCREASED.
 THE LOWEST CONTRACTOR IS EXCUSINED TO COMPRIANT HE PROSECUTED AND SHOULD AND SHOULD
- EXCAVATION, SOIL PREPARATION, AND DEWATERING NOTES

- THE CONTRACTORS BEQUIABLE TO REPREVENDED COTTECHNICAL DOCUMENTS FROM TO CONSTRUCTION. THESE DOCUMENTS SHALL SE CONSIDERED A PART OF THE FLAN SET.

 1 THE CONTRACTORS REQUIABLE TO REPREVENDED COTTECHNICAL ALL PROPOSED IMPROVEMENTS AND BACKSILLAL DECARATIONS IN ACCORDANCE WITH RECOVERS DATIONS IN ACCORDANCE WITH RECOVERS DATIONS AND SECURITY OF THE CONTRACTORS DECARATIONS OF THE CONTRACTORS DECARATIONS AND SECURITY OF THE CONTRACTORS SECURITY OF THE CONTRACTORS DECARATIONS AND SECURITY OF THE CONTRACTORS SECURITY OF THE CONTRACTORS DECARATIONS AND SECURITY OF THE CONTRACTORS SECURITY OF THE

- 5 DEMANDER UNDERGROUND BHY CONSTRUCTION NOTES.

 1. THE CONSTRUCTOR SHALL NITRALL AND BACKELL THE UNDERGROUND BHY IN ACCORDANCE WITH THE 1. INCOMPANIENT SHALL COLLEGE SHALL BE SHALL BY THE UNDERGROUND BHY IN ACCORDANCE WITH THE 1. INCOMPANIENT SHALL COLLEGE SHALL BE SHALL BY THE UNDERGROUND BHY IN ACCORDANCE WITH THE 1. INCOMPANIENT SHALL SHALL BE SHALL BY THE SHALL B

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- 1. THE CONTRACTOR SECRETARY APPRIESTANCE CONTROL TO THE CONTRACTOR SECRETARY APPRIESTANCE CONTROL TO THE CONTRO

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07/20/2022	REVISED DRAINAGE
0410010000	JAMENDED HNAL
06/20/2022	SITE PLAN
05/12/2022	REVISED GRADING
04/22/2022	JCMUA REVISIONS
03/25/2022	JCMUA REVISIONS
09/03/2021	ISSUED FOR BID
07/02/2021	CD 90%
06/07/2021	CD 75%
04/09/2021	CD 50%
Dale	(see
	06/20/2022 05/12/2022 04/22/2022 03/25/2022 09/03/2021 07/02/2021 06/07/2021 04/09/2021

MVMK

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SEAL

Frank J. Minervini, AJA
(II lisens = 125/6
Elisens = 125/7
Elisens = 125/7
Anthony C. Vandermark, Jr. AJA
(II lisens = 175/6
Elisens = 125/7
Elisens = 1

* STONEFIELD Eurospee (gl. Euro-Yung set Prostoria ng in Europa (g. in Conseque) union material impasse cl p.ch

Adrign Melia, AIA Nucerse # 16718 Cigino Kelly, AIA

Project Title SUMMIT TOWER 622-628 SUMMIT AVE JERSEY CITY, NEW JERSEY 07306 BLOCK 6701, LOT 21,22,23 & 24

Project Description
PROPOSED NEW MIXED USE
BUILDING WITH 209 RESIDENTIA
UNIS, 2 RETAIL UNIS, & 2
COMMERCIAL FLOORS

Applicent 424 SUMMIT AVE, LLC

Protect Number: 7-18976
Drawn by : K8
Checked by : AK
Scale : As Noted Sheet fide

C-2

PROPOSED USE											
MULTI- FAMILY RES	DENTIAL.	PERHITTED USE									
AETAIL STORE		PERMITTED USE									
ZOMING REQUIRE	TENT	AEQUIRED	EXISTING LO	7 21 EXTSTIN	G LOT 22	EXISTIN	0 LOT 23	EXISTING	LOT 24	PREVIOUSLY APPROVED	PROPOSED
MINIMUM LOT AREA		7,500 SF	2.716 SF (.06 AC	3 243055	0.06 AC)	P+11 21.	1(S AC)	2.5(8.5F (0.0	6 AC)	14.077 SF(0.32 AC)	NO CHANGE
HINNUH LOT WIDT	H	75 Ff	25.0 FT	21.2 FT		49.9 FT		49.8 FT		1003 FT	NO CHANGE
MINIMUM LOT DEPTH	,	100 FT	[01.0 FT	JD9.S FT		BS.5 FT		33.0 FT		\$50.0 FT	NO CHANGE
MAXIMUM SHAPE FAC	TOR	28 (MENIMETER/JAREA)	36.3	26.5 (EN)		22.5		23.4		12.0	NO CHANGE
MENTHUM BUILDING	HECHT	S STORIBISS FT	1 STONES	2 STONE	š	257040		4 STORES		27 STONES / 285 FT	28 STORES / 295 FT
HAMMUM BULLING		25 STOMES/LIS FT +2 BONUS OFFICE STOMES # 28 FT	2 STONES	2 STORE	2	7 21 ONE	1	4 STORES		27 STONES / 285 FT	28 STORES / 195 FT (V)
MINIMUM FRONT BU	LIDING STEPBACK]									
IST FLOOR		NONE	N/A	N/A		N/A		N/A		1FT	NO CHANGE
2ND TO STH FLOO		NONE	N/A	N/A		N/A		NA		8 FT	NO CHANGE
STH TO 10TH R.O.C		NOME	N/A	N/A		N/A		N/A		IS FT	NO CHANGE
11TH TO 18TH FLOX		to FT	N/A	N/A		N/A		N/A		រេត	NO CHANGE
19TH ROOK AND L		REFER TO TOWER ON A BASE SECTION VILC (IS FT)	N/A	N/A		NVA		N/A		ISFT	NO CHANGE
HINIMUM ROESTATO	NG STEPBACK										
_IST ROOR .		NONE	NA	NA		N/A		N/A		0 FT	NO CHANGE
"THE TO STH ROO		NONE	N/A	N/A		NJA		N/A		0 FT	NO CHANGE
ATH TO JOTH RACO		NONE	N/A	N/A		NA		N/A		J.OE FT	NO CHANGE
ISTH TO DITH FLOR		ISF	N/A	N/A		N/A		NA		3.08 FT	NO CHANGE
19TH FLOOR AND U		RÉFER TO TOWER ON A BASE SECTION VII C (10 FT)	N/A	N/A		N/A		N/A		J.OI FT	NO CHANGE
MINIHUM REAKBUILE	ING STEPHACK	i									
IST PLOOR		NONE	NIA	N/A		N/A		NVA		S FT	NO CHANGE
ZND TO STHELOO		IS FT	N/A	N/A		N/A		N/A		SFT	NO CHANGE
STH TO SOTH FLOO		20 FT	N/A	N/A		N/A		N/A		15.97 FT	NO CHANGE
(ITH TO INTH FLCX		30 FT	N/A	N/A		N/A		N/A		AS FT	NO CHANGE
197H FLOOR AND U		REFER TO TOWER ON A BASE SECTION VILLE	NVA	N/A		N/A		N/A		AS FT	NO CHANGE
MINIMUM SDEWALK		B & T	24.0 FT	5.2 FT		67 FT		11.3 FT		S FT (V)	ग र
MINIMUM FRONT YA		MINIMUM 15 FT BDEWALK	N/A	N/A		NA		N/A		S FT (V)	ND CHANGE
CARY SOE HUHINM		0.F	OF EL	Q0FT		D.6 FT		LI FT		Q0 FT	NO CHANGE
MINIMUM REAR YAND	SETBACK	० हा	DOFT	2077		40.0 FT		1.4 FT		0.0 FT	NO CHANGE
(1) EXITING LOT (2) GROUND FLO (3) FRONT TARD: (4) REQUIREMENT	OR MAY COVER IN SETBACK IS BASED I	G ACCORDING TO (N.C.4(s) X OFTHE LOT ON MINHUM BOWALK WIDTH F A RIGHT-ORWAY			- 						IN REQUIREME
	TO	WER ON A BASE REQU	IREMENT:	5			CODE SE	стон	REQUIRE		
CODE SECTION	REQUIRED			PREVIOUSLY APPROVED	PROPOSI		{ @A7 .	- 1	AND/OR	Y THE ELDEALY, PHYSIC DISABLED SHALL MEET ONS AS SPECIFIED IN T ADA STANDAND UN FO	BANNER FREE DESIGN HE NEW JERSEY AND
§B.C3	MAMMUM RAST	FLOOR HEIGHT REQUIREMENT: 15 FT FLOOR HEIGHT REQUIREMENT: 20 FT		COMPLIES	NO CHA	NGE			CODE		

	TOWER ON A BASE REQUIREME	NTS	
ODE SECTION	REQUIRED	PREVIOUSLY APPROVED	PROPOSED
B.C.3	MINIMUM RAST FLOOR HEIGHT REQUIREMENT: 15 FT MAXIMUM RAST FLOOR HEIGHT REQUIREMENT: 20 FT	COMPLES	NO CHANGE
M.D. (0(4)	A WISHAL CUF OR INDICATOR SUCH AS A COMPLE BEST COURSING SET REALD THAT CHANGE IN THE GLASS TO SOULD KATE	COMPLIES	NO CHANGE
(d) 0 0 (b)	DECORATIVE FEATURES AND MATERIALS ARE REQUIRED	COMPLES	NO CHANGE
III.D. 0 (e)	BUILDING BASES SHALL BE CONSTRUCTED OF DULABLE MATERIA OF HIGH QUALITY, INCLUDING BUT NOT UNITED TO GLASS. STONE BRICK, TEXTURED CONCRETE, HETAL PANEUNG, ETC.	L COMPLES	NO CHANGE
#. D.1¢.(d)	A DECORATIVE SCREENING PACADE MAY SUBSTITUTE FOR GLASS TO WRAP PARKING FACILITIES, SUBJECT TO APPROVAL BY THE MANNING BOARD	COMPLES	NO CHANGE
■ D.10 (e)	RETAIL AND/OR OTHER PERMITTED USES ARE REQUIRED ALONG ALL PUBLIC NIGHT-OR WAYS WITH A HIMMUM DEPTH OF 25 PEET	COMPLES	NO CHANGE
M211 (4)	A MISUAL CUE ORSINGICATORS SUCH AS A CONNICE BELT COURSING, A SIGNIFICANT CHANGEIN THE GLASS TO SOLID RATIO	COMPLIES	NO CHANGE
■ D.11 (b)	BULDING TOWERS SHALL BE CONSTRUCTED OF DURANIE MATERIAL OF HIGH QUALIT, INCLUDING, BUT NOT BINTED TO GLASS, STONE TEXTURE CONCRETE, SHICK, METAL PANERING, ETC. GLASS SHALL CONSTITUTE A MINIMUM OF 40% OF THE FACADE.	CONTIS	NO CHANGE
11.D.(1.(c)	BURLDING TOWERS ARE REQUIRED TO HAVE A MINIMUM SEPARATION DISTANCE OF SUFF	COMPLIES	NO CHANGE
В	CYCLE AND OFF-STREET PARKING REQ	UREMENTS	
ODE SECTION	REQUIRED	PREVIOUSLY APPROVED	PROPOSED
345-70A 2.	AFTER (RIMO SF OF RETAIL SPACE BERTH REQUIRED RETAIL SPACE BEB22 SF = BERTHS	I BERTH	NO CHANGE
34\$-70.A.13.	MINIMUM CIMENZONS FOR A LOADING BERTH:	BEXISEM	NO CHANGE

CODE SECTION	REQUIRED	PREVIOUSLY APPROVED	PROPOSED	
[34570A]2.	AFTER 10,000 SF OF RETAIL SPACE 1 BERTH REQUIRED NETAIL SPACE 18822 SF = 1 BERTHS	I BERTH	NO CHANGE	
§ 14\$-70.A.13.	MINIMUM CIMENSONS FOR A LOADING BENTH: +0 FT X 10 FT	35 FT X (4 FT (V)	NO CHANGE	
§ 345-70.C.3.	ALL RESIDENTIAL USES IN BUILDING WITH 5 OR MORE UNITS: 0.5 SICYCLE SPACES PER UNIT 0.5 SPACES * 769 UNITS = (06 SPACES (INDOORS)	46 SPACES (V)	NO CHANGE	
§ 345-70.C.4.[b] [.	INVEGUREDINDOCR BCYCLE PAURINGSTORAGE ROOM NUST BE LOCATED IN A CONVENENT AND ACCESSIBLE LOCATION TO A RUBES OBMALK WITH NO HOLE THAN FOUR VERTICALS STEPS BETWEEN THE BCYCLE ROOM AND THE SDEWALK ANTH NO ELEVATORS HAVE BUTUSLED TO MOUNDE ACCESS TO BKE STOMAGE NOT LOCATED AT THE RIST TOOK LEVEL.	COHPUES "	NO CHANGE	
\$345-70 C.4.[4) .	AN ASSE OR SPACE THAT IS AT LEAST RIVE FEET WIDE SHALL BE PROMOTO FOR BICYCLES AND RIDERS TO ENTER AND LEAVE THE FACILITY.	SOFT	NO CHANGE	
\$345-70 C.4.(d).2	STEP MANS SHALL SHOW THE MICHOSTO LOCATION OF BIKE PARKINGSTORAGE FACULTIES ON THE STEAND ON THE BULLDING FLOOR MAN DESIGN, A CONSTRUCTION DETAIL OF THE BIKE MACK OR FACULTIES SHALL BE PROMIDED.	COMPLES	NO CHANGE	
∮31.E2(b).	CULB CUTS ARE MONITED EXCEPT WHERE PROVIDING ACCESS TO PARKING AREAS WITH 8 SPACES ON MORE	NO PROPOSED GARAGE 14.0 FT CURB CUT (V)	NO CHANGE	
\$ 0.62(c)	RESIDENTIAL USES MAY PROVIDE UP TO A MAXIMUM OF QS OFFIST REET PARKING SPACES PER DWELLING UNIT.	O SPACES PROMOTO	NO CHANGE	

LIGHTING REQUIREMENTS						
CODE SECTION	REQUIRED	PREMOUSLY APPROVED	PROPOSED			
(B.F.).	ADEQUATE LIGHTING SHALL BE PROVIDED TO ENCOURAGE ACTIVE USAGE AND A SENSE OF SECURITY IN THE OPEN SPACE.	COMPLES	NO CHANGE			
1 m.G.7.	LIGHTING WITHIN THE SITE SHALL SUFFICIENTLY BLUMMATE ALL AREAS INCLUDING THOSE ASSESS WHERE BLUELING ARE SETBACK ON OFFSET TO PREVENT DARX CONNERS.	COMPUS	NO CHANGE			
∮BCK	ALL LIGHTING SOUNCES HUST SE ADEQUATELY SHELDED TO AVOID ANY OFF-STE GLAR. THE ALEA OF ILLIMINATION SHALL HAVE A UNKNOW PATTERN OF AT LEAST ONE-HALF (0.5) FOOT CANDLES.	1.7 FC AVERAGE	NO CHANGE			
§ 345-69.B.6.b	PANETH AND TAPPED TO THE METAL SELECTION OF T	0.4 FC	NO CHANGE			

CODE SECTION	REQUIRED	PREVIOUSLY APPROVED	PROPOSED	
(MA7.	ACCES BY THE ELDERLY, PHYSICALLY HANDICAPPED AND/OR DISABLED SHALL HEET BANDER REE DESIGN REGULATIONS AS SECRETOR IN THE RISE (SAND APPEAL AND FEBERAL ADA STANDAND UN FORM CONSTRUCTION CODE.	COMPLIES	NO CHANGE	
§⊞A8	ALL USINTY DISTRIBUTION UNISSINCLUCING NUTLE-PECIA PLECOHNUNCATION UNISS AND UTILITY SERVICE CONNECTIONS RECH UNISS TO THE PROJECT AREAS INCLUDING. USE SHALL SE LOCATED UNDERGROUNG.	COMPLIES	NO CHANGE	
इंड ≯ाव्युव	TANISOUNCES AND PRIMARY AND BACGUP GENERATORS SHALL BE LOCATED INTEROR TO THE SLIEDING ON VALUETO UNDERGROUND WITHIN THE PACHENT AREA OF AN ADJACENT STREET. LOCATION TOWN THE SIDEMAK, RETWENT THE SIDEMAK AND THE SULCING, OR ANYWHERE OUTSIDE AT GRADES IN OUT PRIMATED.	COMPUE	DOES NOT COMPLY (V)	
}#[A]]{()	ENTRANCES SHALL BE DESIGNED TO BE ATTRACTIVE AND FUNCTIONAL, INDICATORS SUCH AS AWAYING. CHANGE IN 9 DEWALK PANNO (PATERIAL OR OTHER INDICATORS CONSTRUCT WITH THE DESIGN, PROPORTIONS HATERIAL AND CHARACTER OF THE SURVIVIONING PREASHALL BE PROVIDED.	COMPUS	NO CHANGE	
}	A CONNERSTONE MANKING THE DATE OF CONSTRUCTION SHALL BE LOCATED IN AN APROPMATE GROUND LIVE CONNER OF ANY BULDING RIVE OR HORE STONES THE CONNERSTONE SHALL BEINCOROPCANED INTO THE PRIMARY PACADE HATENAL	COMPUES	NO CHANGE	
JEAIS.	ALL NEW SIDEWALK CONCRETE SHALL BE TINTED CHARGOAL GREY OR EQUIVALENT TINT.	COMPLES	NO CHANGE	
}■Att.	ALL STORERONTS SHALL INCORPORATE A CORNICE ELEMENT OR HONZONTAL PROJECTION ABOVE THE STORERONT GLAZING SEPARATING GROUND FLOOR USES FROM THE BULLING ABOVE.	COMPLIES	NO CHANGE	
\$M.F.2	OPEN SPACE SMALL MONDE MISIALA AND PANCHONAL ELEMENTS SIGNAL A BENCHE SMANNE SMANNES S	COMPLES	NO CHANCE	
I III EA	OPEN SPACE SHALL BE DISTRIBUTED SO AS TO PROVIDE FOR HAMHUH USABILITY.	COHRIES	NO CHANGE	
₹MLES.	THROUGH CREATIVE DISCIN, OPEN SPACE FRATURS SHALL ADDREST THE RED FOR HUHAIN COHOOLT AND BINDTYPORT AND PROVIDE BOTH ACTIVE AND FRASTYLE ISSUE USES OR SECULE AND PLEASANT OUTDOOR AND INDOOR SETTINGS TO HEET FURSUE AND PRIVATE USES ROUGHERING OPEN SPACE AND FLASTAS SHALL BE DESIGNED AT A HUHAIN SCALE TO INVITE AND ATTRACT THE PUBLIC.	COMPLIES	NO CHANGE	
\$ III.EA	OFEN SPACE SHALL BE OFFICE OF COST MANY ZE WENG	COMPLES	NO CHANGE	
∤車 差2。	AS A GENERAL GUIDE ONE (I) LINEAR FOOT OF SEATING FOR EACH UNEAR FOOT OF FLAZA FEM METER SHALL BE FROMDED. SEATING SPACE HAY INCLUDE PLANTERL BENCHES FOUNTAINS, ETC.	COHPUS	NO CHANGE	
₩12	BUILDINGS WITH OVER 50 WHITS HUST INCLUDE AT LEAST 2% OF THE UNITS DESIGNED WITH 3 BEDINDOMS ON HORE 2% 2001 WHITS # 5 UNITS	TEN TEN	NO CHANGE	
\$MEO.	BUILDINGS WITH + OR MORE FLOORS MUST PROVIDE AN ELEVATOR	COMPLES	NO CHANGE	
\$ 1 114.	A HINHUM OF JOY OF THE LOT AREA HUST BE DESCATED TO USEABLE RECRESSION SPACE BY OCCUPANTS, OR PLAZE AREA SCENSIBLE BY THE PUBLIC THIS SPACE HAT BE PLACEDIN A REAR YALD OR ON A ROOK ROOF DESCA ARE ENCOURAGED AND MAY BE NECESSARY TO ACHIEVE THIS REQUIREMENT. 325 * LOBB S * 1888 BY	CONFUES 8.258 SF	NO CHANGE	

M VANANCE

DEDICATED TO USEABLE RECREATION SPACE BY		50L CHARACTERISTICS			
OCCUPANTS, OR PLAZA AREAS ACCESSISLE BY THE PUBLIC THIS SPACE HAY BE PLACED IN A REAR YARD		TYPE OF SOIL	UKBAN LAND (UR		
OR ON A ROOF ROOF DECKS ARE ENCOURAGED AND		PERCENT OF SITE COVERAGE	100.0%		
MAY BE NECESSARY TO ACHIEVE THIS REQUIREMENT. 20% - 14,088 SF = 2,818 SF	8.268 SF				
204 14,000 2 - 2010 2	42004				

CODESECTION	REQUIRED	APPROVED	PROPOSED
şing).	LANDSCATING SHALL BE REQUIRED FOX ANY FART OF ANY PARCEL NOT USED FOR BUILDINGS, OFF-STREET PARKING, PLAZA AREAS, OR LOADING ZONES.	COMPUS	NO CHANGE
şin.G2	ALL PLANT MATERIALS USED THIST BE ABLE TO WATERSTAND AN URBANE PRINCENDEN MATERIAL SCIEDN PLANTING SHALL BE ANNAHUM OF A FEIT HIGH. AND SHALL BE MANTED, BALLED, AND BURLAPPED AS BITABLISHED BY THE AMERICAN ASSIGNATION OF NURBENMENE GROUND COVER SHALL BE USED IN PLACE OF PULICH.	Сонив	NO CHANGE
(#GT	ALL NEW TREES SHALL BE OF A SPECIES AND GENDER SO AS TO MINIMZE FRUIT AND POLLEN.	COMPLIES	NO CHANGE
in ce	ANY LANDSCARING WHICH IS NOT REISTANT TO THE ENVIRONMENT OR CLES WITHIN 2 YEARS OF PLANTING SHALL BE REPLACED BY THE DEVELOPER	COMPLIS	NO CHANGE
l∎er	UNDERGROUND WATERING FACULTES SHALL BE REQUIRED FOR ALL LANDSCAFED AREAS MOSE & S SHALL BE REQUIDED IMMEDIATELY ADJACENT TO FLANTING AREAS ABUTTING A BULLING	COMPUS	NO CHANGE
jag.≰	STREET TREES SHALL BE PLANTED ALONG CURB UNES OF TREETS IN A REGULAR PATTERN. SPACED AT ONE-MLAT THE HATURES BRIDGO OF THE TREE CANOPY TO FURTHER ENHANCE THE ABSTHERE QUALITY OF THE REDEVELOPMENT AREA ALL TREES SHALL BE ATMINIUM OF FOUR (I) INCRESIN CAUPER.	сонғұз	NO CHANGE
ja c.e.	ALL ANDISCAPING MUST BE FILLY BYCLOSED BY CURB OR SEATING WAIL CONSTRUCTED OF MASONIY OR HEFAL MASTINAL WITH A PHINHUM OF SINCH IN HIGHT IN LANDSCAPING SWALL SE BLEVATED TO HATCH THE HIGHT OF THE CUM OR SKRING WAIL TENGROSS DISCOURAGED, SUT HAY BE SET MITO THE REQUED CON SOUTHAY BE SET	COMPUS	NO CHANGE

LANDSCAPING REQUIREMENTS

LANDSCAMING NOTES

- THE CONTRACTOR SHALL RESTORE ALL DISTURBED CRASS AND LANDSCAPED AREAS TO HATCH EDISTING CONDITIONS INJUSTMENT OF THE WAY SET THE CONTRACTOR SHALL RESTORE ALL STRUME LAND STATE A THANKIN FIRST LAYER OF THOSE AND SEED. THE CONTRACTOR SHALL RESTORE ALL STRUMES THANKING SHARLS. THE PROPERTY OF THE PROPERTY AND STATE AND STATE OF THE PROPERTY HAS THE PROPERTY OF THE PROPERTY HAS THE PROPERTY OF THE STATE OF THE
- CONSTRUCTION, THE CONTRACTOR BUILL RELOCATE SPRINKER HEARS AND UNION ACCORDANCE WITH OWNERS HERCELON WITHIN AREAS OF DISTRIBUTION. ILL STRUMENT LANGUAGE AREAS, ARE CARROLT TO HER THE HEAR AT THE REVAILON OF WALKWART AND TOP OF CHER BEYATIONS DECEPT UNIONS DECENT OWNERS HIGGATED OTHERWISE WITHIN THE PLAN BY, HIGH AND AND AND AND AND AND AND HEART BOTH OF THE PLAN BY.

- BILATION SPECIACIONS.

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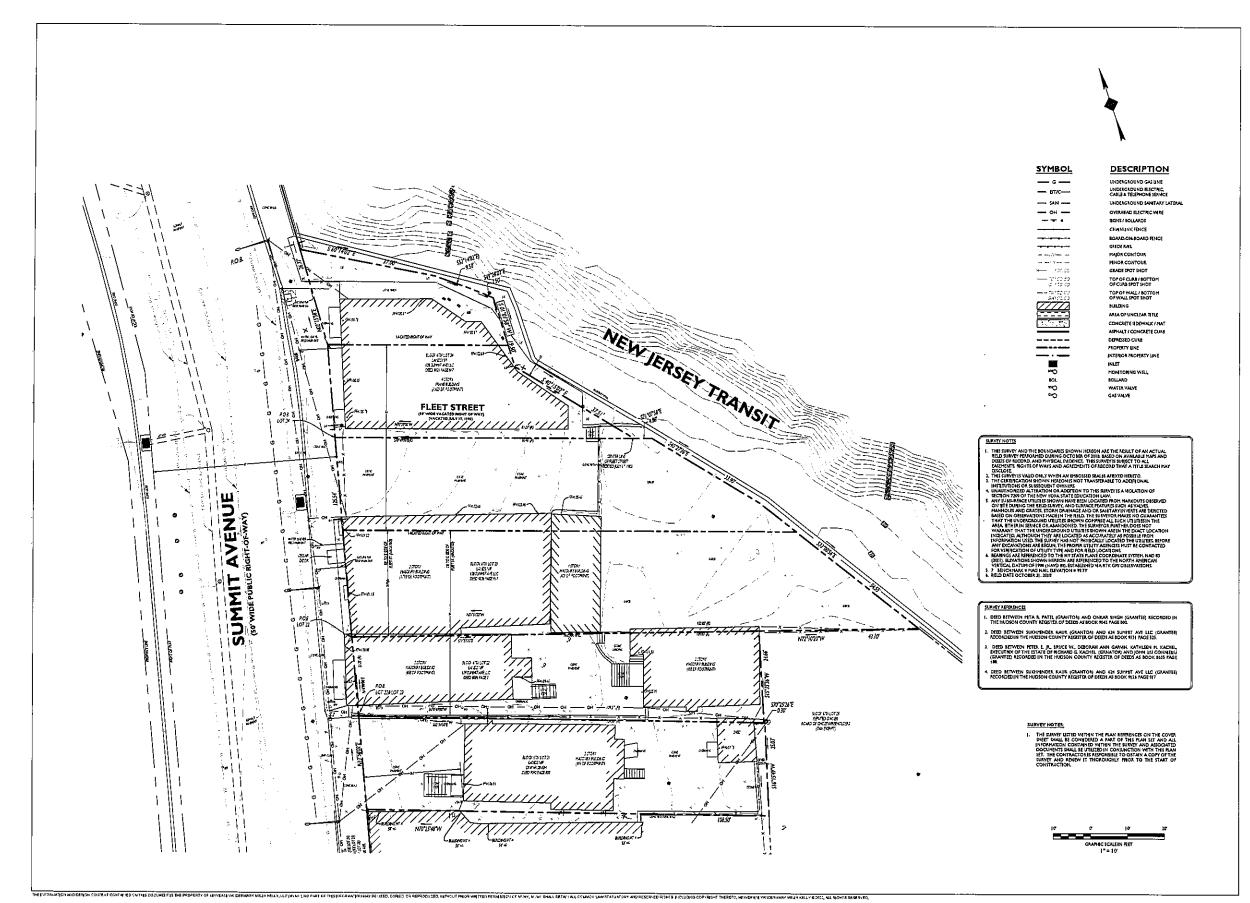
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SEAL
Frank J. Minervini, AJA
(Ulberne a 1535)
(Frank B 2003)
Anthony C. Vanderm
(Ulberne a 154)
(Cur why 8 27 151
Addison Melia, MA
(Ulberne a 157)



Cl.D.Cl. CHARLES D. OLIVO, P.E. 184 9-31-128-914-4-11 40-40-40-40-40-41-4-11

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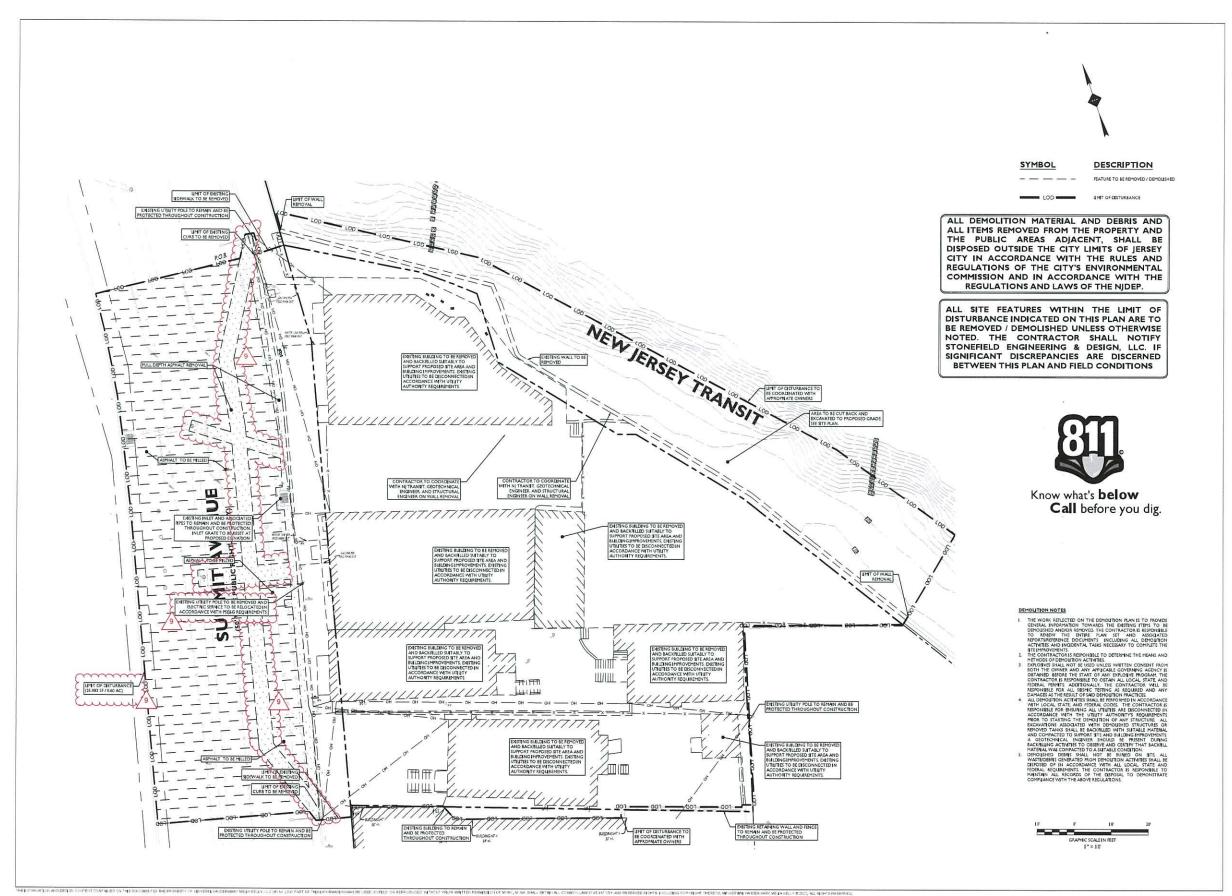
SUMMIT TOWER

622-628 SUMMIT AVE JERSEY CITY, NEW JERSEY 07306 BLOCK 6701, LOT 21,22,23 & 24

Project Description
PROPOSED NEW MIXED USE
BUILDING WITH 209 RISIDENTI.
UNITS, 2 RETAIL UNITS, & 2
COMMERCIAL FLOORS

Sheet Title EXISTING CONDITIO

C-3



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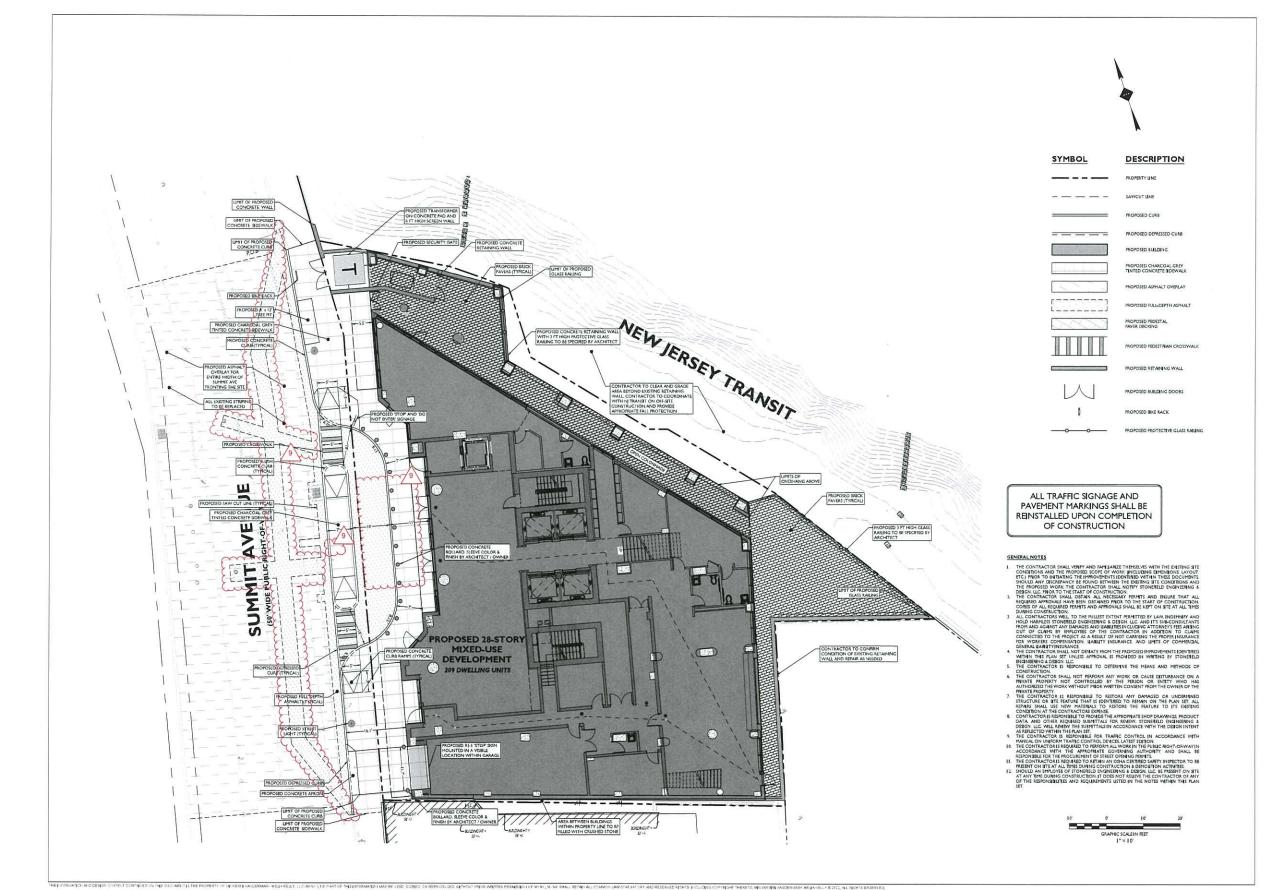
Claran Kelly, AlA

STONEFIELD

cl D. Cli CHARLES D. OUVO, P.E.

SUMMIT TOWER

Sheet Number C-4





300 14th St., Habaten, NJ, 07030 T. 201-336-0637 E. mfo@mymkarchitecture.com www.mymkarchitecture.com

SEAL
Fronk J. Minervini, AIA
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STONEFIELD Fabrica 18 | Fav Sub, lot married 18 | Surpa A. | Extrem 18 www.thantiding.com

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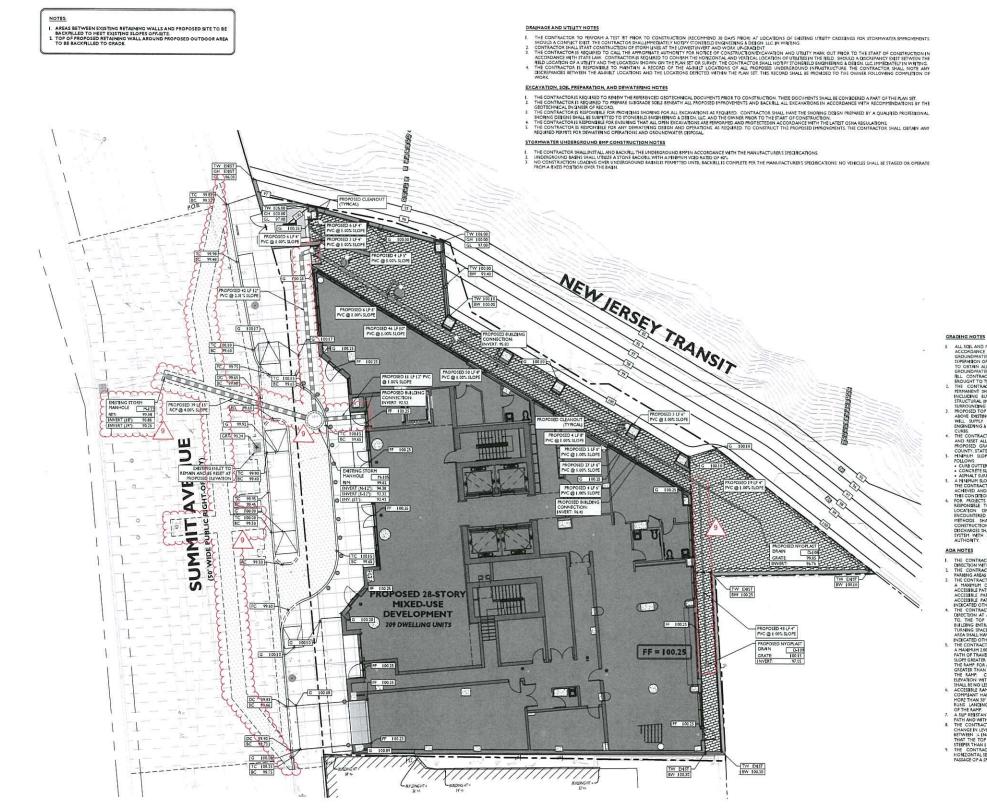
CHARLES D. OUVO, P.E.

	07/20/2022	REVISED DRAINAG
	06/20/2022	AMENDED HNAL
	U6/20/2022	SITE PLAN
	05/12/2022	REVISED GRADING
Ī	04/22/2022	JCMUA REVISIONS
	03/25/2022	JCMUA REVISIONS
	09/03/2021	ISSUED FOR BID
	07/02/2021	CD 90%
	06/07/2021	CD 75%
	04/09/2021	CD 50%
	Date	Issue

SUMMIT TOWER

Sheet Title SITE PLAN

Sheet Number C-5





DESCRIPTION SYMBOL RIDGELINE × G 100.00 # TC 100.50 BC 100.60 H-FC 100.00 PROPOSED FLUSH CURB SPOT SHOT BC 100.00 PROPOSED DEPRESSED CURB / BOTTOM OF CURB SPOT SHOT # TW 102.00 BW 100.00 PROPOSED TOP OF WALL / BOTTOM OF WALL SPOT SHOT • 🖸 🚳 PROPOSED STORMWATER STRUCTURES PROPOSED STORMWATER PRING

- ADA NOTES

 THE CONTRACTOR SHALL MARY AN A MARKHUR 280'S SLOTE 19 ANY DIRECTION MATTER THE ADA HANNING SHACES AND ACCESS MARES.
 THE CONTRACTOR SHALL PROVIDE COMPLIANT SEGMED STATE ALL ADA PARAMA AREA THAT AND ADAPTICATE SHALL PROVIDE COMPLIANT SEGMED STAN AND ADAPTICATION OF THE ACCESSIBLE PATH OF TRAVEL SEE THE STE HAN FOR THE LOCATION OF THE ACCESSIBLE PATH OF TRAVEL SEE THE STE HAN FOR THE LOCATION OF THE ACCESSIBLE PATH OF TRAVEL SEE SHILDER MADE ON GREATER WINLESS AND ADAPTICATION OF THE ACCESSIBLE PATH OF TRAVEL SEE SHILDER MADE ON GREATER WINLESS AND ADAPTICATION OF THE ACCESSIBLE PATH OF TRAVEL SEE SHILDER MADE ON GREATER WINLESS AND ADAPTICATION OF THE ACCESSIBLE PATH OF TRAVEL SEE SHILDER MADE ON GREATER WINLESS AND ADAPTICATION OF THE ACCESSIBLE PATH OF TRAVEL SEE SHILDER SHILDER SHILDER AND AN ACCESSIBLE MAPP. AT ACCESSIBLE THAT OF TRAVEL THE LANGING MADE AND ADAPTICATED CHIEFMAN AND ADAPTICATED SHILDER SHILDE
- P. TANT SURFACE SHALL BE CONSTRUCTED ALONG THE ACCESSIBLE



MVMK

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SEAL
Frank J. Minervint, AJA 10 Ucesse # 12576 11/ Ucesse # 03 0297 48
Anthony C. Vondermork, ir. AlA in license # 17494. Influence # 32" (3-1
Adrian Melia, AIA




CHARLES D. OUVO, P.E.

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Project Title SUMMIT TOWER

Sheef Number

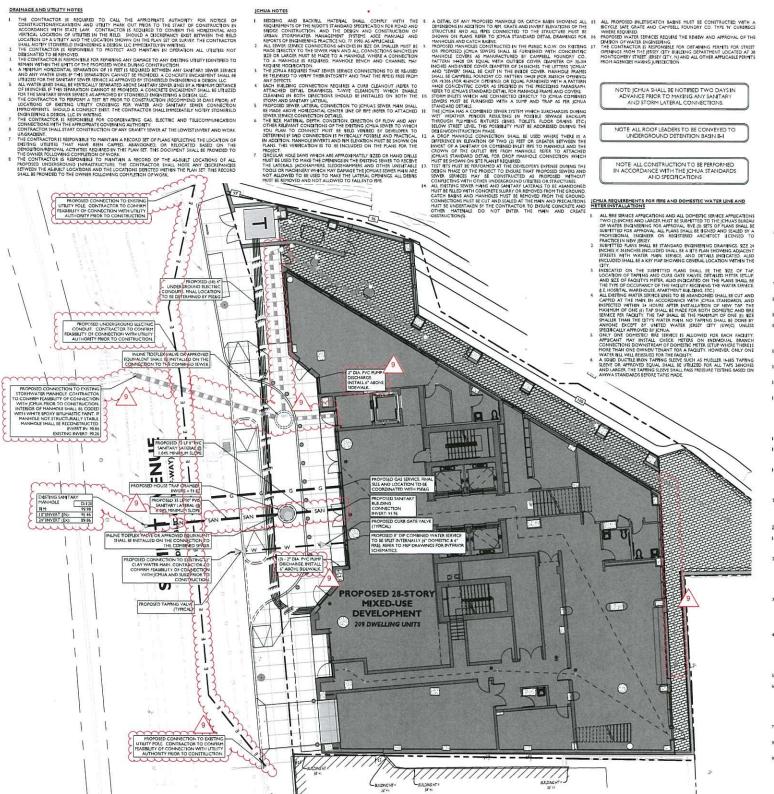

ICMUA NOTES

DRAINAGE AND UTILITY NOTES

CHUA REQUIREMENTS FOR FIRE AND DOMESTIC WATER LINE AND METER INSTALLATIONS (CONT.)

- FOR TAPS OFF MAINS EXTEEN (16) INCHES AND LARGER THE APPLICANT SHALL FUNNISH AND INSTALL AN ADDITIONAL GATE VALVE ADJACENT TO THE TAPRING VALVE. NO TAPS SHALL BE
- TATHING VAIVE NO TATS SHALL SE
 PREMITTED ON TAMIN LAKING THAN TWENTY (38) INCHE UNLESS THERE IS
 NO ALTERNATIVE WATER SOURCE AND STECAL WRITTEN APPROVALSISSUED
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 VALVE BOY PREMISTOR ALL VAILES SHALL SE REPOUNDED OF THE APPLICANT.
 VALVE BOY PREMISTOR ALL VAILES SHALL SE REPOUNDED OF THE APPLICANT OF THE
- TAP YON CLASS K COPPRESENDED SINGHER AND SPALLER

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 CLASS 30 PS CEMENT-UP DUCTILE BON HE WITH HECHANICAL CHITS.

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- STREET.
 ALLINSTALLATIONS OF EQUIPMENT AND COMPONENTS SHALL BE PERFORMED IN ACCORDANCE WITH HAMUPACTURES RECOMPRISEDATIONS.
 ALL INTERNALIZATIONS OF MODULES AND ADMIN ONLY UNITS SHALL BETTER THE PERFORMENT OF THE

CMUA WATER DISTRIBUTION SYSTEM STANDARDS

- CHUA WATER DISTRIBUTION SYSTEM STANDARDS

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- RECOESTAND THE BOTTON A CHEMPTON THE STREET OF ASSOCIATION THE STREET OF ASSOCIATION OF THE STREET O

SYMBOL

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 SPICIAL AND HAVE MODER ACCESS OFFINIOS FOR HERE RESIGNO AND
 EACH COMPOUND HERE SHALL HAVE TEATHER BY MALE ON THE BILLT
 SOE INHESEATELY SEPORE THE METER ALL STAMMES MUST SE PURCHASED
 FROM SCHOLD AND ADDRESS AND AGENT
 AND LANGER SHALL SE FUNDATION OF RESIDE SCHOOL
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 ALL METERS 2" AND LANGER SHALL SE FUNDATION OF RESTOR SOTH THESE OF
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 OF SENTIAL STORY OF SENTIAL STORY OF SENTIAL STORY
 THESE THE AGENT OF SENTIAL AND CONFIDENTISTALL SHE RESORMED.
- PEMITS

 19 ATER OSTANING THE REQUIRED PEMITS (STREET CHENING, TAP, AND METER)
 THE APPLICANT SHALL CALL LWIG AT (PS) 2394 (10 TO SCHEDULE THE TAP
 THE SCANDING SHALL BE COMPRETED TYMENT-CARGO, HIGH HOURS MIGHT OF
 THE SCHEDULED TAP, AND VERHIED BY JCTIMA OR ITS AUTHORIZED AGDIT
 THE SCHEDULED TAP, AND VERHIED BY JCTIMA OR ITS AUTHORIZED AGDIT
 ACCORDANCE WITH GOAR ACCUSTRENTS FOR A HERITAL AND ARTHTHE (F) IS TO FAS BULLT THAN SO THE FORMAL SUPPLY
 THRE (F) IS TSO FAS BULLT THAN SO THE JCTIMAS BURBAU OF WATER
 ENGREENING THE SCHULA WILL AUTHORIZE SUPPLY WATER UPON
 ACCEPTANCE OTHER AS BULL TORAMHOS.

- THE RODS SHALL BE THREE QUARTER (3/4) INCH CHAMETER THREADED STEEL BARS. RODS SHALL HAVE A MINMUM YIELD STRESS OF 36,000 PS. THRUST BLOCKS AND THE RODS SHALL BEINSTALLED AT ALL BENDS AND RITINGS.



DESCRIPTION

	PROPERTY LINE
SAN	PROPOSED SANITARY LATERAL
— w —	PROPOSED DOMESTIC WATER SERVICE
— r —	PROPOSED FIRE SERVICE
E/T/C	PROPOSED ELECTRICAL/DATA CONDUITS
—— G ——	PROPOSED GAS UNE
(G) •	PROPOSED SANITARY MANHOLE /

[CMUA WATER DISTRIBUTION SYSTEM STANDARDS (CONT.)

- CHUA WATER CISTIBILITION SYSTEM STANDARDS (CONT.)

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- THE WATER MANS.
 ALL WATER MANS MALE SEAT LEAST IF IN DIAMETER. THN [167] AND
 ALL WATER MANS MALE NOT BE USED.
 THOUST BLOCK AND THE ROOS SHALLE BYSTALLED AT ALL BENDS
 AND MANS.
 AND THE STATE OF THE STATE OF THE STATE OF THE STANDARD.
 THE MAN THE MAN AND THE STANDARD THE STANDARD THE MAN AND THE STANDARD THE ST
- FOR BITHER NEW CONSTRUCTION OR RELOCATION OF THE FOLLOWING SHALL BE REGULARD:
- POR BETHER NEW CONSTRUCTION ON REGISCATION OF THE ADDRESS OF THE STATE OF THE STATE

- HYDAAT.

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 WATER HANN TO ASAMPON SHALL BE CUT AND RUGGED WITH SECTION OF THE SEMICES AND COLOR OF THE SEMICES OF THE SE
- 22. FALURE TO COMPLY WITH THE ABOVE REQUIREMENTS WILL RESULT IN THE IMMEDIATE SHUTLDOWN OF THE PROJECT.



MVMK

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Frank J. Minervint AJA

Adrian Melia, AIA



CHARLES D. OUVO. P.E.

9 07/20/2022 REVISED DRAINAGE AMENDED FINAL 8 06/20/2022 AMENDED FINA SIE PLAN 7 05/12/2022 REVISED GRAD 6 04/22/2022 JCMUA REVISE 6 04/22/2022 JCMUA REMBUND 5 03/25/2022 JCMUA REMBUND 4 09/03/2021 ISSUED FOR RID 3 07/02/2021 CD 99% 2 04/07/2021 CD 59% 1 04/09/2021 CD 50% 8 Date Issue


SUMMIT TOWER

Project Description

Applicant

Project Title

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JCMUA NOTES

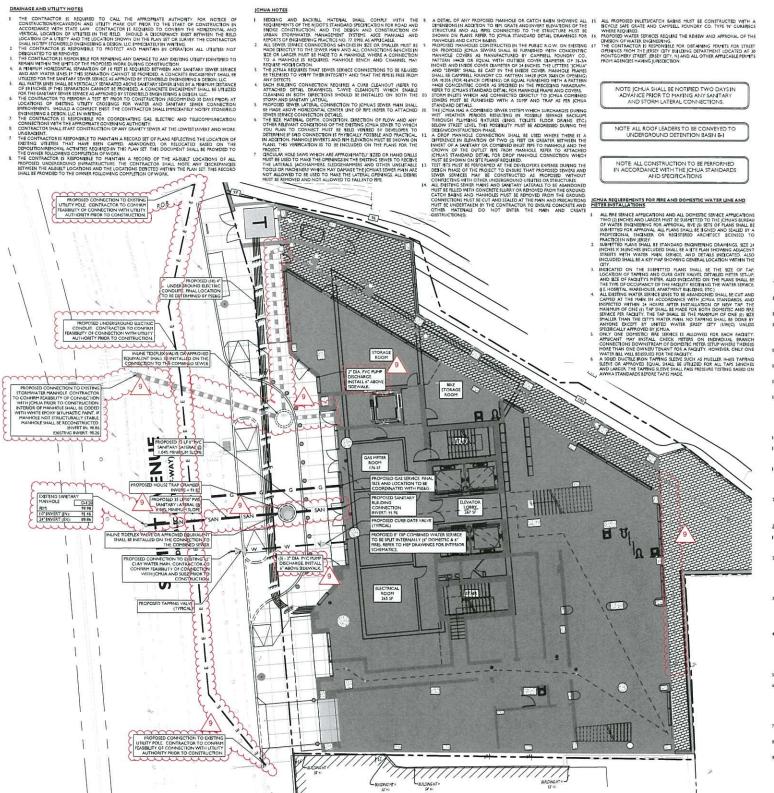DRAINAGE AND UTILITY NOTES

ICMUA REQUIREMENTS FOR FIRE AND DOMESTIC WATER LINE AND METER INSTALLATIONS (CONT.)

- IN THE COVER. BURBLO CORPORATION VALUES STOPS SHALL BE USED AT THE TATAPHO, CALLS SCOPEN SERVED, BANCERS AND SHALL BE INSTANCE.

 CALS SEP ST. CENERALINED DUCTILEBON REW WITH MECHANICAL SHATE.

 THE APPLICANT SHALL BETTALL THE METER INDEE THE BULCTURE. IF THE BULCTURE SHATE BETTALL THE BULCTURE SHATE SHATE

- ICHUA WATER DISTRIBUTION SYSTEM STANDARDS

 1. WATER MINS SHALE ELASS 32. CHEMIT UHED, DUCHEL JRON, JPF, WITH HICHARCAL (CHITS AND SHALL SE IN COMPRIANCE WITH ANS STANDARD ASIA STANDARD CASTON SHALL SE HOURDON, AND SHALL SE JERCE STANDARD VALVES MAN METROPOUT AN MICHARCAL (CHIT MANNES AND LES HON-MENSOR STEM RECHANGAL (CHIT MANNES AND SHALL SE JOS SHAD DE RESISTEM CONTINUED AND STANDARD COMPANY OR APPROVED COLATED WITH SEPARS. VALVE SHAUL SE JOS SHAD OWER SHALL SE HOM-MONTH OF THE MENSOR OF THE MANNES AND SHAUL SE JOS SHAUL SE HON-MENSOR WITH AND JOS SHAUL SHAUL SHAUL SHAUL SHAUL SHAUL SHAUL SHOW HAS AND SHAUL SHAUL SHOW AND HAS AND SHAUL SHAUL SHOW AND SHAUL SHAUL SHOW HAS AND SHAUL SHAU
- CONCRETE FOR WALVE SAFT AND THRUST BLOCKS SHALL HAVE A MINIMUM ES SELECT GRANULAN BACKELL METRIAL SHALL BE SUL AGGESEATE THY BE FOROUS FILL CLEAN SAND. GRAVEL OR TONIO OSTANDO FROM DRY SOURCES AND SHALL BE FREE FORO THUMES, BLUME VIEWED, ROOTS, NUBBEN SOURCES AND SHALL BE FREE FOR THUMES, BLUME VIEWED, ROOTS, NUBBEN SHALL BE FREE FOR THIS SHALL BE FREE OF OTHER PROBLEMS OF CONCOMN TO TABLE MIN. FOR TYPE-JAIN ARRILLE SHALL OF OT THE RNJ DO TO RNG WISEST DEPARTMENT OF THAT SHALL BE FREE TO AND COPPACTED IN TWEETER (3) HINCH SHALL HATERIAL SHALL BE FRACED AND COPPACTED IN TWEETER (3) HINCH SHALL BE THERE CHART AND HINCH THE THREADED STEEL BASK FORD SHALL MAY A MINIMUM HELD STEED OF 1400 PM. THRUST ENCOSES AND THEORY SHALL BE WITH ALL OF ALL SENDERS AND PITTINGS.
- STEEL COUPRING SPALL BE USED.

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 SHERING SHORING AND BRACHIS TO MERINET THE CARRISH OF

 CONTRACTED AS ALL LAWAR ROLLINGS AND HER SHORING OF THE UNITED

 CONTRACTED ON SHALL COMPONE TO THE SEQUEREMENTS OF THE UNITED

 TATES OCCUMENTAL RESETS AND HEALTH ADDRESS AND HERHOLDS OF

 FOR SHERING SHALL BE TORIUS AND GROOVE WOODEN HAVES AND

 STATES OCCUMENTAL SHERT AND HEALTH ADMINISTRATION THISSES SHALL

 BE A HARMUN OF 3' THEKE, SHERTING SHALL BE LEFT IN RACE SHORING AND

 BRACHIG SHALL BE REMOVED.

- STREET.
 ALLINSTALLATIONS OF EQUIPMENT AND COMPONENTS SHALL BE PERFORMED IN ACCORDANCE WITH HAMUPACTURES RECOMPENDATIONS.
 ALL HETEROLICULENES TOUCH ON PROJUCES AND LAND ONLY UNITS SHALL ALL HETEROLICULENES TOUCH ON PROJUCES AND AND MAY UNITS SHALL SHALL BE AND A SHALL SH
- PRINTS

 19 ATER OSTANING THE REQUIRED PENTS (STREET OPENING, TAP, AND INTER)
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 THE ECKANING SHALL BLOOPINGTED TYPETH-YOUR OR HIS WORD FIRD THE SCHEDULED TAP, AND VERHILD BY CHUIL OR HIS WORD FIRD FIRST
 THE SCHEDULED TAP, AND VERHILD BY CHUIL OR HIS WORD FIRST SHALL THE CHEDILED TAP, AND VERTILE THE CHIEF CONTINUE AND SAFET.

 30. JUPON COPINETION OF THE INSTALLATION, THE APPLICANT SHALL SHAPL
 THEE (5) SETS OF AS BULLT "HARA. TO THE JOYANE SURFALL OF WATER
 ENGREEMENT THE SPUIJA WILL AUTHORIZE SUPPLY WATER UPON
 ACCEPTANCE OF THE SE BULLT PRACHINGE.

ICHUA WATER DISTRIBUTION SYSTEM STANDARDS

- GOUPLINGS SHALL BE INSTALLED AT ALL BENDS AND RITTINGS.
 COUPLINGS SHALL BE DRESSER STYLE NUMBER 153 FOR RIFE SIZES THROUGH
 307 INCH DIAMETER. FOR LARGER DIAMETER RIPE DRESSER STYLE NUMBER 38
 STEEL COUPLINGS SHALL BE USED.



DESCRIPTION

	PROPERTY LINE
SAN	PROPOSED SANITARY LATERAL
— w —	PROPOSED DOMESTIC WATER SERVICE
— F ——	PROPOSED FIRE SERVICE
—— E/T/C	PROPOSED ELECTRICAL/DATA CONDUTS
—— G ——	PROPOSED GAS LINE
(6)	PROPOSED SANITARY MANHOLE / CLEANOUT

SYMBOL

[CMUA WATER DISTRIBUTION SYSTEM STANDARDS (CONT.)

- CHUA WATER DISTRIBUTION SYSTEMSTANDARDS (CONT.)

 1. BROKEN STONE FOUNDATION CUSHON SMALL BE PLACED IN THE STATE OF THE STA

- HIDDARY THANNE SHALL BE A MANINUM 199 FEET MEAURED CENTER TO CONTROL ON THE MEAURED CENTER OF CONTROL ON THE STATE OF THE

- INDIANT.

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- VALVE OPERATING REQUIREMENTS.

 22. FALURE TO COMPLY WITH THE ABOVE REQUIREMENTS WILL RESULT IN THE IMMEDIATE SHUTLOWN OF THE PROJECT.



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Adrian Melia, AIA



9 07/20/2022 REVISED DRAINAGE AMENDED FINAL 9 (07/20/20/2) (BEVISED DARMACO)
5 (04/20/20/2) (AMES) (DED TRAAL
7 (04/12/20/2) (EVISED GRADING
6 (04/22/20/2) (EVISED FOR BE)
7 (04/20/2) (EVISED FOR BE)
8 (Date (14/20/2) (EVISED DARMACO)
8 (Date (14/20/2) (EVISED DARMACO)
9 (EVISED DARMAC Project Title

SUMMIT TOWER

Project Description PROPOSED NEW MIXED US BUILDING WITH 209 RESIDE UNITS, 2 RETAIL UNITS, & 2 COMMERCIAL FLOORS

Sheet Number

PROPOSED LUMINAIRE SCHEDULE							
SYMBOL	LABEL	CUANTITY	SECURITY LIGHTING	DISTRIBUTION	LLF	MANUFACTURER	IES ALE
B	^	25	WILLIAMS 4DS DOWNLIGHT LTO OW-OF-CS 3000K	ow	0.90	HE WILLIAMS. INC.	4DLLIMIADINUMOMORCIAI
•	В	14	CAMMAN LIGHTING OW610-24 CARLISLE 3000K	N/A	0.90	CAMMAN	CAHHAN OWN DZELINIES
Ø	с		PHUPS HADOO SIGNATURE LED. T3, 88W, BLACK RINISH	TYPEIN	0.90	PHILIPS HADCO	#F3ExDxxxxxxxxxxxxxxxxxxxxxxxxxxxxxxxxxxx

	LIGHTING REQUIREMENTS	
CODE SECTION	REQUIRED	PROPOSED
5 M F.2	ADROUATE LIGHTING SHALL BE PROMORD TO ENCOURAGE ACTIVE USAGE AND A SENSE OF SECURITY IN THE OPEN SPACE	COMPLIES
∤∭ G 7.	UIGHTING WITHIN THE SITE SHALL SUFFICIENTLY ILLUMINATE ALL ALEAS INCLUDING THOSE AREAS WHERE BUILDING ARE SETBACK OR OFFSET TO PREVENT DARK CORNERS	COMPLIES
₹ m .GR	ALL LIGHTING SOURCES HUST BE ADEQUATELY SMELDED TO AVOID ANY OFFISTE GLARE. THE AREA OF HULLIHARDON SHALL HAVE A UNFORM PATTERN OF AT LEAST ONE-HALF (63) FOOT CANDILE.	27 FC AVERAG
1747-69 2 67	MARAHUM BIGHTING INTENSITY AT PROPERTY LINE SHALL BE 85 FOOT CANDLES	0.4 FG

GENERAL LIGHTING NOTES

- THE UNITING LEVEL DEFICITED WITHIN THE PLAN SET A CACILLARIED UTILIZED DATA OSTANDER FROM THE LIST AND INCIDENT ACTUAL LIVEN HATCH LIVES AND PRICE PRO-UNCONTROLLARIE SHAPE AND ACTUAL PROPERTY OF UNCONTROLLARIE SHAPE AND WISHING YOUR SUPPLY, LAW TOLEMANCE FOUR PRIVING SEMCE LIFE AND OTH VANABLE RELD CONCISIONS.
- THE FLAN SET SHALL BE CONSIDERED APPROXIMATE THE ENSTHICE UGHT LEVELS ARE BASED ON FIELD COSERVATIONS AND THE MANUSACTURERS DATA OF THE ASSUMED ON MOST EMILAR UGHTING RETURE MODEL.
- HIGHT ENTTING DIODES (LED): 0.40
 HIGH RESSURE SOCION: 0.72
 HIGH RESSURE SOCION: 0.72



SYMBOL

DESCRIPTION

A (XX)


MOPOSED LIGHTING RXTURE (MOUNTING HEIGHT) PROPOSED LIGHTING INTENSTY (POOTCANDLES)

=

PROPOSED BUILDING HOUNTED 13



CANOPY LIGHTING FIXTURE TYPE 'A'

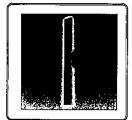

WALL LIGHTING FIXTURE TYPE 'B'



AREA LIGHTING FIXTURE TYPE 'C'



MVMK

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Frank F. S. Minervial
Anthony C. Vondermork, Jr. AIA
Frank F. S. Minervial
Frank F. S. Minervial
Action Melio, AIA



Ciaron Kety, AlA Kilik Man & 1844

CHARLES D. GUVO. PE

07/20/2022 PEVISED DRAINAGE
04/20/2022 PEVISED DRAINAGE
04/20/2022 REVISED GRADINO
05/12/2022 PEVISED GRADINO
05/25/2021 REVISED GRADINO
05/25/2021 REVISED GRADINO
05/25/2021 REVISED FOR PD
07/25/2021 CO 90X

Project Title
SUMMIT TOWER
622-625 SUMMIT AVE
1ERSEY GITY, NEW JERSEY 07304

PROPERTY OF STATE OF

App@cont 626 SUMMIT AVE, LLC

Project Number: T-18276
Drawn by : K5
Checked by : AK
Scale : As Noted
Sheef Title
Udffilled PLAN

LIGHTING PLAN

C-9

