127 DELAWARE

PRELIMINARY AND FINAL SITE PLAN SUBMISSION

NEW 5 STORY MULTI-FAMILY HOUSING WITH GROUND FLOOR PARKING 127 DELAWARE AVENUE, JERSEY CITY, NJ BLOCK: 16202 / LOTS: 19





JOAQUIN BOUZAS ALEXANDER MERLUCCI ANTHONY D'AGOSTA III

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NJ AI01637300

OF INGLESE ARCHITECTURE + ENGINEERING

ZONING COMMENTS 01.12.2021



SURVEYORS NOTES

PROPERTY BOUNDARIES AND EXISTING CONDITIONS WERE TAKEN FROM A SURVEY DATE AUGUST 7, 2019, BY PRONESTI SURVEYING, INC. PROFESSIONAL LAND SURVEYORS, FOR CHANDRANI REALTY LLC.

GENERAL NOTES

1. LOCATIONS AND TYPES OF UTILITIES SHOWN HEREON ARE DERIVED FROM FIELD LOCATION AND AVAILABLE UTILITY MAPS. PRIOR TO ANY EXCAVATION CONTACT THE CITY OF JERSEY CITY'S ENGINEER'S OFFICE, SEWER, AND WATER DEPARTMENTS, THE LOCAL CARRIERS OF TELEPHONE AND CABLE, AND PUBLIC SERVICE ELECTRIC & GAS CO.

FOR LOCATION, DEPTH AND MARK-OUT OF UTILITIES YOU MUST CALL 800-272-1000

- 2. ALL ELEVATIONS AND CONTOURS SHOWN ARE EXISTING AND ARE BASED ON NAVD 88, DERIVED FROM GLOBAL POSITIONING SYSTEM, (GPS). SAID ELEVATIONS BASED ON THE "CONTINUOUSLY OPERATING REFERENCE STATION" (CORS), POSITIONED AT NJIT.
- 3. TOTAL LOT AREA = 12,920 SQ. FT. OR 0.297 ACRES.
- 4. THIS SURVEY IS SUBJECT TO THE FACTS AND FINDINGS OF A COMPLETE TITLE SEARCH.
- 5. THIS SURVEY IS NOT VALID UNLESS SIGNED AND SEALED BY THE LICENSED SURVEYOR.
- 6. PER THE NATIONAL FLOOD INSURANCE PROGRAM MAP NO. 34017C 0102D WITH AN EFFECTIVE DATE OF AUGUST 16, 2006 THE PROPERTY SHOWN HERE ON FALLS IN ZONE X AND DOES NOT FALL IN A SPECIAL FLOOD HAZARD AREA.

DESCRIPTION

BEGINNING AT A POINT IN THE WESTERLY SIDELINE OF DELAWARE AVENUE, SAID POINT BEING DISTANT 100.00 FEET NORTHEASTERLY FROM THE CORNER FORMED BY THE INTERSECTION OF THE NORTHERLY SIDELINE OF KENSINGSTON AVENUE AND SAID WESTERLY SIDELINE OF DELAWARE AVENUE; THENCE RUNNING.

1) NORTH 39 DEGREES 30 MINUTES 00 SECONDS WEST, 80.00 FEET TO A POINT, THENCE

2) NORTH 50 DEGREES 30 MINUTES 00 SECONDS EAST, 6.50 FEET TO A POINT, THENCE

3) NORTH 39 DEGREES 30 MINUTES 00 SECONDS WEST, 120.00 FEET TO A POINT, THENCE

4) NORTH 50 DEGREES 30 MINUTES 00 SECONDS EAST, 62.00 FEET TO A POINT, THENCE

5) SOUTH 39 DEGREES 30 MINUTES 00 SECONDS EAST, 200.00 FEET TO A POINT ON THE AFORESAID WESTERLY SIDELINE OF DELAWARE AVENUE, THENCE

6) SOUTHERLY ALONG SAID SIDELINE, SOUTH 50 DEGREES 30 MINUTES 00 SECONDS WEST, 68.50 FEET TO THE POINT AND PLACE OF BEGINNING.

THE ABOVE DESCRIBED PARCEL CONTAINS 12,920 SQUARE FEET OR 0.297 ACRES OF LAND.

			 Surveyor's legend		
			JOHNETOTTO LEGEND		
OHW OVERH		- x - x - + 76.25	DIRECTION OF SEWER FLOW FENCE SPOT ELEVATION EXISTING CONTOUR LINE	。V 。OF 。WV 。GV 。MW	UNMARKED VALVE OIL FILL CAP WATER VALVE GAS VALVE MONITORING WELL
© ELECTF S SANITA O UNMAF	RIC MANHOLE IRY MANHOLE RKED MANHOLE I DRAIN MANHOLE BASIN	₩ ₩ ***	TRAFFIC LIGHT DECIDUOUS TREE (TREE DIAMETER) EVERGREEN TREE (TREE DIAMETER) CONCRETE ASPHALT	₩	FIRE HYDRANT SIGN POST LIGHT POLE UTILITY POLE PARKING METER

<u>DEMOLITION NOTES</u>

- CONFORM TO APPLICABLE CODE FOR DEMOLITION WORK, DUST CONTROL AND PRODUCTS REQUIRING ELECTRICAL DISCONNECTION.
 THE DEMOLITION PLAN IS TO PROVIDE GENERAL INFORMATION. THE CONTRACTOR SHALL REVIEW THE DRAWING SET, REPORTS, ANY
- 2. THE DEMOLITION PLAN IS TO PROVIDE GENERAL INFORMATION. THE CONTRACTOR SHALL REVIEW THE DRAWING SET, REPORTS, ANY REFERENCE DOCUMENTS, AND TASKS REQUIRED TO COMPLETE THE SITE IMPROVEMENTS

 3. THE CONTRACTOR IS RESPONSIBLE TO OBTAIN ALL REQUIRED PERMITS FROM ALL AUTHORITIES HAVING JURISDICTION. THE CONTRACTOR MUST ENSURE THAT ALL DEMOLITION ACTIVITIES ARE PERFORMED IN ACCORDANCE WITH LOCAL, STATE, AND
- FEDERAL CODES.
 4. THE CONTRACTOR IS RESPONSIBLE TO COORDINATE WITH THE LOCAL UTILITY AUTHORITY TO DISCONNECT ALL UTILITIES PRIOR TO
- COMMENCING ANY DEMOLITION WORK. CONTRACTOR TO MARK THE LOCATION AND TERMINATION OF SAID UTILITIES.

 5. CONTRACTOR SHALL BE RESPONSIBLE FOR THE MEANS & METHODS OF OFF-SITE DISPOSAL AND DEMOLITION ACTIVITIES.
- 6. THE CONTRACTOR SHALL BE RESPONSIBLE TO OBTAIN APPROPRIATE PERMITS AND REMOVE ALL DEBRIS ON SITE AND DISPOSE OF ALL DEBRIS IN ACCORDANCE WITH LOCAL, STATE AND FEDERAL REGULATIONS. DO NOT BURN OR BURY ANY WASTE ON SITE. THE CONTRACTOR IS TO MAINTAIN RECORDS OF ALL WASTE REMOVAL TO DETERMINE COMPLIANCE WITH SAID REGULATIONS.
- CONTRACTOR TO LEAVE SITE IN CLEAN CONDITION.
 7. DO NOT CLOSE OR OBSTRUCT EGRESS WIDTH TO ANY BUILDING OR SITE EXIT.
- DO NOT CLOSE OR OBSTRUCT EGRESS WIDTH TO ANY BUILDING OR SITE EXIT.
 THE CONTRACTOR IS TO PROVIDE, ERECT AND MAINTAIN TEMPORARY BARRIERS AND SECURITY DEVICES.
 THE CONTRACTOR IS RESPONSIBLE TO CONDUCT DEMOLITION OPERATIONS AS TO MINIMIZE ANY INTERFERENCE OR DAMAGE TO
- ADJACENT STRUCTURES. CONTRACTOR TO PREVENT MOVEMENT OR SETTLEMENT OF ADJACENT STRUCTURES. THE CONTRACTOR IS RESPONSIBLE TO IDENTIFY AND PROVIDE ANY SHORING OR BRACING TO MAINTAIN ADJACENT STRUCTURES INTACT.
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 10. THE CONTRACTOR IS TO CEASE OPERATIONS IMMEDIATELY IF ADJACENT STRUCTURES APPEAR TO BE IN DANGER. NOTIFY AUTHORITY HAVING JURISDICTION AND ARCHITECT/ ENGINEER. DO NOT RESUME OPERATIONS UNTIL DIRECTED.
- THE CONTRACTOR AND OWNER TO OBTAIN WRITTEN PERMISSION FROM ADJACENT PROPERTY OWNERS WHEN DEMOLITION EQUIPMENT WILL TRAVERSE, INFRINGE UPON OR LIMIT ACCESS TO THEIR PROPERTY.
 SPRINKLE WORK WITH WATER TO MINIMIZE DUST. PROVIDE HOSES AND WATER CONNECTIONS FOR THIS PURPOSE.
- 13. ALL MATERIAL POTENTIALLY CONTAINING LEAD IS TO BE TESTED AND DISPOSED OF ACCORDING TO FEDERAL, STATE AND LOCAL REGULATIONS. WORK TO BE OVERSEEN BY AN ENVIRONMENTAL ENGINEERING CONSULTANT.
- 14. ALL EXCAVATIONS SHALL BE BACKFILLED WITH SUITABLE MATERIAL AND COMPACTED TO SUPPORT SITE AND BUILDING IMPROVEMENTS. A GEOTECHNICAL ENGINEER SHALL OBSERVE AND CERTIFY THAT BACKFILL MATERIAL MEETS ALL SOIL REQUIREMENTS TO SUPPORT THE BUILDING STRUCTURE.
- 15. ALL DEMOLITION MATERIAL AND DEBRIS AND ALL ITEMS REMOVED FROM THE PROPERTY AND THE PUBLIC AREAS ADJACENT, SHALL BE DISPOSED OUTSIDE OF CITY LIMITS OF JERSEY CITY IN ACCORDANCE WITH THE RULES AND REGULATION OF THE CITY'S ENVIRONMENTAL COMMISSION AND IN ACCORDANCE WITH THE REGULATIONS AND LAWS OF THE NJDEP.

WORK TO BE PERFORMED:


CONTRACTOR IS TO DESCRIBE DEMOLITION REMOVAL PROCEDURES AND SCHEDULE OF WORK.


SIMULTANEOUSLY WITH THE REMOVAL OF EXISTING WORK.

- CONTRACTOR IS TO CONTACT ARCHITECT/ ENGINEER BEFORE REMOVAL OF ANY WALL IN WHICH CONTRACTOR IS UNSURE OF.
 PROTECT EXISTING MATERIALS AND THOSE ITEMS WHICH ARE NOT TO BE DEMOLISHED.
- DISCONNECT, REMOVE OR CAP AND IDENTIFY DESIGNATED UTILITIES WITHIN DEMOLITION AREAS, SHOWN OR OTHERWISE IN PLANS.

 ERECT AND MAINTAIN WEATHERPROOF CLOSURES FOR EXTERIOR OPENINGS IF REPLACEMENT WILL NOT BE INSTALLED



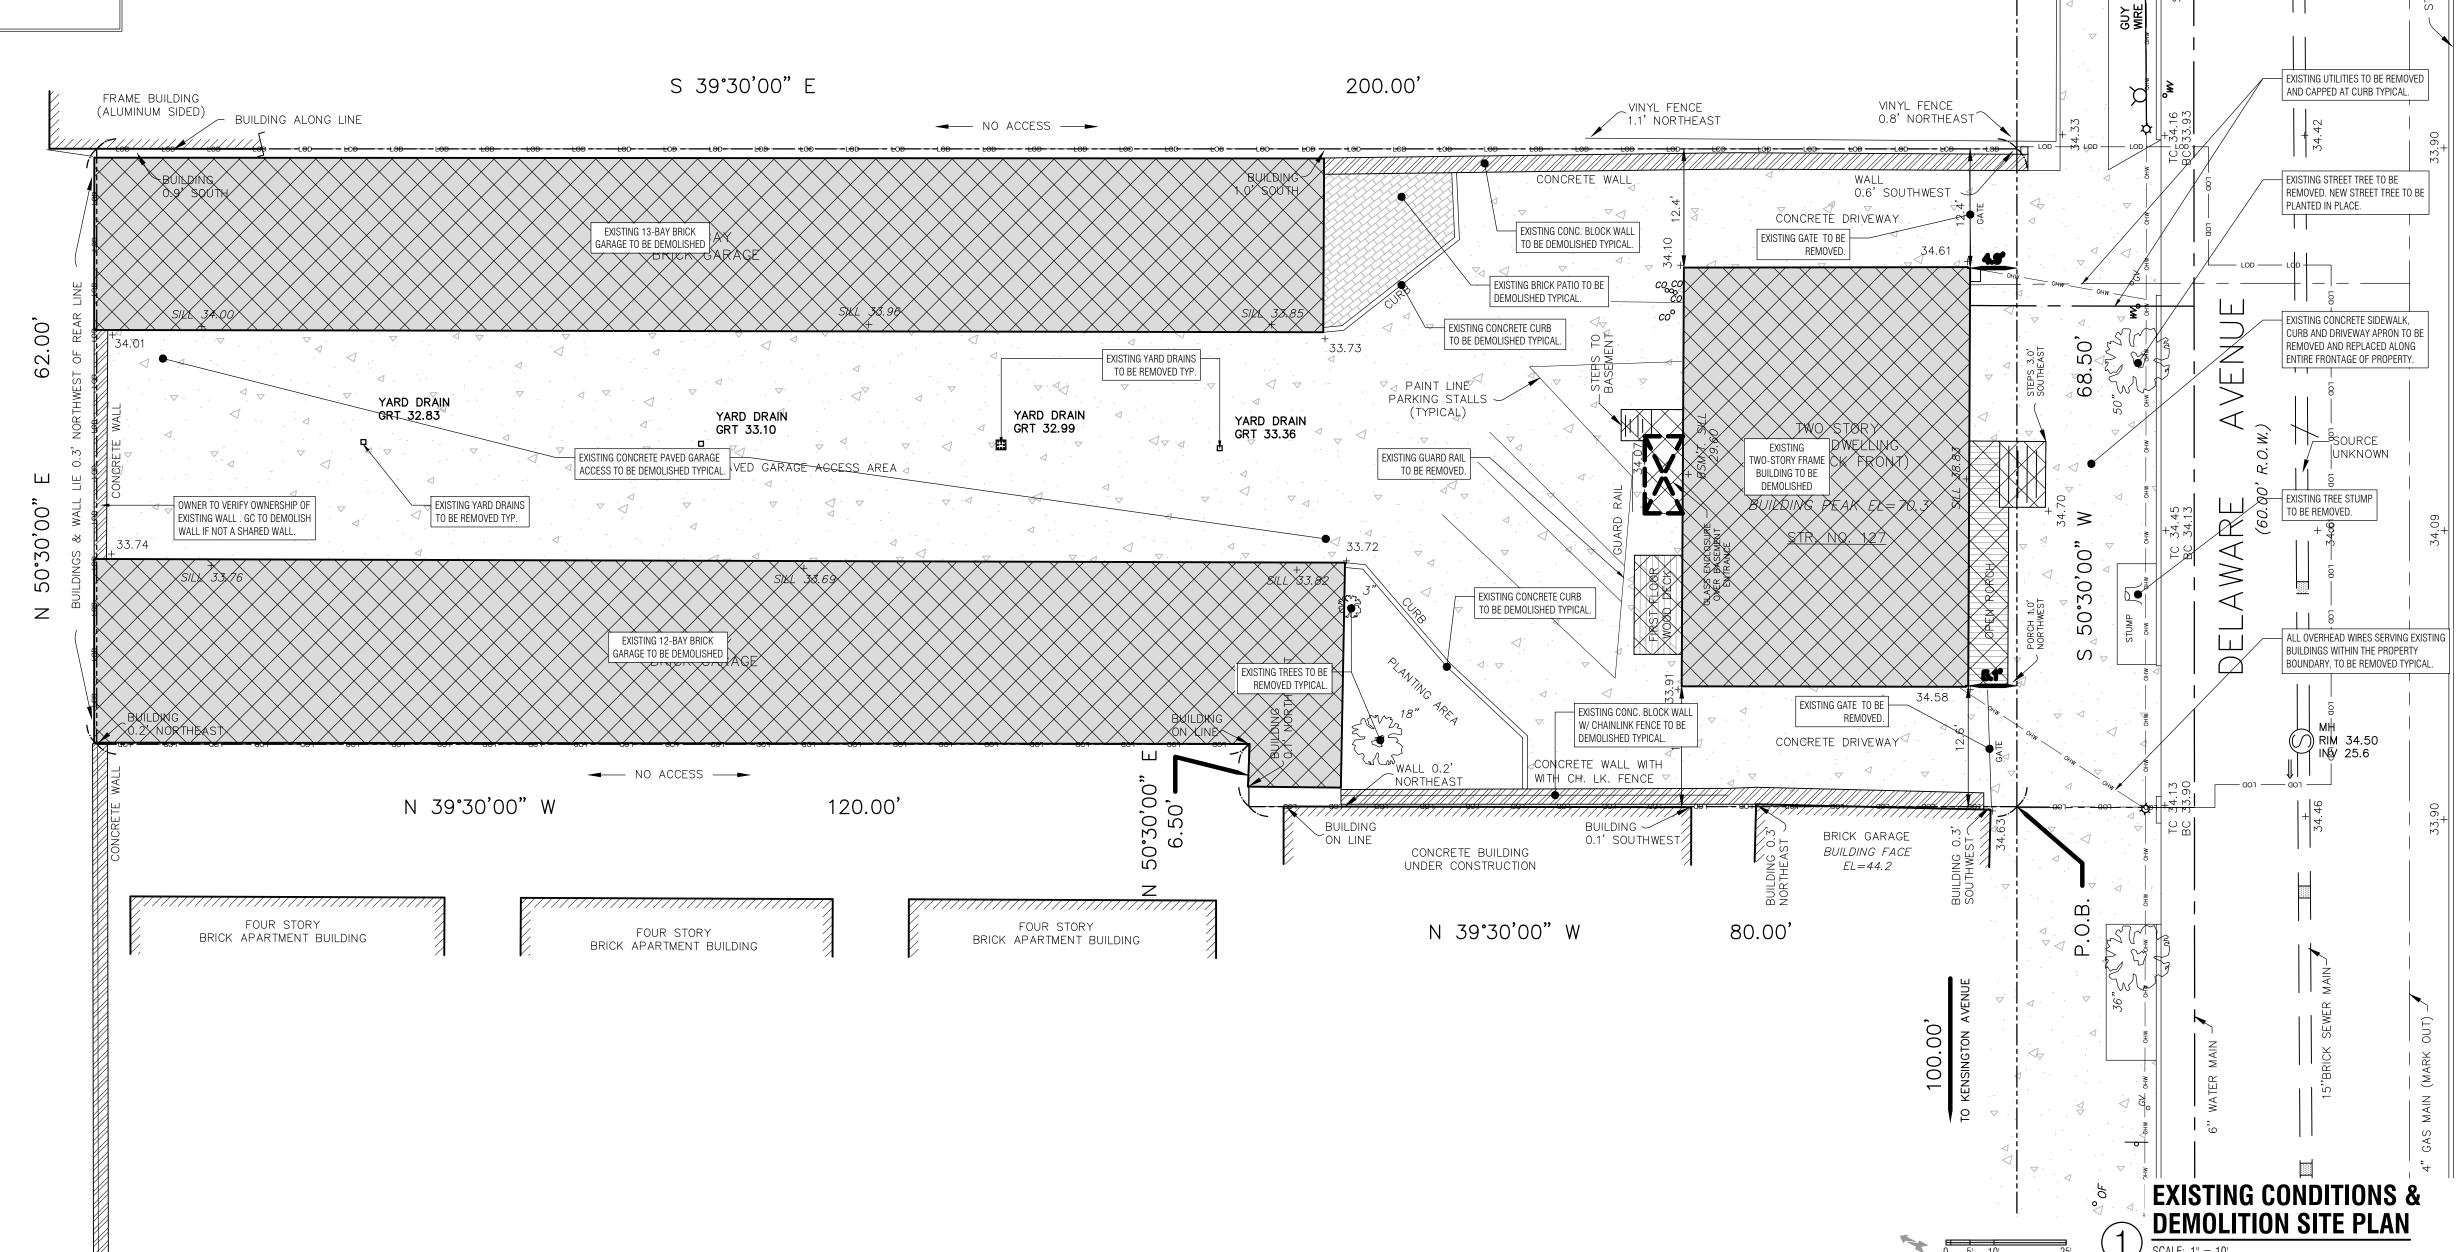


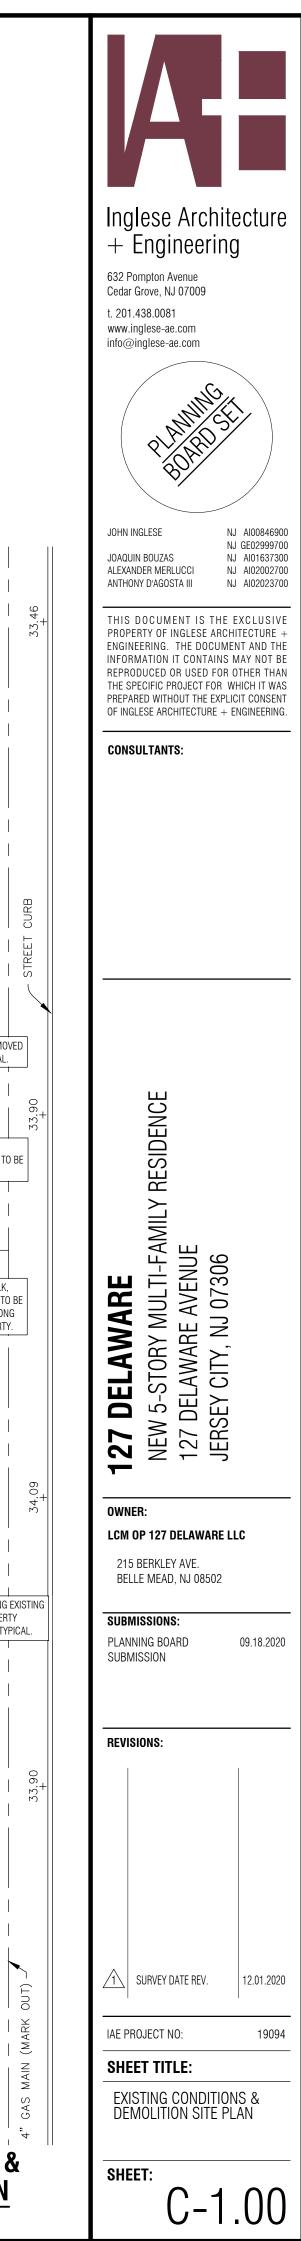


GENERAL NOTES

- THE CONTRACTOR IS RESPONSIBLE FOR GETTING FAMILIAR WITH THE EXISTING SITE CONDITIONS AND THE SCOPE OF WORK PROPOSED IN THE SET OF DRAWINGS PRIOR TO PERFORMING ANY WORK.
- THE CONTRACTOR IS TO IMMEDIATELY CONTACT THE ARCHITECT OR ENGINEER ON RECORD IF ANY DISCREPANCY BETWEEN THE EXISTING SITE CONDITIONS AND THE DRAWING SET IS FOUND.
- THE CONTRACTOR IS RESPONSIBLE FOR OBTAINING ALL NECESSARY PERMIT/APPROVALS BEFORE THE BEGINNING OF CONSTRUCTION/IMPROVEMENT. THE CONTRACTOR, AND HIS SUBCONTRACTORS, SHALL COVER AND HOLD HARMLESS THE ENGINEER/ARCHITECT FROM AND AGAINST ANY DAMAGES AND LIABILITIES INCLUDING ATTORNEY'S FEES ARISING OUT OF CLAIMS BY EMPLOYEES OF THE
- CONTRACTOR IN ADDITION TO CLAIMS CONNECTED TO THE PROJECT. THE CONTRACTOR IS RESPONSIBLE FOR ALL MEANS AND METHODS.
- THE CONTRACTOR IS TO ONLY PERFORM THE IMPROVEMENT SPECIFIED WITHIN THE LIMIT OF THE OWNER'S PROPERTY. THE CONTRACTOR IS RESPONSIBLE TO PRESERVE ALL EXISTING SITE CONDITIONS SPECIFIED IN THE DRAWING SET. ANY DAMAGED FEATURE OR STRUCTURE IS TO BE REPAIRED OR REPLACED AT CONTRACTOR'S EXPENSE.
- THE CONTRACTOR SHALL PROVIDE SHOP DRAWINGS AND PRODUCT SPECIFICATIONS TO ARCHITECT/ENGINEER OF RECORD FOR REVIEW PRIOR TO INSTALLATION. THE CONTRACTOR IS RESPONSIBLE TO MAINTAIN TRAFFIC CONTROL.
- D. THE CONTRACTOR IS RESPONSIBLE TO OBTAIN SIDEWALK CLOSURE PERMITS FROM THE LOCAL JURISDICTION TO CARRY OUT THE PUBLIC R.O.W. IMPROVEMENTS. ALL SIDEWALK AND CURB RELATED WORK TO BE PERFORMED PER LOCAL REGULATIONS AND
- THE CONTRACTOR & THE OWNER ARE RESPONSIBLE TO HIRE AN OSHA CERTIFIED INSPECTOR TO REMAIN ON SITE DURING DEMOLITION AND CONSTRUCTION.
- THE OWNER IS RESPONSIBLE FOR MERGING AND SUB-DIVIDING ALL TAX LOTS INVOLVED ON THE SITE. B. THE APPLICANT/DEVELOPER MUST COMPLY WITH ALL DIRECTIVES FROM THE DIVISION OF WATER/SEWER UTILITY. THE DEVELOPER/APPLICANT MUST CONTACT THE SEWER UNIT AND WATER UNIT FOR DETAILED INFORMATION AND REQUIREMENTS
- REGARDING THE EXISTING/PROPOSED SEWER/WATER CONNECTIONS PRIOR TO THE ISSUANCE OF ANY CONSTRUCTION PERMITS A SOIL EROSION AND SEDIMENT CONTROL PERMIT MUST BE OBTAINED PRIOR TO THE COMMENCEMENT OF ANY WORK AT THE SITES. 5. Any existing street catch basins within the property boundaries shall be retrofit with a new frame/grate/curb PIECE PER THE ATTACHED CITY STANDARD.
- 5. BUILDING ADDRESSES SHALL BE DISPLAYED SO AS TO BE IN CONFORMANCE WITH THE CITY'S 911 LOCATABLE ADDRESS ORDINANCE. THE DEVELOPER MUST OBTAIN THE CORRECT STREET ADDRESSES FROM THE CITY SURVEYOR.
- THE RECYCLING BINS (MATERIALS: CARDBOARD/PAPER/ PLASTIC, GLASS & CAN) FOR TENANT UNITS SHALL BE LOCATED ON THE GROUND FLOOR OF THE BUILDING. B. WALL STRIPING AND SIGNAGE IN PARKING AREA SHALL BE IN ACCORDANCE WITH THE LATEST EDITION OF THE MANUAL OF UNIFORM
- TRAFFIC CONTROL DEVICES.



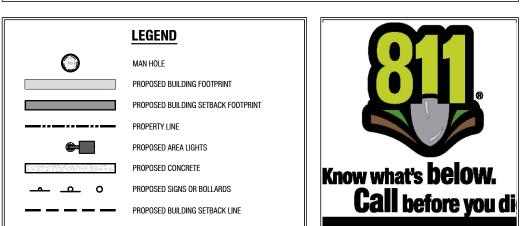

SIGNAGE REQUIREMENTS				
CODE SECTION	REQUIRED	PROPOSED		
-	WALL SIGN: 1 WALL SIGN UP TO 20 SF	TBD		

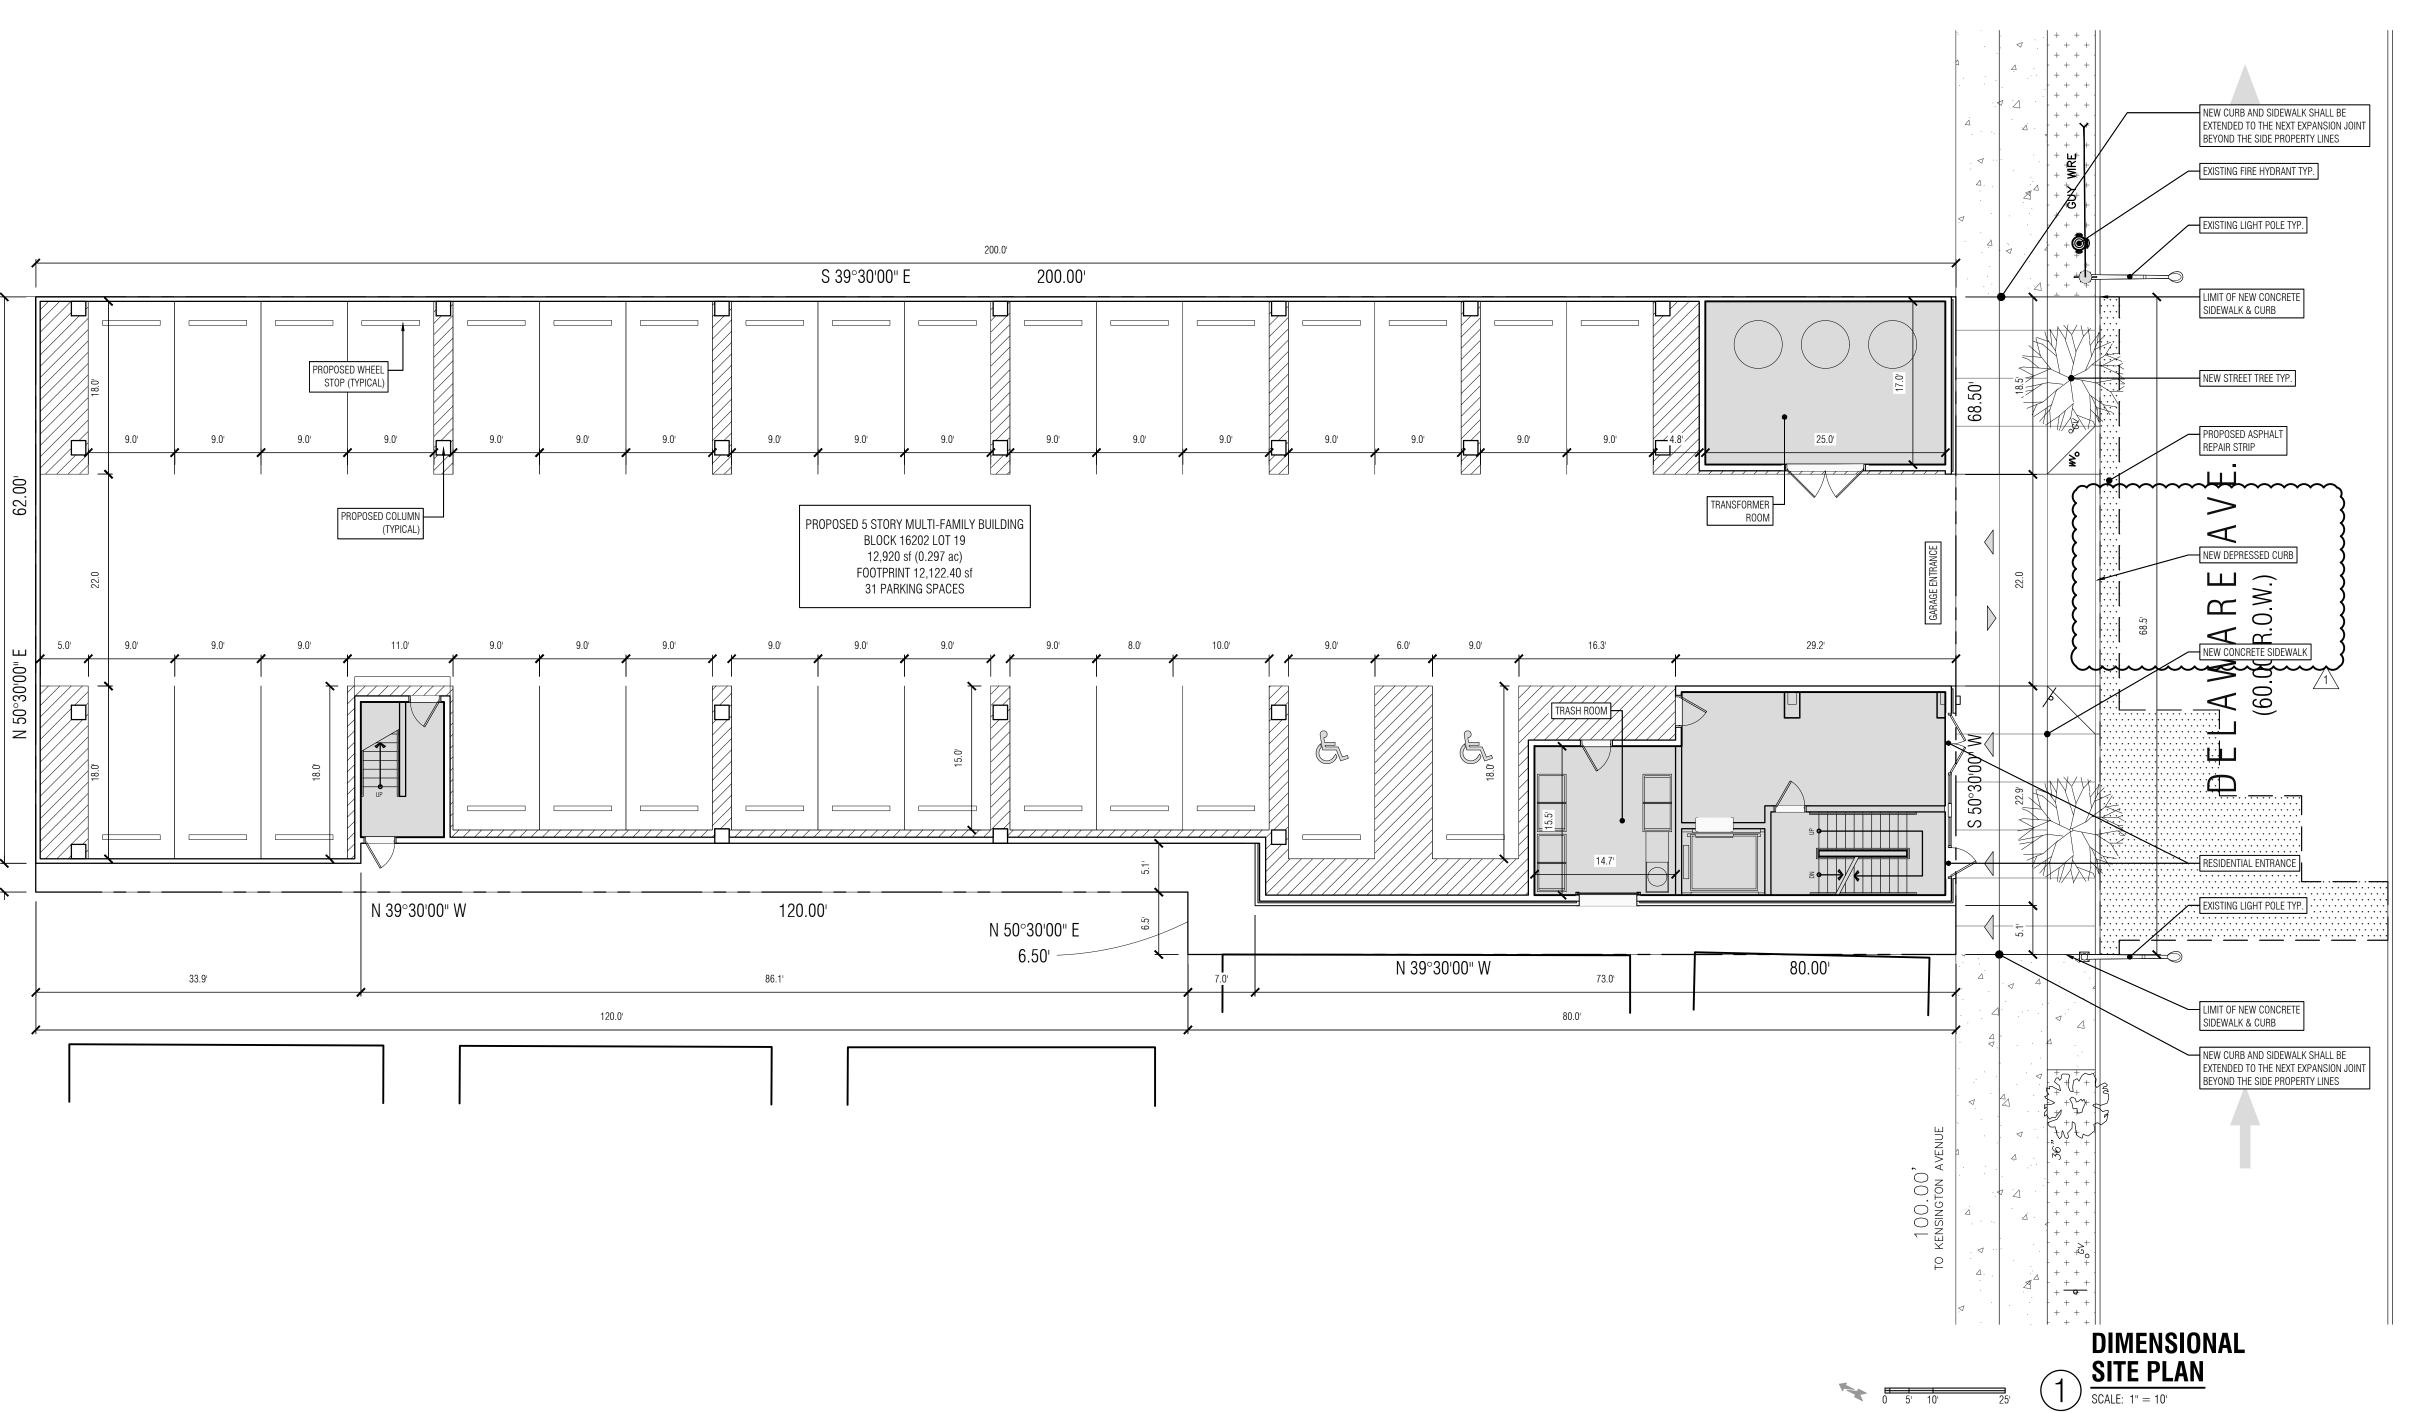



GRADING NOTES

- ALL SOIL AND MATERIAL REMOVED FROM THE SITE SHALL BE DISPOSED OF IN ACCORDANCE WITH LOCAL, STATE, AND FEDERAL REQUIREMENTS. ANY GROUNDWATER DE-WATERING PRACTICES SHALL BE PERFORMED UNDER THE SUPERVISION OF A QUALIFIED PROFESSIONAL. THE CONTRACTOR IS REQUIRED TO OBTAIN ALL NECESSARY PERMITS FOR THE DISCHARGE OF DE-WATERED GROUNDWATER. ALL SOIL IMPORTED TO THE SITE SHALL BE CERTIFIED CLEAN FILL. CONTRACTOR SHALL MAINTAIN RECORDS OF ALL FILL MATERIALS BROUGHT TO THE SITE.
- THE CONTRACTOR IS REQUIRED TO PROVIDE TEMPORARY AND/OR PERMANENT SHORING WHERE REQUIRED DURING EXCAVATION ACTIVITIES, INCLUDING BUT NOT LIMITED TO UTILITY TRENCHES, TO ENSURE THE STRUCTURAL INTEGRITY OF NEARBY STRUCTURES AND STABILITY OF THE SURROUNDING
- PROPOSED TOP OF CURB ELEVATIONS ARE GENERALLY 4 INCHES TO 7 INCHES ABOVE EXISTING GRADES UNLESS OTHERWISE NOTED. THE CONTRACTOR WILL SUPPLY ALL STAKEOUT CURB GRADE
- SHEETS TO THE ENGINEER/ARCHITECT FOR REVIEW AND APPROVAL PRIOR TO POURING CURBS. THE CONTRACTOR IS RESPONSIBLE TO SET ALL PROPOSED UTILITY COVERS AND RESET ALL EXISTING UTILITY COVERS WITHIN THE PROJECT LIMITS TO PROPOSED GRADE IN ACCORDANCE WITH ANY APPLICABLE MUNICIPAL, COUNTY, STATE AND/OR UTILITY AUTHORITY REGULATIONS.
- MINIMUM SLOPE REQUIREMENTS TO PREVENT PONDING SHALL BE AS FOLLOWS: 0.50%
- CURB GUTTER:
- CONCRETE SURFACES: 1.00% 1.00%
- ASPHALT SURFACES: A MINIMUM SLOPE OF 1.00% SHALL BE PROVIDED AWAY FROM ALL BUILDINGS. THE CONTRACTOR SHALL ENSURE POSITIVE DRAINAGE FROM THE BUILDING IS ACHIEVED AND SHALL NOTIFY THE ENGINEER/ ARCHITECT IF THIS CONDITION CANNOT BE MET.
- FOR PROJECTS WHERE BASEMENTS ARE PROPOSED, THE DEVELOPER IS RESPONSIBLE TO DETERMINE THE DEPTH TO GROUNDWATER AT THE LOCATION OF THE PROPOSED STRUCTURE. IF GROUNDWATER IS ENCOUNTERED WITHIN THE BASEMENT AREA, SPECIAL CONSTRUCTION METHODS SHALL BE UTILIZED AND REVIEWED/APPROVED BY THE CONSTRUCTION CODE OFFICIAL. IF SUMP PUMPS ARE UTILIZED, ALL DISCHARGES SHALL BE CONNECTED DIRECTLY TO THE PUBLIC STORM SEWER SYSTEM WITH APPROVAL FROM THE GOVERNING STORM SEWER SYSTEM AUTHORITY.

ADA NOTES

- THE CONTRACTOR SHALL MAINTAIN A MAXIMUM 2.00% SLOPE IN ANY DIRECTION WITHIN THE ADA PARKING SPACES AND ACCESS AISLES.
- THE CONTRACTOR SHALL PROVIDE COMPLIANT SIGNAGE AT ALL ADA PARKING AREAS IN ACCORDANCE WITH STATE GUIDELINES.
- THE CONTRACTOR SHALL MAINTAIN A MAXIMUM 5.00% RUNNING SLOPE AND A MAXIMUM OF 2.00% CROSS SLOPE ALONG WALKWAYS WITHIN THE ACCESSIBLE PATH OF TRAVEL (SEE THE SITE PLAN FOR THE LOCATION OF THE ACCESSIBLE PATH). THE CONTRACTOR IS RESPONSIBLE TO ENSURE THE ACCESSIBLE PATH OF TRAVEL IS 36 INCHES WIDE OR GREATER UNLESS INDICATED OTHERWISE
- WITHIN THE PLAN SET. THE CONTRACTOR SHALL MAINTAIN A MAXIMUM 2.00% SLOPE IN ANY DIRECTION AT ALL LANDINGS. LANDINGS INCLUDE, BUT ARE NOT LIMITED TO, THE TOP AND BOTTOM OF AN ACCESSIBLE RAMP, AT ACCESSIBLE BUILDING ENTRANCES, AT AN AREA IN FRONT OF A WALK-UP ATM, AND AT TURNING SPACES ALONG THE ACCESSIBLE PATH OF TRAVEL. THE LANDING AREA SHALL HAVE A MINIMUM CLEAR AREA OF 60 INCHES BY 60 INCHES UNLESS INDICATED OTHERWISE WITHIN THE PLAN SET.
- THE CONTRACTOR SHALL MAINTAIN A MAXIMUM 8.33% RUNNING SLOPE AND A MAXIMUM 2.00% CROSS SLOPE ON ANY CURB RAMPS ALONG THE ACCESSIBLE PATH OF TRAVEL. WHERE PROVIDED, CURB RAMP FLARES SHALL NOT HAVE A SLOPE GREATER THAN 10.00% IF A LANDING AREA IS PROVIDED AT THE TOP OF THE RAMP. FOR ALTERATIONS, A CURB RAMP FLARES SHALL NOT HAVE A SLOPE GREATER THAN 8.33% IF A LANDING AREA IS NOT PROVIDED AT THE TOP OF THE RAMP. CURBS RAMPS SHALL NOT RISE MORE THAN 6 INCHES IN ELEVATION WITHOUT A HANDRAIL. THE CLEAR WIDTH OF A CURB RAMP SHALL BE NO LESS THAN 36 INCHES WIDE.
- ACCESSIBLE RAMPS WITH A RISE GREATER THAN 6 INCHES SHALL CONTAIN COMPLIANT HANDRAILS ON BOTH SIDES OF THE RAMP AND SHALL NOT RISE MORE THAN 30" IN ELEVATION WITHOUT A LANDING AREA IN BETWEEN RAMP RUNS. LANDING AREAS SHALL ALSO BE PROVIDED AT THE TOP AND BOTTOM OF THE RAMP.
- A SLIP RESISTANT SURFACE SHALL BE CONSTRUCTED ALONG THE ACCESSIBLE PATH AND WITHIN ADA PARKING AREAS.
- THE CONTRACTOR SHALL ENSURE A MAXIMUM OF 1/4 INCHES VERTICAL CHANGE IN LEVEL ALONG THE ACCESSIBLE PATH. WHERE A CHANGE IN LEVEL BETWEEN 1/4 INCHES AND 1/2 INCHES EXISTS, CONTRACTOR SHALL ENSURE THAT THE TOP 1/4 INCH CHANGE IN LEVEL IS BEVELED WITH A SLOPE NOT STEEPER THAN 1 UNIT VERTICAL AND 2 UNITS HORIZONTAL (2:1 SLOPE).
- THE CONTRACTOR SHALL ENSURE THAT ANY OPENINGS (GAPS OR HORIZONTAL SEPARATION) ALONG THE ACCESSIBLE PATH SHALL NOT ALLOW PASSAGE OF A SPHERE GREATER THAN ½ INCH.

PLUMBING, SANITARY AND STORMWATER MANAGEMENT PACKET PROJECT ADDRESS: 127 DELAWARE AVE, JERSEY CITY NJ PROJECT DESIGNER: INGLESE ARCHITECTURE & ENGINEERING WATER DEMAND CALC 1 BEDROOM SANITARY SEWER CALC CONCENTRATION FOR THE STORM IS 10 MINUTES. THE STORM WATER MANAGEMENT REPORT INCLUDING HYDROGRAPHS ARE ATTACHED IN A SEPERATE DOCUME! AND AN ATTACHMENT TO THIS PLAN. THE SLIMMARY OF CALCULATIONS FOR THIS SYSTEM IS AS FOLLOWS: PEAK FLOW (RATIONAL METHOD) Q = C * I * APRE-DEVELOPMENT PEAK FLOW, Q existing 2.343 CFS POST-DEVELOPMENT PEAK FLOW, Q proposed 10 MINS 15 MINS PEAK TIME, Tp 435.60 CF 2-YR STORAGE REQUIREMET 696.96 CF 10-YR STORAGE REQUIREMET UNDERGROUND STORAGE OUTLET STRUCTURE (6' X 4' X 4') 33 CF(NET) DESIGN

DRAINAGE AND UTILITY NOTES

CURB SPOT SHOTS

M.E.G MATCH EXISTING GRADE


DEP. CURB SPOT SHOTS

- **GRADING LEGEND** SPOT 100.00 GRADE SPOT SHOTS . THE CONTRACTOR IS REQUIRED TO CALL THE APPROPRIATE AUTHORITY FOR NOTICE OF FLUSH CURB SPOT SHOTS CONSTRUCTION/EXCAVATION AND UTILITY MARK OUT PRIOR TO THE START OF CONSTRUCTION IN ACCORDANCE WITH STATE LAW. CONTRACTOR IS REQUIRED TO CONFIRM THE HORIZONTAL AND VERTICAL LOCATION OF UTILITIES IN THE FIELD. SHOULD A DISCREPANCY EXIST BETWEEN THE FIELD LOCATION OF A BC XXX EXIST CURB SPOT SHOTS UTILITY AND THE LOCATION SHOWN ON THE PLAN SET OR SURVEY, THE CONTRACTOR SHALL NOTIFY ENGINEER OF RECORD IMMEDIATELY IN WRITING. THE CONTRACTOR IS RESPONSIBLE TO PROTECT AND MAINTAIN IN OPERATION ALL UTILITIES NOT WALL SPOT SHOTS
 - DESIGNATED TO BE REMOVED. THE CONTRACTOR IS RESPONSIBLE FOR REPAIRING ANY DAMAGE TO ANY EXISTING UTILITY IDENTIFIED TO
 - REMAIN WITHIN THE LIMITS OF THE PROPOSED WORK DURING CONSTRUCTION. A MINIMUM HORIZONTAL SEPARATION OF 10 FEET IS REQUIRED BETWEEN ANY SANITARY SEWER SERVICE AND ANY WATER LINES. IF THIS SEPARATION CANNOT BE PROVIDED, A CONCRETE ENCASEMENT SHALL BE
 - ALL WATER LINES SHALL BE VERTICALLY SEPARATED ABOVE SANITARY SEWER LINES BY A MINIMUM DISTANCE OF 18 INCHES. IF THIS SEPARATION CANNOT BE PROVIDED, A CONCRETE ENCASEMENT SHALL BE UTILIZED FOR THE SANITARY SEWER SERVICE AS APPROVED BY ENGINEER OF RECORD. THE CONTRACTOR TO PERFORM A TEST PIT PRIOR TO CONSTRUCTION (RECOMMEND 30 DAYS PRIOR) AT

UTILIZED FOR THE SANITARY SEWER SERVICE AS APPROVED BY ENGINEER OF RECORD.

- LOCATIONS OF EXISTING UTILITY CROSSINGS FOR WATER AND SANITARY SEWER CONNECTION IMPROVEMENTS. SHOULD A CONFLICT EXIST, THE CONTRACTOR SHALL IMMEDIATELY NOTIFY ENGINEER OF RECORD. IN WRITING. THE CONTRACTOR IS RESPONSIBLE FOR COORDINATING GAS, ELECTRIC AND TELECOMMUNICATION
- CONNECTIONS WITH THE APPROPRIATE GOVERNING AUTHORITY. CONTRACTOR SHALL START CONSTRUCTION OF ANY GRAVITY SEWER AT THE LOWEST INVERT AND WORK
- UP-GRADIENT. THE CONTRACTOR IS RESPONSIBLE TO MAINTAIN A RECORD SET OF PLANS REFLECTING THE LOCATION OF EXISTING UTILITIES THAT HAVE BEEN CAPPED, ABANDONED, OR RELOCATED BASED ON THE DEMOLITION/REMOVAL ACTIVITIES REQUIRED IN THIS PLAN SET. THIS DOCUMENT SHALL BE PROVIDED TO
- THE OWNER FOLLOWING COMPLETION OF WORK. THE CONTRACTOR IS RESPONSIBLE TO MAINTAIN A RECORD OF THE AS-BUILT LOCATIONS OF ALL PROPOSED UNDERGROUND INFRASTRUCTURE. THE CONTRACTOR SHALL NOTE ANY DISCREPANCIES BETWEEN THE AS-BUILT LOCATIONS AND THE LOCATIONS DEPICTED WITHIN THE PLAN SET. THIS RECORD SHALL BE PROVIDED TO THE OWNER FOLLOWING COMPLETION OF WORK.

UTILITY LEGEND PROPOSED UNDERGROUND GAS LINE PROPOSED GAS VALVE PROPOSED GAS METER PROPOSED SANITARY SEWER LATERAL PROPOSED SANITARY SEWER MAIN PROPOSED UNDERGROUND 4" POTABLE PROPOSED WATER VALVE PROPOSED WATER VALVE PROPOSED FIRE DEPT. CONNECTION PROPOSED KNOX BOX PROPOSED UNDERGROUND ELECTRIC SERVICE PROPOSED UNDERGROUND TELEPHONE & CABLE PROPOSED UNDERGROUND HDPE DETENTION

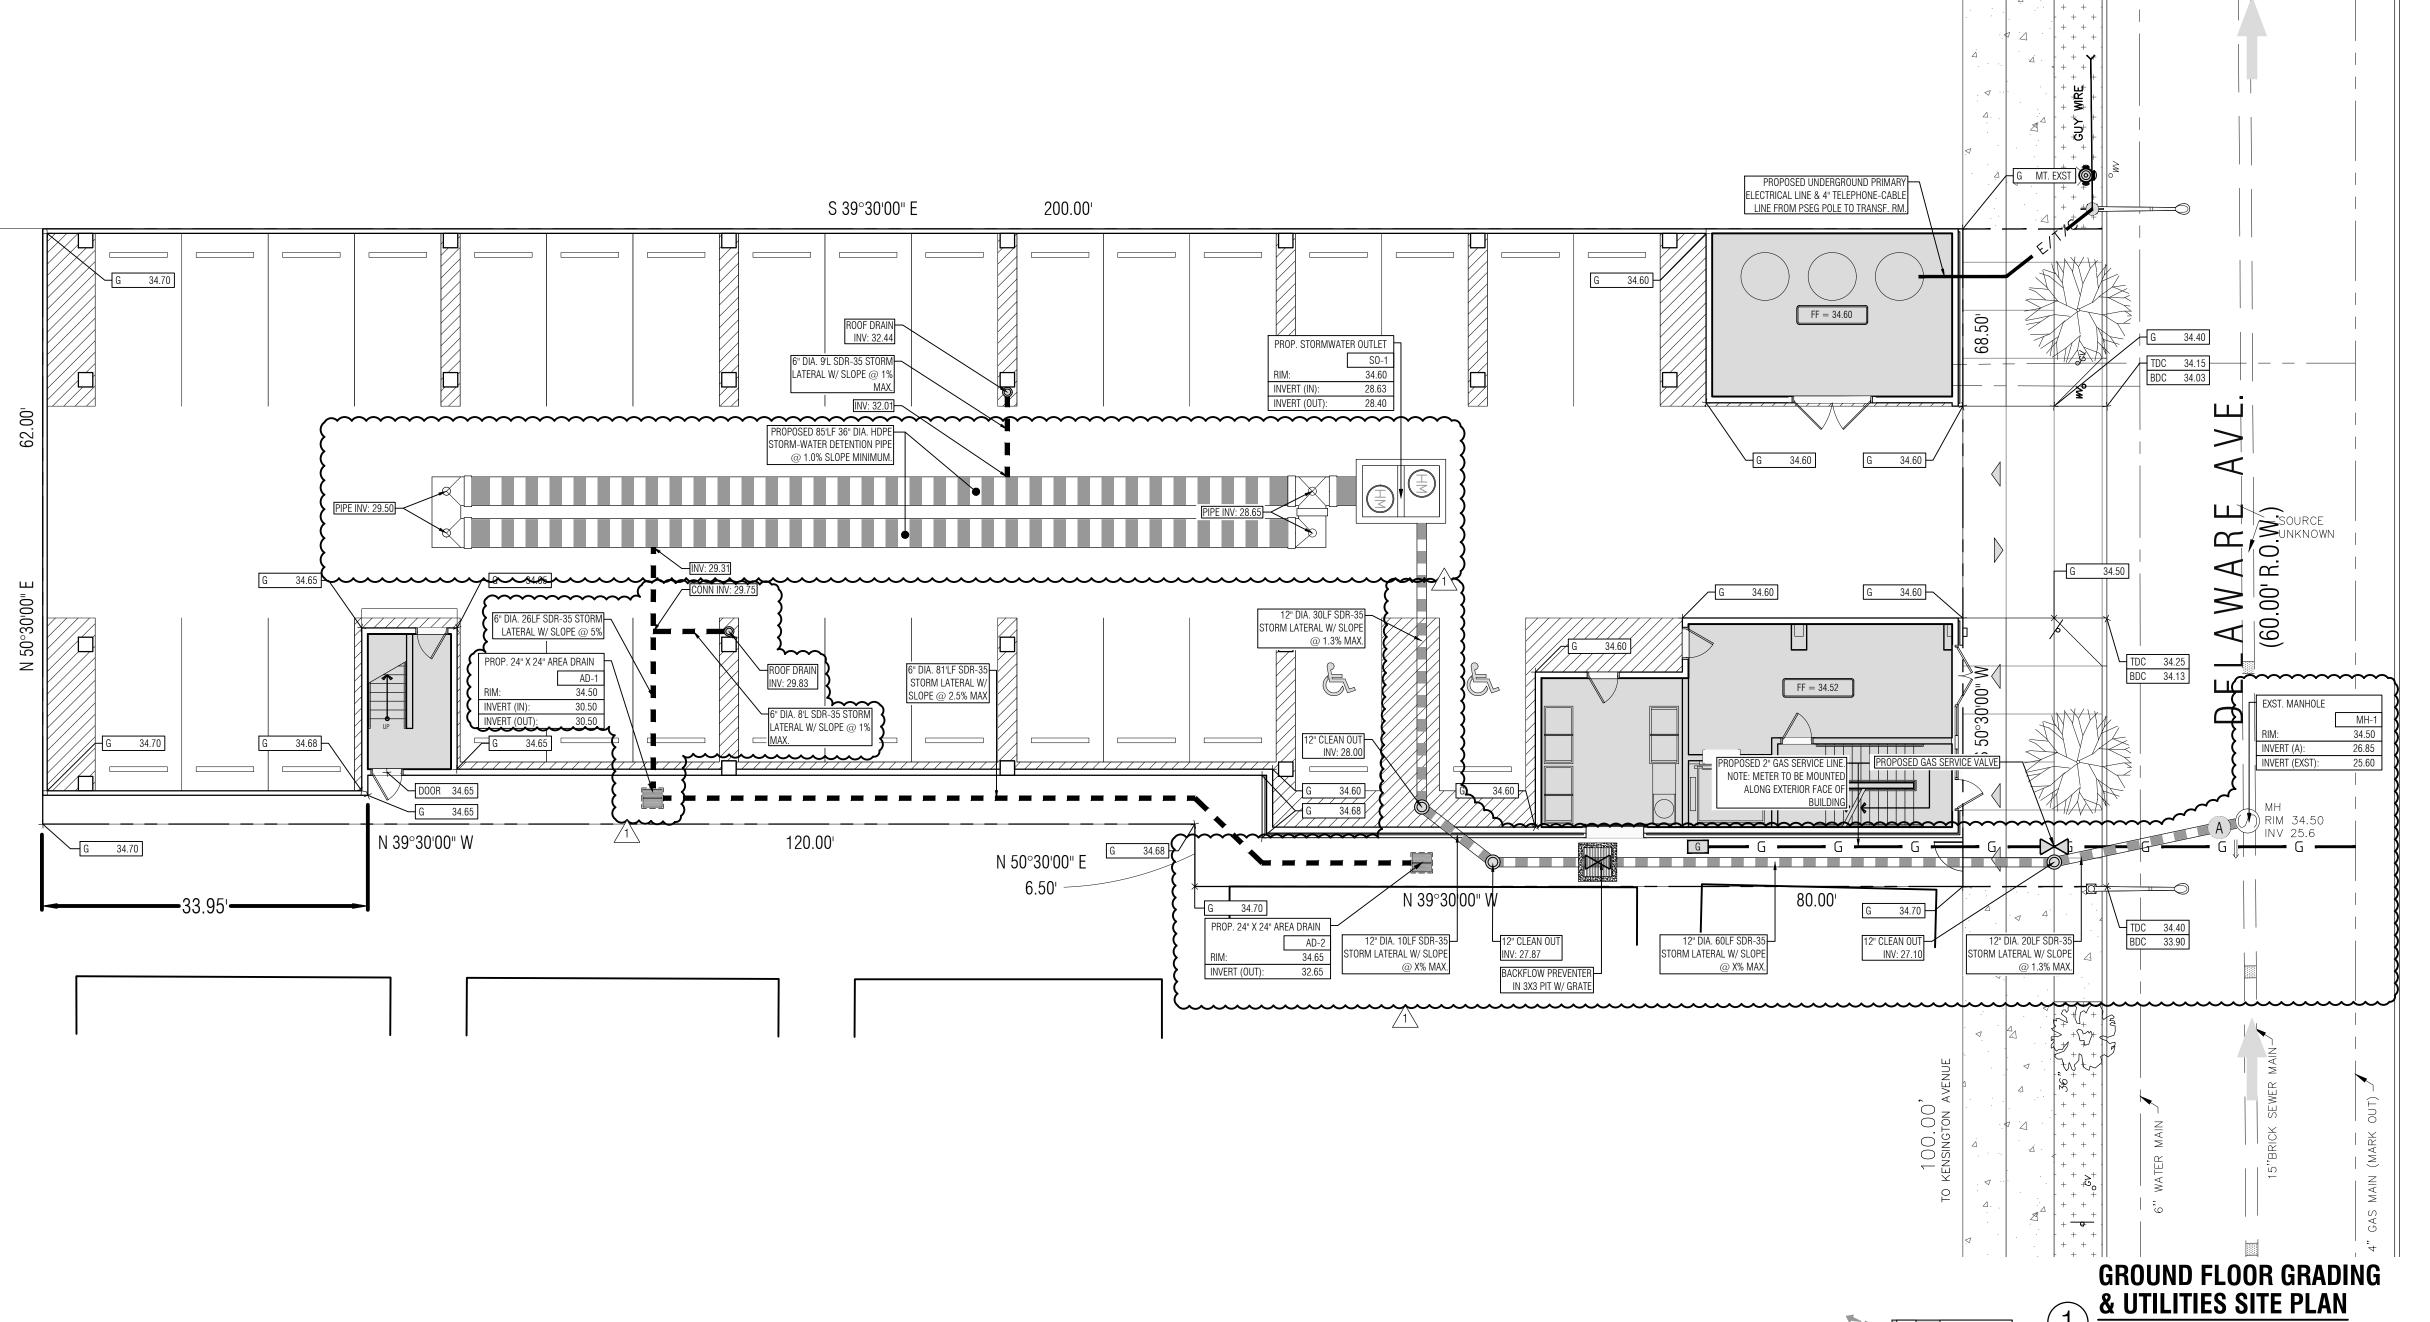



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CONSULTANTS:

27 DELAWARE NEW 5-STORY 127 DELAWAR JERSEY CITY, I

OWNER: LCM OP 127 DELAWARE LLC 215 BERKLEY AVE. BELLE MEAD, NJ 08502

SUBMISSIONS: PLANNING BOARD SUBMISSION

REVISIONS:

JCMUA UPDATES 01.11.2021

IAE PROJECT NO: SHEET TITLE: GROUND FLOOR GRADING & UTILITIES SITE PLAN

GRADING NOTES

- ALL SOIL AND MATERIAL REMOVED FROM THE SITE SHALL BE DISPOSED OF IN ACCORDANCE WITH LOCAL, STATE, AND FEDERAL REQUIREMENTS. ANY GROUNDWATER DE-WATERING PRACTICES SHALL BE PERFORMED UNDER THE SUPERVISION OF A QUALIFIED PROFESSIONAL. THE CONTRACTOR IS REQUIRED TO OBTAIN ALL NECESSARY PERMITS FOR THE DISCHARGE OF DE-WATERED GROUNDWATER. ALL SOIL IMPORTED TO THE SITE SHALL BE CERTIFIED CLEAN FILL. CONTRACTOR SHALL MAINTAIN RECORDS OF ALL FILL MATERIALS BROUGHT TO THE SITE.
- THE CONTRACTOR IS REQUIRED TO PROVIDE TEMPORARY AND/OR PERMANENT SHORING WHERE REQUIRED DURING EXCAVATION ACTIVITIES, INCLUDING BUT NOT LIMITED TO UTILITY TRENCHES, TO ENSURE THE STRUCTURAL INTEGRITY OF NEARBY STRUCTURES AND STABILITY OF THE SURROUNDING
- PROPOSED TOP OF CURB ELEVATIONS ARE GENERALLY 4 INCHES TO 7 INCHES ABOVE EXISTING GRADES UNLESS OTHERWISE NOTED. THE CONTRACTOR WILL SUPPLY ALL STAKEOUT CURB GRADE SHEETS TO THE ENGINEER/ARCHITECT FOR REVIEW AND APPROVAL PRIOR TO POURING CURBS.
- THE CONTRACTOR IS RESPONSIBLE TO SET ALL PROPOSED UTILITY COVERS AND RESET ALL EXISTING UTILITY COVERS WITHIN THE PROJECT LIMITS TO PROPOSED GRADE IN ACCORDANCE WITH ANY APPLICABLE MUNICIPAL, COUNTY, STATE AND/OR UTILITY AUTHORITY REGULATIONS.
- MINIMUM SLOPE REQUIREMENTS TO PREVENT PONDING SHALL BE AS FOLLOWS: CURB GUTTER: 0.50%
- CONCRETE SURFACES: 1.00% 1.00%
- ASPHALT SURFACES: A MINIMUM SLOPE OF 1.00% SHALL BE PROVIDED AWAY FROM ALL BUILDINGS. THE CONTRACTOR SHALL ENSURE POSITIVE DRAINAGE FROM THE BUILDING IS ACHIEVED AND SHALL NOTIFY THE ENGINEER/ ARCHITECT IF THIS CONDITION CANNOT BE MET.
- FOR PROJECTS WHERE BASEMENTS ARE PROPOSED, THE DEVELOPER IS RESPONSIBLE TO DETERMINE THE DEPTH TO GROUNDWATER AT THE LOCATION OF THE PROPOSED STRUCTURE. IF GROUNDWATER IS ENCOUNTERED WITHIN THE BASEMENT AREA, SPECIAL CONSTRUCTION METHODS SHALL BE UTILIZED AND REVIEWED/APPROVED BY THE CONSTRUCTION CODE OFFICIAL. IF SUMP PUMPS ARE UTILIZED, ALL DISCHARGES SHALL BE CONNECTED DIRECTLY TO THE PUBLIC STORM SEWER SYSTEM WITH APPROVAL FROM THE GOVERNING STORM SEWER SYSTEM AUTHORITY.

ADA NOTES

- THE CONTRACTOR SHALL MAINTAIN A MAXIMUM 2.00% SLOPE IN ANY DIRECTION WITHIN THE ADA PARKING SPACES AND ACCESS AISLES.
- THE CONTRACTOR SHALL PROVIDE COMPLIANT SIGNAGE AT ALL ADA PARKING AREAS IN ACCORDANCE WITH STATE GUIDELINES.
- THE CONTRACTOR SHALL MAINTAIN A MAXIMUM 5.00% RUNNING SLOPE AND A MAXIMUM OF 2.00% CROSS SLOPE ALONG WALKWAYS WITHIN THE ACCESSIBLE PATH OF TRAVEL (SEE THE SITE PLAN FOR THE LOCATION OF THE ACCESSIBLE PATH). THE CONTRACTOR IS RESPONSIBLE TO ENSURE THE ACCESSIBLE PATH OF TRAVEL IS 36 INCHES WIDE OR GREATER UNLESS INDICATED OTHERWISE WITHIN THE PLAN SET.
- THE CONTRACTOR SHALL MAINTAIN A MAXIMUM 2.00% SLOPE IN ANY DIRECTION AT ALL LANDINGS. LANDINGS INCLUDE, BUT ARE NOT LIMITED TO, THE TOP AND BOTTOM OF AN ACCESSIBLE RAMP, AT ACCESSIBLE BUILDING ENTRANCES, AT AN AREA IN FRONT OF A WALK-UP ATM, AND AT TURNING SPACES ALONG THE ACCESSIBLE PATH OF TRAVEL. THE LANDING AREA SHALL HAVE A MINIMUM CLEAR AREA OF 60 INCHES BY 60 INCHES UNLESS INDICATED OTHERWISE WITHIN THE PLAN SET. THE CONTRACTOR SHALL MAINTAIN A MAXIMUM 8.33% RUNNING SLOPE AND A MAXIMUM 2.00%
- CROSS SLOPE ON ANY CURB RAMPS ALONG THE ACCESSIBLE PATH OF TRAVEL. WHERE PROVIDED, CURB RAMP FLARES SHALL NOT HAVE A SLOPE GREATER THAN 10.00% IF A LANDING AREA IS PROVIDED AT THE TOP OF THE RAMP. FOR ALTERATIONS, A CURB RAMP FLARES SHALL NOT HAVE A SLOPE GREATER THAN 8.33% IF A LANDING AREA IS NOT PROVIDED AT THE TOP OF THE RAMP. CURBS RAMPS SHALL NOT RISE MORE THAN 6 INCHES IN ELEVATION WITHOUT A HANDRAIL. THE CLEAR WIDTH OF A CURB RAMP SHALL BE NO LESS THAN 36 INCHES WIDE.

ACCESSIBLE RAMPS WITH A RISE GREATER THAN 6 INCHES SHALL CONTAIN COMPLIANT HANDRAILS

- ON BOTH SIDES OF THE RAMP AND SHALL NOT RISE MORE THAN 30" IN ELEVATION WITHOUT A LANDING AREA IN BETWEEN RAMP RUNS. LANDING AREAS SHALL ALSO BE PROVIDED AT THE TOP AND BOTTOM OF THE RAMP.
- A SLIP RESISTANT SURFACE SHALL BE CONSTRUCTED ALONG THE ACCESSIBLE PATH AND WITHIN ADA PARKING AREAS.
- THE CONTRACTOR SHALL ENSURE A MAXIMUM OF 1/4 INCHES VERTICAL CHANGE IN LEVEL ALONG THE ACCESSIBLE PATH. WHERE A CHANGE IN LEVEL BETWEEN 1/4 INCHES AND 1/2 INCHES EXISTS, CONTRACTOR SHALL ENSURE THAT THE TOP 1/4 INCH CHANGE IN LEVEL IS BEVELED WITH A SLOPE NOT STEEPER THAN 1 UNIT VERTICAL AND 2 UNITS HORIZONTAL (2:1 SLOPE).
- THE CONTRACTOR SHALL ENSURE THAT ANY OPENINGS (GAPS OR HORIZONTAL SEPARATION) ALONG THE ACCESSIBLE PATH SHALL NOT ALLOW PASSAGE OF A SPHERE GREATER THAN ½ INCH.

DRAINAGE AND UTILITY NOTES

GRADING LEGEND

FLUSH CURB SPOT SHOTS

WALL SPOT SHOTS

CURB SPOT SHOTS

M.E.G MATCH EXISTING GRADE

DEP. CURB SPOT SHOTS

SPOT 100.00 GRADE SPOT SHOTS

BC XXX EXIST CURB SPOT SHOTS

. THE CONTRACTOR IS REQUIRED TO CALL THE APPROPRIATE AUTHORITY FOR NOTICE OF CONSTRUCTION/EXCAVATION AND UTILITY MARK OUT PRIOR TO THE START OF CONSTRUCTION IN ACCORDANCE WITH STATE LAW. CONTRACTOR IS REQUIRED TO CONFIRM THE HORIZONTAL AND VERTICAL LOCATION OF UTILITIES IN THE FIELD. SHOULD A DISCREPANCY EXIST BETWEEN THE FIELD LOCATION OF A UTILITY AND THE LOCATION SHOWN ON THE PLAN SET OR SURVEY, THE CONTRACTOR SHALL NOTIFY ENGINEER OF RECORD IMMEDIATELY IN WRITING. THE CONTRACTOR IS RESPONSIBLE TO PROTECT AND MAINTAIN IN OPERATION ALL UTILITIES NOT

DESIGNATED TO BE REMOVED. THE CONTRACTOR IS RESPONSIBLE FOR REPAIRING ANY DAMAGE TO ANY EXISTING UTILITY IDENTIFIED TO


REMAIN WITHIN THE LIMITS OF THE PROPOSED WORK DURING CONSTRUCTION. . A MINIMUM HORIZONTAL SEPARATION OF 10 FEET IS REQUIRED BETWEEN ANY SANITARY SEWER SERVICE AND ANY WATER LINES. IF THIS SEPARATION CANNOT BE PROVIDED, A CONCRETE ENCASEMENT SHALL BE

UTILIZED FOR THE SANITARY SEWER SERVICE AS APPROVED BY ENGINEER OF RECORD. ALL WATER LINES SHALL BE VERTICALLY SEPARATED ABOVE SANITARY SEWER LINES BY A MINIMUM DISTANCE OF 18 INCHES. IF THIS SEPARATION CANNOT BE PROVIDED, A CONCRETE ENCASEMENT SHALL BE UTILIZED FOR THE SANITARY SEWER SERVICE AS APPROVED BY ENGINEER OF RECORD. . THE CONTRACTOR TO PERFORM A TEST PIT PRIOR TO CONSTRUCTION (RECOMMEND 30 DAYS PRIOR) AT

- LOCATIONS OF EXISTING UTILITY CROSSINGS FOR WATER AND SANITARY SEWER CONNECTION IMPROVEMENTS. SHOULD A CONFLICT EXIST, THE CONTRACTOR SHALL IMMEDIATELY NOTIFY ENGINEER OF RECORD. IN WRITING. THE CONTRACTOR IS RESPONSIBLE FOR COORDINATING GAS, ELECTRIC AND TELECOMMUNICATION
- CONNECTIONS WITH THE APPROPRIATE GOVERNING AUTHORITY. CONTRACTOR SHALL START CONSTRUCTION OF ANY GRAVITY SEWER AT THE LOWEST INVERT AND WORK UP-GRADIENT. THE CONTRACTOR IS RESPONSIBLE TO MAINTAIN A RECORD SET OF PLANS REFLECTING THE LOCATION OF EXISTING UTILITIES THAT HAVE BEEN CAPPED, ABANDONED, OR RELOCATED BASED ON THE
- THE OWNER FOLLOWING COMPLETION OF WORK. THE CONTRACTOR IS RESPONSIBLE TO MAINTAIN A RECORD OF THE AS-BUILT LOCATIONS OF ALL PROPOSED UNDERGROUND INFRASTRUCTURE. THE CONTRACTOR SHALL NOTE ANY DISCREPANCIES BETWEEN THE AS-BUILT LOCATIONS AND THE LOCATIONS DEPICTED WITHIN THE PLAN SET. THIS RECORD SHALL BE PROVIDED TO THE OWNER FOLLOWING COMPLETION OF WORK.

DEMOLITION/REMOVAL ACTIVITIES REQUIRED IN THIS PLAN SET. THIS DOCUMENT SHALL BE PROVIDED TO

UTILITY LEGEND PROPOSED UNDERGROUND GAS LINE PROPOSED GAS VALVE PROPOSED GAS METER PROPOSED SANITARY SEWER LATERAL PROPOSED SANITARY SEWER MAIN PROPOSED SANITARY CLEANOUT PROPOSED UNDERGROUND 4" POTABLE PROPOSED WATER VALVE PROPOSED WATER VALVE PROPOSED FIRE DEPT. CONNECTION PROPOSED KNOX BOX PROPOSED UNDERGROUND ELECTRIC SERVICE PROPOSED UNDERGROUND TELEPHONE & CABLE SERVICE PROPOSED UTILITY POLE PROPOSED UNDERGROUND HDPE DETENTION

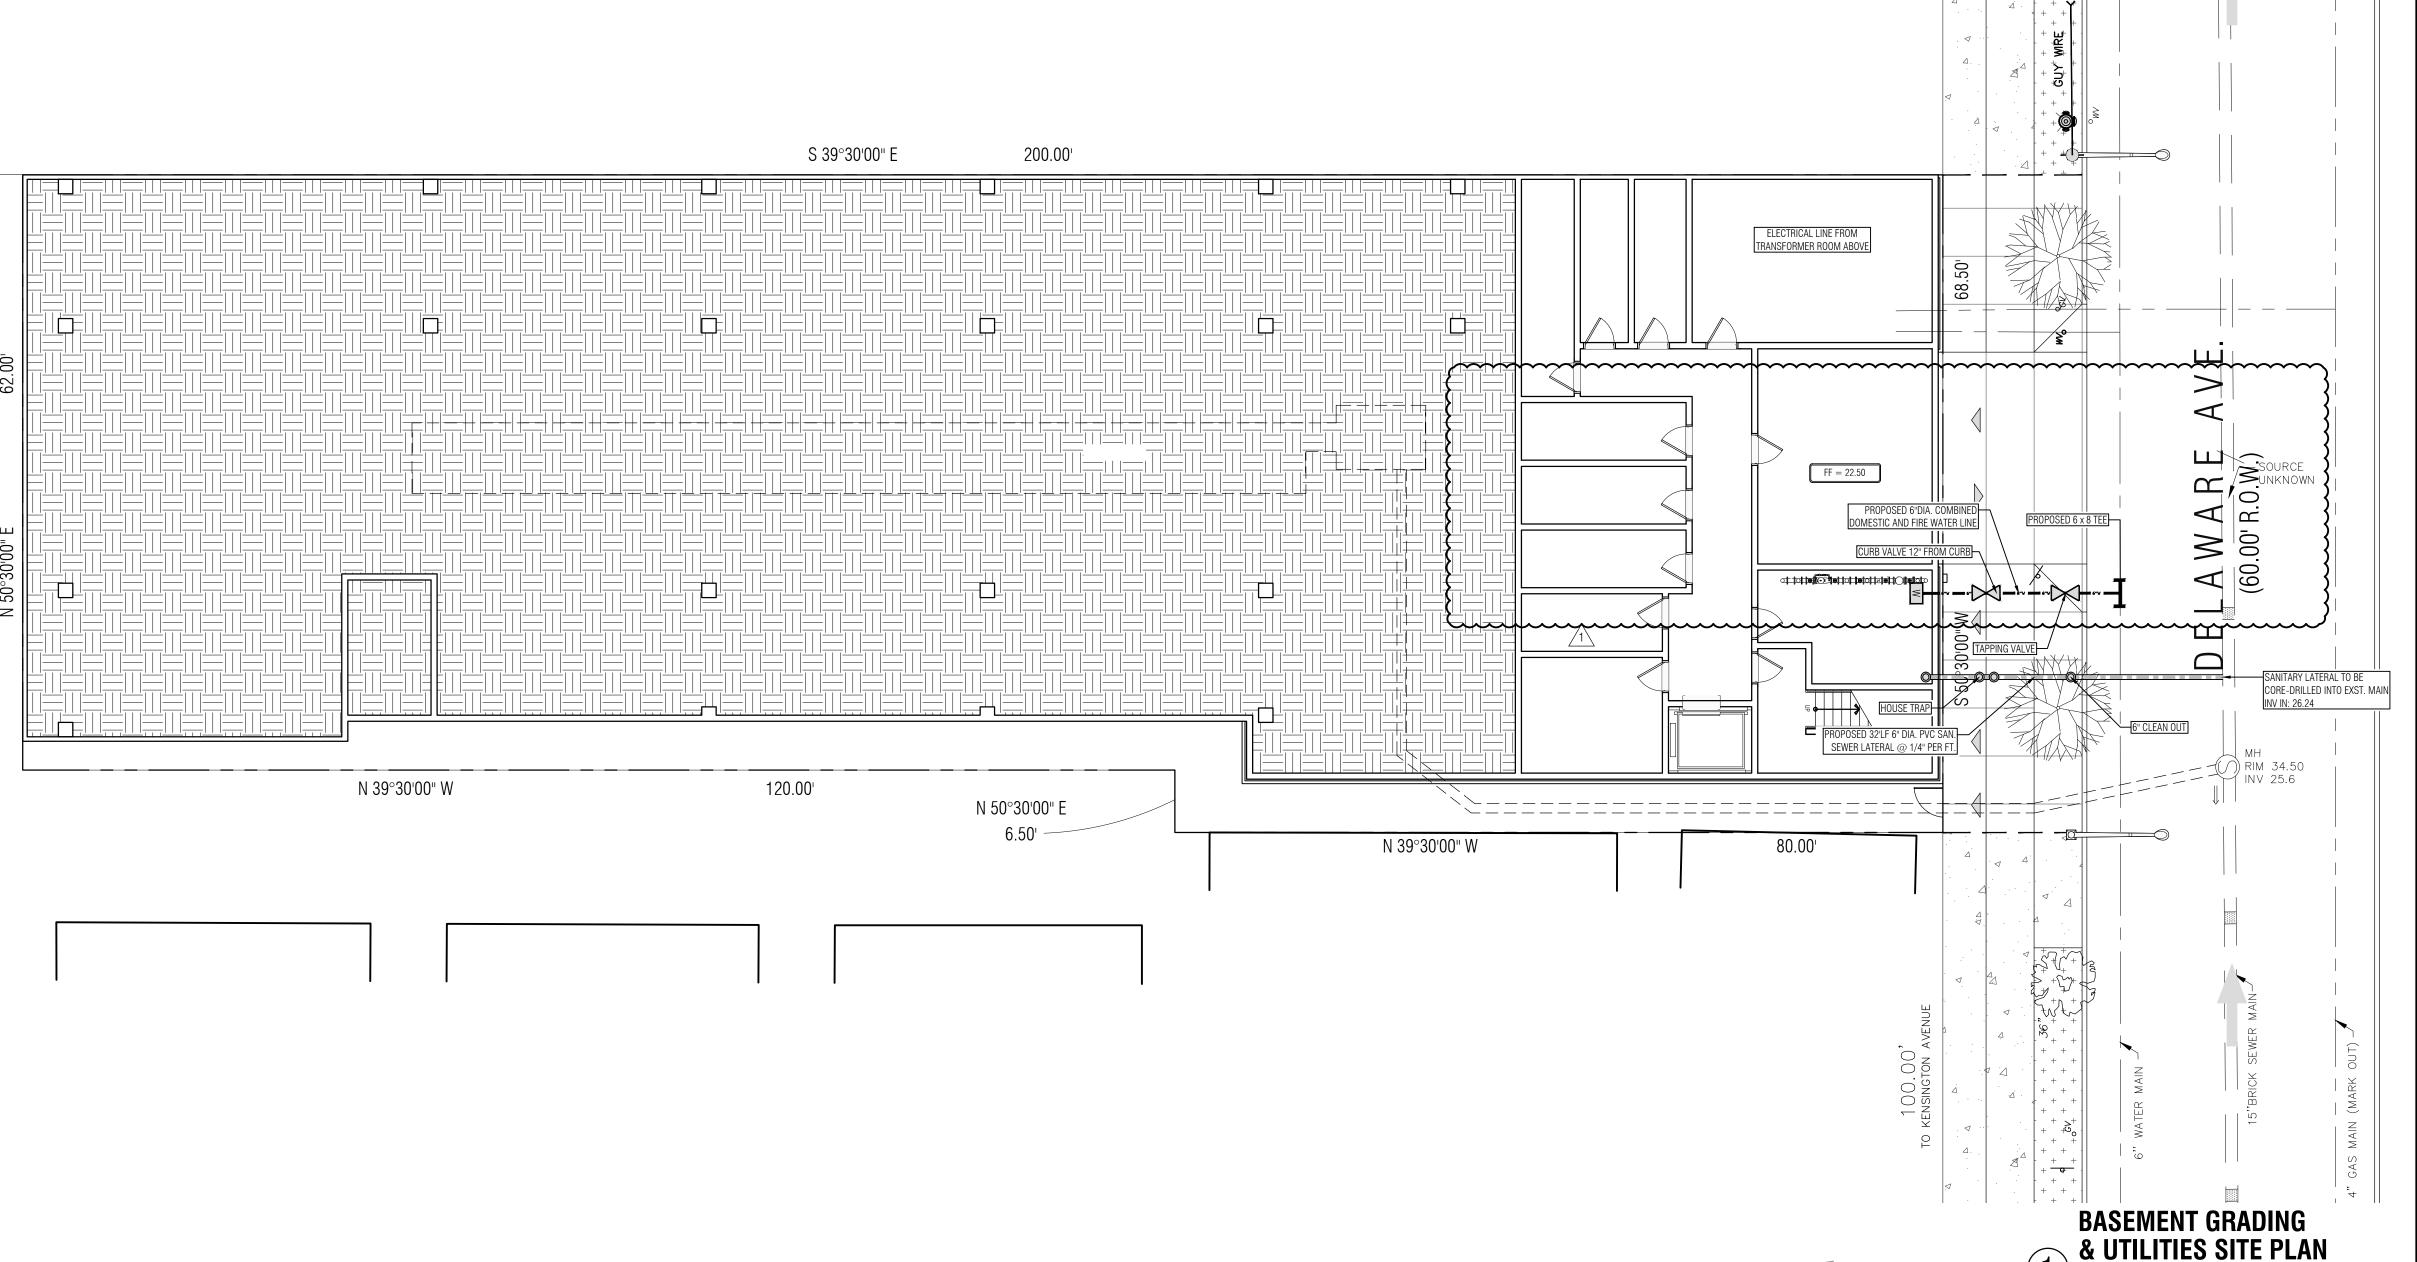

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JCMUA UPDATES

SHEET TITLE: BASEMENT GRADING & UTILITIES SITE PLAN

JCMUA STANDARD REQUIREMENTS FOR NEW SANITARY AND STORM SEWERS AND SERVICE LATERALS

PLANS AND ANY ADDITIONAL INFORMATION AS APPLICABLE MUST BE PRESENTED TO THE JCMUA FOR REVIEW AND COMMENTS FOR ALL PROPOSED SANITARY AND STORM SEWER CONNECTIONS TO THE JCMUA SEWER SYSTEM OR THAT ARE PROPOSED IN JERSEY CITY. REPAIRS TO EXISTING SERVICES DO NOT REQUIRE THE REVIEW AND APPROVAL OF THE JCMUA ALL PLANS MUST BE SIGNED AND SEALED BY A PROFESSIONAL ENGINEER OR REGISTERED ARCHITECT LICENSED TO PRACTICE IN NEW JERSEY AND SUBMITTED TO THE JCMUA'S SEWER ENGINEERING OFFICE, 555 ROUTE 440, JERSEY CITY, NJ 07305 FOR APPROVAL.

THE FOLLOWING TECHNICAL REQUIREMENTS SHALL BE ADDRESSED IN PREPARATION OF SITE/UTILITY PLANS:

- 1.) ALL SEWER SERVICE CONNECTIONS 6-INCHES IN SIZE OR SMALLER MUST BE MADE DIRECTLY TO THE SEWER MAIN AND ALL CONNECTIONS 8-INCHES IN SIZE OR LARGER MUST BE MADE TO A MANHOLE. WHERE A CONNECTION TO A MANHOLE IS REQUIRED, MANHOLE BENCH AND CHANNEL MAY REQUIRE MODIFICATION.
- 2.) THE JCMUA REQUIRES THAT SEWER SERVICE CONNECTIONS TO BE RE-USED BE TELEVISED TO VERIFY STRUCTURAL INTEGRITY AND THAT THE PIPE IS FREE FROM ANY DEFECTS OR OBSTRUCTIONS.
- 3.) EACH BUILDING SERVICE LATERAL STORM AND SANITARY MUST HAVE A T-WYE CLEANOUT INSTALLED APPROXIMATELY I-FT FROM THE CURB IN THE SIDEWALK. CLEANOUTS SHALL BE 5" (MIN) CAST IRON FERRULE WITH A 4" IBTS BRASS CAP. T-WYE CLEANOUTS WHICH ENABLE CLEANING IN BOTH DIRECTIONS SHOULD BE INSTALLED ON BOTH THE STORM AND SANITARY LATERAL. SEE OUR DETAIL TITLED "STANDARD SANITARY CLEANOUT" (REFER TO ATTACHED DETAIL DRAWINGS).
- 4.) PROPOSED SEWER LATERAL CONNECTION TO JCMUA'S SEWER MAIN SHALL BE MADE ABOVE HORIZONTAL CENTER LINE OF PIPE (REFER TO ATTACHED SEWER SERVICE CONNECTION DETAILS).
- 5.) THE SIZE, MATERIAL, DEPTH, CONDITION, DIRECTION OF FLOW AND ANY OTHER RELEVANT CONDITIONS OF THE EXISTING JCMUA SEWER TO WHICH YOU PLAN TO CONNECT MUST BE FIELD VERIFIED BY DEVELOPER TO DETERMINE IF SAID CONNECTION IS PHYSICALLY POSSIBLE AND PRACTICAL. IN ADDITION, MANHOLE INVERTS AND RIM ELEVATION MUST BE SHOWN ON PLANS. THIS VERIFICATION IS TO BE INCLUDED ON THE PLANS FOR THE PROJECT.
- 6.) CIRCULAR HOLE SAWS OR CORE DRILLS APPROPRIATELY SIZED TO MAKE THE OPENINGS IN THE EXISTING SEWER TO RECEIVE THE LATERALS MUST BE USED. JACKHAMMERS

 SLEDGEHAMMERS AND OTHER UNSUITABLE TOOLS OR MACHINERY WHICH MAV DAMAGE THE JCMUAS SEWER MAIN ARE NOT ALLOWED TO BE USED TO MAKE THE LATERAL OPENINGS. ALL DEBRIS MUST BE REMOVED AND NOT ALLOWED TO FALL INTO PIPE.
- 7.) A DETAIL OF ANY PROPOSED MANHOLE OR CATCH BASIN SHOWING ALL DIMENSIONS IN ADDITION TO RIM, GRATE AND INVERT ELEVATIONS OF THE STRUCTURE AND ALL PIPES CONNECTED TO THE STRUCTURE MUST BE SHOWN ON PLANS. REFER TO JCMUA STANDARD DETAIL DRAWINGS FOR MANHOLES AND CATCH BASINS.
- 8.) PROPOSED MANHOLES CONSTRUCTED IN THE PUBLIC R.O.W. ON EXISTING OR PROPOSED JCMUA SEWERS SHALL BE FURNISHED WITH CONCENTRIC MANHOLE COVERS AS MANUFACTURED BY CAMPBELL FOUNDRY CO., PATTERN #4428 OR EQUAL WITH OUTSIDE COVER DIAMETER OF 31-3/4 INCHES AND INSIDE COVER DIAMETER OF 24 INCHES.

 THE LETTERS "JCMUA" AND "SEWER" SHALL BE CAST IN THE OUTER FACE COVER. MANHOLE FRAMES SHALL BE CAMPBELL FOUNDRY CO. PATTERN #4428 (FOR 30-INCH OPENING) OR #1206 (FOR 41 -INCH OPENING) OR EQUAL FURNISHED WITH A PATTERN #4428 CONCENTRIC COVER AS SPECIFIED IN THE PRECEDING PARAGRAPH.

 REFER TO JCMUA'S STANDARD DETAIL FOR MANHOLE FRAME AND COVERS.
- 9.) STORM INLETS WHICH ARE CONNECTED DIRECTLY TO JCMUA COMBINED SEWERS MUST BE FURNISHED WITH A SUMP AND TRAP AS PER JCMUA STANDARD DETAILS.
- 1 0.) THE JCMUA HAS A COMBINED SEWER SYSTEM WHICH SURCHARGES DURING WET WEATHER PERIODS RESULTING IN POSSIBLE SEWAGE BACK-UPS THROUGH PLUMBING FIXTURES (SINKS, TOILETS, FLOOR DRAINS, ETC.) BELOW STREET LEVEL. JCMUA WILL NOT BE RESPONSIBLE FOR ANY POSSIBLE SEWAGE BACK-UPS AND FLOODING IN BASEMENTS DUE TO SURCHAR IN SEWER CONDITIONS IN WET WEATHER EVENTS. THIS POSSIBILITY MUST BE ADDRESSED DURING THE DESIGN AND CONSTRUCTION PHASE.
- 1 1 .) A DROP MANHOLE CONNECTION SHALL BE USED WHERE THERE IS A DIFFERENCE IN ELEVATION OF TWO (2) FEET OR GREATER BETWEEN THE INVERT OF A SANITARY OR COMBINED INLET PIPE TO MANHOLE AND THE CROWN OF THE OUTLET PIPE FROM MANHOLE. REFER TO ATTACHED JCMUA:S STANDARD DETAIL FOR DROP MANHOLE CONNECTION WHICH MUST BE SHOWN ON SITE PLAN IF REQUIRED.
- 1 2.) TEST PITS MUST BE PERFORMED AT THE DEVELOPERS EXPENSE DURING THE <u>DESIGN</u> PHASE OF THE PROJECT TO ENSURE THAT PROPOSED SEWERS AND SEWER SERVICES MAY BE CONSTRUCTED AS PROPOSED WITHOUT CONFLICTING WITH OTHER UNDERGROUND UTILITIES OR STRUCTURES.
- 1 3.) LATERAL CONNECTIONS MUST BE CUT 8-INCHES FROM SEWER MAIN, A NON-HUB STAINLESS STEEL COUPLING AND A 6-INCH LONG SECTION OF SCH-40 PVC PIPE WITH CAP MUST BE INSTALLED AS PER ATTACHED "JCMUA -- SEWER LATERAL ABANDONMENT DETAIL". ALL EXISTING SEWER MAINS AND UPSTREAM SANITARY LATERALS TO BE ABANDONED MUST BE FILLED WITH CONCRETE SLURRY OR REMOVED FROM THE GROUND. PRECAUTIONS MUST BE UNDERTAKEN BY THE CONTRACTOR TO ENSURE CONCRETE AND OTHER MATERIALS DO NOT ENTER THE SEWER MAIN AND CREATE OBSTRUCTION(S). CATCH BASINS AND MANHOLES MUST BE REMOVED FROM THE GROUND.
- 14.) ALL NEW SANITARY AND STORM LATERAL CONNECTIONS INTO THE COMBINED SEWERS AND ALL SANITARY AND STORM LATERAL DISCONNECTIONS MUST BE WITNESSED AND INSPECTED BY JCMUA INSPECTORS. JCMUA MUST BE NOTIFIED TWO DAYS IN ADVANCE PRIOR TO MAKING ANY SANITARY AND STORM LATERAL CONNECTIONS OR DISCONNECTIONS. ALL NOTIFICATIONS MUST BE DONE BY CETTIFIED MAIL: JCMUA ENGINEERING, 555 ROUTE 440 JERSEY CITY, NEW JERSEY 07305 OR EMAIL: engineering@icmua.com.
- 1 5.) BEDDING AND BACKFILL MATERIAL SHALL COMPLY WITH THE REQUIREMENTS OF THE NJDOTS STANDARD SPECIFICATION FOR ROAD AND BRIDGE CONSTRUCTION, AND THE DESIGN AND CONSTRUCTION OF URBAN STORMWATER MANAGEMENT SYSTEMSR ASCE MANUALS AND REPORTS OF ENGINEERING PRACTICE NO. 77, 1993, AS APPLICABLE.
- 16.) STREET PAVEMENT MUST RESTORE AND INFRARED AS PER JERSEY CITY DIVISION OF ENGINEERING, TRAFFIC AND TRANSPORTATION REQUIREMENTS.
- 17.) ALL PROPOSED INLETS/CATCH BASINS MUST BE CONSTRUCTED WITH A BICYCLE SAFE GRATE AND CAMPBELL FOUNDRY CO. TYPE "N" CURB PIECE WHERE REQUIRED.
- 18.) PROPOSED WATER SERVICES REQUIRE THE REVIEW AND APPROVAL OF THE JCMUA ENGINEERING DEPARTMENT.
- 19.) THE CONTRACTOR IS RESPONSIBLE FOR OBTAINING PERMITS FOR STREET OPENINGS FROM THE

JERSEY CITY DIVISION OF ENGINEERING, TRAFFIC AND TRANSPORTATION LOCATED AT 13-15 EAST LINDEN AVE, JERSEY CITY, NJ AND ALL OTHER APPLICABLE PERMITS FROM AGENCIES HAVING JURISDICTION.

THE SYSTEM DESIGNER IS ALSO RESPONSIBLE FOR COMPLIANCE WITH THE APPLICABLE REGULATIONS OF THE NEW JERSEY ADMINISTRATIVE CODE, NJDEP RULES AND REGULATIONS GOVERNING TREATMENT WORKS APPROVAL PROGRAM, LOCAL CODES AND ORDINANCES, FEDERAL AND STATE REGULATIONS ETC. IN ADDITION TO OTHER REQUIREMENTS THAT MAY BE IMPOSED BY THE JCMUA.

12/26/18

JCMUA REQUIREMENT FOR FIRE AND DOMESTIC WATER LINE AND METER INSTALLATIONS

- 1.) ALL FIRE SERVICE APPLICATIONS AND ALL DOMESTIC SERVICE APPLICATIONS TWO (2) INCHES AND LARGER MUST BE SUBMITTED TO THE JCMUA'S BUREAU OF WATER ENGINEERING FOR APPROVAL. FIVE (5) SETS OF PLANS SHALL BE SUBMITTED FOR APPROVAL. ALL PLANS SHALL BE SIGNED AND SEALED BY A PROFESSIONAL ENGINEER OR REGISTERED ARCHITECT LICENSED TO PRACTICE IN NEW JERSEY.
- 2.) SUBMITTED PLANS SHALL BE STANDARD ENGINEERING DRAWINGS, SIZE 24 INCHES X 36 INCHES. INCLUDED SHALL BE A SITE PLAN SHOWING ADJACENT STREETS WITH WATER MAIN. SERVICE. AND DETAILS INDICATED. ALSO INCLUDED SHALL BE A KEY MAP SHOWING GENERAL LOCATION WITHIN THE CITY.
- 3.) INDICATED ON THE SUBMITTED PLANS SHALL BE THE SIZE OF TAP, LOCATION OF TAPPING AND CURB GATE VALVES, DETAILED METER SET-UP, AND SIZE OF THE FACILITY'S METER.

 ALSO INDICATED ON THE PLANS SHALL BE THE TYPE OF OCCUPANCY OF THE FACILITY RECEIVING THE WATER SERVICE. (I.E. HOSPITAL, WAREHOUSE, APARTMENT BUILDING, ETC.)
- 4.) ALL EXISTING WATER SERVICE LINES TO BE ABANDONED SHALL BE CUT AND CAPPED AT THE MAIN, IN ACCORDANCE WITH JCMUA STANDARDS, AND INSPECTED WITHIN 24 HOURS AFTER INSTALLATION OF NEW TAP. THE MAXIMUM OF ONE (1) TAP SHALL BE MADE FOR BOTH DOMESTIC AND FIRE SERVICE PER FACILITY. THE TAP SHALL BE THE MAXIMUM OF ONE (1) SIZE SMALLER THAN THE CITY'S WATER MAIN. NO TAPPING SHALL BE DONE BY ANYONE EXCEPT BY UNITED WATER JERSEY CITY (UWJC) UNLESS SPECIFICALLY APPROVED BY JCMUA
- 5.) ONLY ONE DOMESTIC/ FIRE SERVICE IS ALLOWED FOR EACH FACILITY. APPLICANT MAY INSTALL CHECK METERS ON INDIVIDUAL BRANCH CONNECTIONS DOWNSTREAM OF DOMESTIC METER SETUP WHERE THERE IS MORE THAN ONE OWNER/TENANT FOR A FACILITY. HOWEVER, ONLY ONE WATER BILL WILL BE ISSUED FOR THE FACILITY.
- 6.) A SOLID DUCTILE IRON TAPPING SLEEVE SUCH AS MUELLER H-615 TAPPING SLEEVE OR APPROVED EQUAL SHALL BE UTILIZED FOR ALL TAPS 2-INCHES AND LARGER. THE TAPPING SLEEVE SHALL PASS PRESSURE TESTING BASED ON AWWA STANDARDS BEFORE TAP IS MADE.
- 7.) FOR ALL SERVICES INCLUDED HEREIN, TWO (2) GATE VALVES ARE REQUIRED THAT ARE TO BE INSTALLED BY THE APPLICANT; A TAPPING VALVE, LOCATED AT THE TAP AND CURB VALVE, LOCATED IN THE SIDEWALK BEFORE THE METER. TAPPING GATES SHALL BE FURNISHED OPENED RIGHT. ALL TAPPING AND CURB VALVES SHALL BE DOUBLE DISC GATE VALVES AND MEET AWWA STANDARDS. THE WET TRAP UP TO 12 INCHES SHALL BE PERFORMED BY UWJC.
- 8.) FOR TAPS OF MAINS SIXTEEN (16) INCHES AND LARGER, THE APPLICANT SHALL FURNISH AND INSTALL AN ADDITIONAL GATE VALVE ADJACENT TO THE TAPPING VALVE. NO TAPS SHALL BE PERMITTED ON MAINS LARGER THAN TWENTY (20) INCHES UNLESS THERE IS NO ALTERNATIVE WATER SOURCE, AND SPECIAL WRITTEN APPROVAL IS ISSUED BY THE JCMUA.
- 9.) VALVE BOX PARTS FOR ALL VALVES SHALL BE PROVIDED BY THE APPLICANT. ALL TAPPING GATE VALVES LARGER THAN 2-INCHES AND ALL CURB VALVES/ STOPS REGARDLESS OF SIZE REQUIRE A VALVE BOX WITH THE WORD "WATER" CAST IN THE COVER. BURIED CORPORATION VALVES/ STOPS SHALL BE USED AT THE TAP FOR CLASS K COPPER SERVICES 2-INCHES AND SMALLER.
- 10.) ALL SERVICE PIPES, SIZES 2-INCHES THROUGH 12-INCHES, SHALL BE PRESSURE CLASS 350 PSI, CEMENT-LINED DUCTILE IRON PIPE WITH MECHANICAL JOINTS.
- 11.) THE APPLICANT SHALL INSTALL THE METER INSIDE THE BUILDING. I F THE BUILDING LINE IS IN EXCESS OF 75 FT. FROM THE MAIN, THE APPLICANT SHALL PLACE THE METER IN A PIT NEAR THE SIDEWALK OR STREET IN CLOSE PROXIMITY TO THE TAP.
- 12.) FOR A REGULAR FIRE SUPPRESSION SYSTEM (COMBINED SERVICE LINE LARGER THAN 2"), A COMBINED REDUCED PRESSURE DETECTOR ASSEMBLY (AMES 5000 SS, AMES 5000 RPDA OR WATTS 909 RPDA*) SHALL BE INSTALLED ON THE MAIN FIRE SERVICE LINE AND A REDUCED PRESSURE BACKFLOW PREVENTER ON THE BYPASS (AMES 4000 SS OR WATTS 909*) (REFER TO FIGURE 1). ON THE LIMITED FIRE SUPPRESSION SYSTEM (COMBINED SERVICE LINE 1.5" OR 2"), A FIRE LINE DETECTOR CHECK WITH A SINGLE CHECK VALVE (AMES 1000 DCV*) SHALL BE INSTALLED ON THE MAIN FIRE LINE AND A REDUCED PRESSURE BACKFLOW PREVENTER (AMES 4000 SS OR WATTS 909*) SHALL BE INSTALLED DOWNSTREAM OF THE BYPASS (REFER TO FIGURE 2). ALL REGULAR FIRE SUPPRESSION SYSTEMS MUST HAVE 0S&Y VALVES, HOWEVER, LIMITED FIRE SUPPRESSION SYSTEMS MAY USE BALL VALVES (VICTAULIC SERIES 728 FIRELOCK*) INSTEAD OF 0S&Y VALVES. THE FIRE UNIT SHALL BE FURNISHED WITH A 5/8 INCH X 3/4 INCH METERED BYPASS. BYPASS METERS SHALL BE JERSEY CITY STANDARD SINGLE DISPLACEMENT SENSUS METERS WITH TOUCHPAD AND RADIO READ CAPABILITIES. THE SAME RADIO MXU UNIT SHALL BE USED FOR A COMBINED DOMESTIC AND FIRE SERVICE.
- 13.) FOR DOMESTIC SERVICE, AN APPROVED REDUCED PRESSURE BACKFLOW PREVENTER (AMES 4000 SS OR WATTS 909*) IS REQUIRED WHEN THE JCMUA DETERMINES THAT THERE IS A CROSS-CONNECTION HAZARD AND THE FACILITY PRESENTS A THREAT TO THE CITY'S DISTRIBUTION SYSTEM WATER QUALITY IN ACCORDANCE WITH THE PLUMBING SUBCODE OF THE NEW JERSEY STATE UNIFORM CONSTRUCTION CODE, NJAC 5:23-3.15 AND THE NEW JERSEY SAFE DRINKING WATER ACT NJAC 7:10-10 PHYSICAL CONNECTIONS AND CROSS CONNECTIONS CONTROL BY CONTAINMENT. SOME SERVICES WHICH REQUIRE SUCH DEVICES INCLUDE: A HOSPITAL, SCHOOL, CHEMICAL PLANT, FACTORY, AND A FACILITY WITH SEWAGE EJECTORS. 14.) ALL NEW SANITARY AND STORM LATERAL CONNECTIONS INTO THE COMBINED SEWERS AND ALL SANITARY AND STORM LATERAL DISCONNECTIONS MUST BE WITNESSED AND INSPECTED BY JCMUA INSPECTORS. JCMUA MUST BE NOTIFIED TWO DAYS IN ADVANCE PRIOR TO MAKING ANY SANITARY AND STORM LATERAL CONNECTIONS OR DISCONNECTIONS. ALL NOTIFICATIONS MUST BE DONE BY CETTIFIED MAIL: JCMUA ENGINEERING, 555 ROUTE 440 JERSEY CITY, NEW JERSEY 07305 OR EMAIL: ENGINEERING@ICMUA.COM.
- 14.) IF A REDUCED PRESSURE BACKFLOW PREVENTER IS NOT REQUIRED ON THE DOMESTIC SERVICE, A CHECK VALVE SHOULD BE INSTALLED DOWNSTREAM OF THE TEST TEE.
- 15.) ALL METERS SIZES 2 INCHES THROUGH 6 INCHES SHALL BE SINGLE COMPOUND METERS AND ALL METERS 8 INCHES AND LARGER SHALL BE DUPLEX COMPOUND MANIFOLD METERS.
- 16.) ALL METERS SHALL BE ADEQUATELY RESTRAINED WITH METAL BRACKETS FASTENED TO THE FLOOR OR WALL OR OTHER APPROVED MEANS SUCH AS UNIFLANGES WHERE INTERNAL PIPE PRESSURE AND FLOW WARRANT SUCH RESTRAINTS. METERS, DETECTOR CHECKS, AND VALVES MAY BE SEATED ON CONCRETE BLOCK AND TAPERED SHIMS TO PROVIDE ADEQUATE SUPPORT. METERS SHALL BE INSTALLED APPROXIMATELY 36" ABOVE FLOOR GRADE.
- 17.) ALL METER INSTALLATIONS IN METER PIT OR VAULT SHALL BE PRE-APPROVED BY JCMUA AND HAVE PROPER ACCESS OPENINGS FOR METER READING AND REPLACEMENT.
- 18.) EACH COMPOUND METER SHALL HAVE STRAINER INSTALLED ON THE INLET SIDE IMMEDIATELY BEFORE THE METER. ALL STRAINERS MUST BE PURCHASED FROM JCMUA OR ITS AUTHORIZED AGENT.
- 19.) ALL METERS 2" AND LARGER SHALL BE FURNISHED WITH SENSUS ECR/WP REMOTE TOUCH PAD MODULES AND RADIO MXU UNITS FOR BOTH TYPES OF READING CAPABILITIES.

 20.) REMOTE TOUCH PAD MODULE WIRE SHALL BE CONNECTED TO THE METER REGISTER UTILIZING A GEL CAP FOR WATERTIGHT SEALING OF ALL TERMINAL CONNECTIONS. TOUCH PADS
- MAY BE WALL MOUNTED OR LID MOUNTED WHERE A METER PIT IS UTILIZED. TOUCH PADS ARE TO BE INSTALLED ON EXTERIOR BUILDING WALL FACING THE STREET AND LOCATED AS CLOSE AS POSSIBLE TO STREET. THE RADIO MXU UNIT MUST BE INSTALLED WITH MOUNTING BRACKET AND LIKEWISE IS TO BE INSTALLED IN PROXIMITY TO STREET.
- 21.) ALL INSTALLATIONS OF EQUIPMENT AND COMPONENTS SHALL BE PERFORMED IN ACCORDANCE WITH MANUFACTURER'S RECOMMENDATIONS.
- 22.) ALL METERS INCLUDING TOUCH PAD MODULES, AND RADIO MXU UNITS SHALL BE PURCHASED THROUGH THE PERMIT CLERK AT JCMUA OFFICE. APPROVED PLANS MUST BE SUBMITTED TO THE PERMIT CLERK FOR ISSUANCE OF REQUIRED PERMITS.
- 23.) AFTER OBTAINING THE REQUIRED PERMITS (STREET OPENING, TAP, AND METER) THE APPLICANT SHALL CALL UWJC AT (201) 239-1108 TO SCHEDULE THE TAP. THE EXCAVATION SHALL BE COMPLETED TWENTY-FOUR (24) HOURS PRIOR TO THE SCHEDULED TAP, AND VERIFIED BY JCMUA OR ITS AUTHORIZED AGENT BEFORE THE TAP WILL BE INSTALLED.

 EXCAVATION SHALL BE CONSTRUCTED IN ACCORDANCE WITH OSHA REQUIREMENTS FOR SHEETING AND SAFETY.
- 24.) UPON COMPLETION OF THE INSTALLATION, THE APPLICANT SHALL SUBMIT THREE (3) SETS OF "AS BUILT" PLANS, TO THE JCMUA'S BUREAU OF WATER ENGINEERING. THE JCMUA WILL AUTHORIZE SUPPLY WATER UPON ACCEPTANCE OF THE "AS BUILT" DRAWINGS.

* SPECIFIED MODEL OR APPROVED EQUAL

06/28/06



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REVISIONS:

JCMUA UPDATES 01.11.2021

JCMUA UPDATES 01.11.2

(NEW SHEET) 190

BASEMENT GRADING & UTILITIES SITE PLAN

SHEET:

C-1.22

SEQUENCE OF CONSTRUCTION			
WEEK 1 (01/2021)	INSTALL PERIMETER FENCING AND SILT FENCE. INSTALL TEMPORARY CONSTRUCTION ENTRANCE WHEEL CLEANING BEDS.		
WEEK 2-6 (01 - 02 / 2021)	DEMOLITION OF EXISTING STRUCTURES AND PARKING AREA		
WEEK 7-15 (02-04/2021)	FOUNDATION EXCAVATION, SITE CLEANUP & SOIL REMOVAL, STOCKPILING OF TOPSOIL & BACKFILL.		
WEEK 16-18(04-05/2021)	EXCAVATION & INSTALLATION OF STORM WATER PIPING AND DRAINAGE STRUCTURES. INSTALLATION OF DRAINAGE STRUCTURE FILTERS		
WEEK 16-78(04/2021 - 06/2022)	FRAMING AND INTERIOR WORK IN BUILDINGS.		
WEEK 46-50 (11-12/2021)	SITE PAVING AND LANDSCAPING		
WEEK 50 (12/2021)	REMOVAL OF SOIL EROSION AND SEDIMENT CONTROL MEASURES AFTER FINAL PAVING AND LANDSCAPING IS COMPLETED.		

SITE MANAGEMENT AND PREPARATION EXEMPTION

OUR SITE IS AN URBAN ENTERPRISE ZONE AND IS A "PREVIOUSLY DEVELOPED" AREA IN ACCORDANCE WITH THE DESCRIPTION FROM SECTION 6.1. THEREFORE OUR SITE IS EXEMPT FROM SITE MANAGEMENT & PREPARATION

STABALIZATION SPECIFICATIONS

- TEMPORARY SEEDING AND MULCHING: LIME- 90 LBS./1,000 SF GROUND LIMESTONE; FERTILIZER-14 LBS./1,000 SF; 10-20-10 OR EQUIVALENT WORKED INTO SOIL A MINIMUM OF 4". SEED- PERENNIAL RYEGRASS 40 LBS./ACRE OR OTHER APPROVED SEEDS; MULCH- SALT HAY OR SMALL GRAIN STRAW AT A RATE OF 70 TO 90 LBS./1,000 SF, TO BE APPLIED ACCORDING TO THE NJ STANDARDS. MULCH SHALL BE SECURED BY APPROVED METHODS (I.E. PEG AND TWINE, MULCH NETTING, OR LIQUID MULCH BINDING).
- PERMANENT SEEDING AND MULCHING: TOPSOIL UNIFORM APPLICATION TO A DEPTH OF 4" (UNSETTLED) LIME-90 LBS./1,000 SF GROUND LIMESTONE; FERTILIZER-11 LBS./1,000 SF; 10-20-10 OR EQUIVALENT WORKED INTO SOIL A MINIMUM OF 4". SEED - TURF TYPE TALL FESCUE (BLEND OF 3 CULTIVARS) 150 LBS./ACRE (3.5 LBS./1,000 SF) OR OTHER APPROVED SEEDS MULCH- SALT HAY OR SMALL GRAIN STRAW AT A RATE OF 70 TO 90 LBS./1,000 SF TO BE APPLIED ACCORDING TO THE NJ STANDARDS. MULCH SHALL BE SECURED BY APPROVED METHODS (I.E. PEG AND TWINE, MULCH NETTING, OR LIQUID MULCH BINDING). GRASS AREAS - AREAS DESIGNATED AS GRASS, OR DISTURBED AREAS NOT DESIGNATED FOR ANY OTHER PLANTINGS SHALL BE PERMANENTLY STABALIZED BY SEEDING WITH THE BUFFALO SUPREME SEED MIXTURE AT THE RATE OF 3 LBS/1,000 S.F. SOIL PREPARATION, SEEDING, MULCHING AND MAINTENANCE SHALL BE DONE AS INDICATED IN THE PLANTING NOTES AND THE DETAILS HEREIN.

DUST CONTROL STANDARDS

PLANNING CRITERIA

THE FOLLOWING METHODS SHOULD BE CONSIDERED FOR CONTROLLING DUST:

MULCHES - SEE STANDARD OF STABILIZATION WITH MULCHES ONLY, PG. 5-1

VEGETATIVE COVER - SEE STANDARD FOR: TEMPORARY VEGETATIVE COVER, PG. 7-1

PERMANENT VEGETATIVE COVER FOR SOIL STABILIZATION PG. 4-1 AND PERMANENT STABILIZATION WITH SOD, PG. 6-1 SPRAY-ON ADHESIVES - ON MINERAL SOILS (NOT EFFECTIVE ON MUCK SOILS). KEEP TRAFFIC OFF THESE AREAS.

TILLAGE - TO ROUGHEN SURFACE AND BRING CLODS TO THE SURFACE. THIS IS A TEMPORARY EMERGENCY MEASURE WHICH SHOULD BE USED BEFORE SOIL BLOWING STARTS. BEGIN PLOWING ON WINDWARD SIDE OF SITE. CHISEL-TYPE PLOWS SPACED ABOUT 12 INCHES APART AND SPRING-TOOTHED HARROWS ARE EXAMPLES OF EQUIPMENT WHICH MAY PRODUCE THE DESIRED EFFECT.

SPRINKLING - SITE IS SPRINKLED UNTIL THE SURFACE IS WET.

BARRIERS - SOLID BOARD FENCES, SNOW FENCES, BURLAP FENCES, CRATE WALLS, BALES OF HAY AND SIMILAR MATERIAL CAN BE USED TO CONTROL AIR CURRENTS AND SOIL BLOWING.

CALCIUM CHLORIDE - SHALL BE IN THE FORM OF LOOSE, DRY GRANULES OR FLAKES FINE ENOUGH TO FEED THROUGH COMMONLY USED SPREADERS AT A RATE THAT WILL KEEP SURFACE MOIST BUT NOT CAUSE POLLUTION OR PLANT DAMAGE. IF USED ON STEEPER SLOPES, THEN USE OTHER PRACTICES TO PREVENT WASHING INTO STREAMS OR ACCUMULATION AROUND PLANTS.

STONE - COVER SURFACE WITH CRUSHED STONE OR COARSE GRAVEL.

TABLE 16-1 DUST CONTROL MATERIALS

		İ		
MATERIAL	WATER DILUTION	TYPE OF NOZZLE	APPLY GALLONS/ACRE	
ANIONIC ASPHALT EMULSION	7:1	COARSE SPRAY	1200	
LATEX EMULSION	12.5:1	FINE SPRAY	235	
RESIN IN WATER	4:1	FINE SPRAY	300	
POLYACRYLAMIDE (PAM)- SPRAY ON POLYACRYLAMIDE (PAM)- DRY SPREAD	APPLY ACCORDING TO MANUFACTURER'S INSTRUCTIONS. MAY ALSO BE USED AS AN ADDITIVE TO SEDIMENT BASINS TO FLOCCULATE AND PRECIPITATE SUSPENDED COLLOIDS. SEE SEDIMENT BASIN STANDARD (PG 26-1 STANDARDS FOR SOIL EROSION AND SEDIMENT CONTROL IN NEW JERSEY 2014, REVISED 2017)			
ANIONIC ASPHALT EMULSION	NONE	COARSE SPRAY	1200	

EROSION AND SEDIMENT CONTROL NOTES (REVISED DECEMBER 2017)

1. THE CONTRACTOR IS RESPONSIBLE FOR SOIL EROSION AND SEDIMENT CONTROL IN ACCORDANCE WITH LOCAL, STATE, AND FEDERAL REQUIREMENTS.

THE CONTRACTOR IS RESPONSIBLE FOR DUST CONTROL AND COMPLIANCE WITH LOCAL, STATE, AND FEDERAL AIR QUALITY STANDARDS. THE CONTRACTOR IS RESPONSIBLE TO INSPECT ALL SOIL EROSION MEASURES WEEKLY AND AFTER A PRECIPITATION EVENT GREATER THAN 1 INCH. THE CONTRACTOR SHALL

MAINTAIN AN INSPECTION LOG ON SITE AND DOCUMENT CORRECTIVE ACTION AS REQUIRED TAKEN THROUGHOUT THE COURSE OF CONSTRUCTION. A SOIL EROSION AND SEDIMENT CONTROL PERMIT MUST BE OBTAINED FROM THE DEPARTMENT OF ENGINEERING PRIOR TO COMMENCEMENT OF ANY DEMOLITION OR CONSTRUCTION ACTIVITY OF THE SITE.

SOIL CONSERVATION NOTES

- ALL SOIL EROSION AND SEDIMENT CONTROL PRACTICES ON THIS PLAN WILL BE CONSTRUCTED IN ACCORDANCE WITH THE "NEW JERSEY STANDARDS FOR SOIL EROSION AND SEDIMENT CONTROL" 7TH EDITION LAST REVISED DECEMBER 2017. THESE MEASURES WILL BE INSTALLED PRIOR TO ANY MAJOR SOIL DISTURBANCE OR IN THEIR PROPER SEQUENCE AND MAINTAINED UNTIL PERMANENT PROTECTION IS ESTABLISHED.
- ALL SOIL TO BE EXPOSED OR STOCKPILED FOR A PERIOD OF GREATER THAN 14 DAYS, AND NOT UNDER ACTIVE CONSTRUCTION, WILL BE TEMPORARILY SEEDED AND HAY MULCHED OR OTHERWISE PROVIDED WITH VEGETATIVE COVER. THIS TEMPORARY COVER SHALL BE MAINTAINED UNTIL SUCH TIME WHEREBY PERMANENT RESTABILIZATION IS ESTABLISHED. SEEDING DATES: THE FOLLOWING SEEDING DATES ARE RECOMMENDED TO BEST ESTABLISH PERMANENT VEGETATIVE COVER WITHIN MOST LOCATIONS IN THE HEPSCD: SPRING -
- /1-5/15 AND FALL 8/15 10/1 SEDIMENT FENCES ARE TO BE PROPERLY TRENCHED AND MAINTAINED UNTIL PERMANENT VEGETATIVE COVER IS ESTABLISHED
- ALL STORM DRAINAGE INLETS SHALL BE PROTECTED BY ONE OF THE PRACTICES ACCEPTED IN THE STANDARDS, AND PROTECTION SHALL REMAIN UNTIL PERMANENT STABILIZATION HAS BEEN ESTABLISHED. STORM DRAINAGE OUTLET POINTS SHALL BE PROTECTED AS REQUIRED BEFORE THEY BECOME FUNCTIONAL.
- MULCH MATERIALS SHALL BE UN-ROTTED SMALL GRAIN STRAW APPLIED AT THE RATE OF 70 TO 90 POUNDS PER 1,000 SQUARE FEET AND ANCHORED WITH A MULCH ANCHORING
- TOOL, LIQUID MULCH BINDERS, OR NETTING TIE DOWN. OTHER SUITABLE MATERIALS MAY BE USED IF APPROVED BY THE SOIL CONSERVATION DISTRICT. ALL EROSION CONTROL DEVICES SHALL BE PERIODICALLY INSPECTED, MAINTAINED AND CORRECTED BY THE CONTRACTOR. ANY DAMAGE INCURRED BY EROSION SHALL BE
- THE HUDSON-ESSEX-PASSAIC SOIL CONSERVATION DISTRICT WILL BE NOTIFIED IN WRITING AT LEAST 48 HOURS PRIOR TO ANY SOIL DISTURBING ACTIVITIES. FAX (862) 333-4507 9. THE APPLICANT MUST OBTAIN A DISTRICT ISSUED REPORT-OF-COMPLIANCE PRIOR TO APPLYING FOR THE CERTIFICATE OF OCCUPANCY OR TEMPORARY CERTIFICATE OF
- CCUPANCY FROM THE RESPECTIVE MUNICIPALITY, NJ DCA OR ANY OTHER CONTROLLING AGENCY. CONTACT THE DISTRICT AT 862-333-4505 TO REQUEST A FINAL INSPECTION, GIVING ADVANCED NOTICE UPON COMPLETION OF THE RESTABILIZATION MEASURES. A PERFORMANCE DEPOSIT MAY BE POSTED WITH THE DISTRICT WHEN WINTER WEATHER OR SNOW COVER PROHIBITS THE PROPER APPLICATION OF SEED, MULCH, FERTILIZER OR HYDRO-SEED.
- 0. PAVED ROADWAYS MUST BE KEPT CLEAN AT ALL TIMES. DO NOT UTILIZE A FIRE OR GARDEN HOSE TO CLEAN ROADS UNLESS THE RUNOFF IS DIRECTED TO A PROPERLY DESIGNED AND FUNCTIONING SEDIMENT BASIN. WATER PUMPED OUT OF THE EXCAVATED AREAS CONTAINS SEDIMENTS THAT MUST BE REMOVED PRIOR TO DISCHARGING TO RECEIVING BODIES OF WATER USING REMOVABLE PUMPING STATIONS, SUMP PITS, PORTABLE SEDIMENTATION TANKS AND/OR SILT CONTROL BAGS.
- 11. ALL SURFACES HAVING LAWN OR LANDSCAPING AS FINAL COVER ARE TO BE PROVIDED TOPSOIL PRIOR TO RE-SEEDING, SODDING OR PLANTING, A DEPTH OF 5.0 INCHES, FIRMED IN PLACE, IS REQUIRED, AS PER THE STANDARDS FOR TOPSOILING AND LAND GRADING, LAST REVISED DECEMBER 2017. 12. ALL PLAN REVISIONS MUST BE SUBMITTED TO THE DISTRICT FOR PROPER REVIEW AND APPROVAL
- 13. A CRUSHED STONE WHEEL CLEANING TRACKING-PAD IS TO BE INSTALLED AT ALL SITE EXITS USING 2 ½ -1" CRUSHED ANGULAR STONE (ASTM 2 OR 3) TO A MINIMUM LENGTH OF 50 FEET AND MINIMUM DEPTH OF 6". ALL DRIVEWAYS MUST BE PROVIDED WITH CRUSHED STONE UNTIL PAVING IS COMPLETE.
- 14. STEEP SLOPES INCURRING DISTURBANCE MAY REQUIRE ADDITIONAL STABILIZATION MEASURES. THESE "SPECIAL" MEASURES SHALL BE DESIGNED BY THE APPLICANT'S ENGINEER AND BE APPROVED BY THE SOIL CONSERVATION DISTRICT.

15. THE HUDSON-ESSEX-PASSAIC SOIL CONSERVATION DISTRICT SHALL BE NOTIFIED, IN WRITING, FOR THE SALE OF ANY PORTION OF THE PROJECT OR FOR THE SALE OF INDIVIDUAL

PROPOSED STOCK

N 39°30'00" W

PROPOSED

SILT FENCE

LIMIT OF DISTURBANCE:

14,713.70 SF

LOTS. NEW OWNERS' INFORMATION SHALL BE PROVIDED. ADDITIONAL MEASURES DEEMED NECESSARY BY DISTRICT OFFICIALS SHALL BE IMPLEMENTED AS CONDITIONS WARRANT.

STABALIZATION SPECIFICATIONS

S 39°30'00" E

TOTAL LOT AREA $12,\overline{920 \text{ SF}} = 0.297 \text{ Ac.}$

TOTAL ARE OF DISTURBANCE

14,621.29 SF = 0.34 Ac.SOIL TYPE UREOLB - URBAN LAND, EOLIAN

SUBSTRATUM

N 50°30'00" E

- TEMPORARY SEEDING AND MULCHING: LIME- 90 LBS./1.000 SF GROUND LIMESTONE: FERTILIZER-14 LBS./1.000 SF: 10-20-10 OR EQUIVALENT WORKED INTO SOIL A MINIMUM OF 4". SEED- PERENNIAL RYEGRASS 40 LBS./ACRE OR OTHER APPROVED SEEDS; MULCH- SALT HAY OR SMALL GRAIN STRAW AT A RATE OF 70 TO 90 LBS./1,000 SF, TO BE APPLIED ACCORDING TO THE NJ STANDARDS. MULCH SHALL BE SECURED BY APPROVED METHODS (I.E. PEG AND TWINE, MULCH NETTING, OR LIQUID MULCH BINDING).
- PERMANENT SEEDING AND MULCHING: TOPSOIL UNIFORM APPLICATION TO A DEPTH OF 4" (UNSETTLED) LIME-90 LBS./1,000 SF GROUND LIMESTONE; FERTILIZER-11 LBS./1,000 SF: 10-20-10 OR EQUIVALENT WORKED INTO SOIL A MINIMUM OF 4". SEED - TURF TYPE TALL FESCUE (BLEND OF 3 CULTIVARS) 150 LBS./ACRE (3.5 LBS./1.000 SF) OR OTHER APPROVED SEEDS MULCH- SALT HAY OR SMALL GRAIN STRAW AT A RATE OF 70 TO 90 LBS./1,000 SF TO BE APPLIED ACCORDING TO THE NJ STANDARDS. MULCH SHALL BE SECURED BY APPROVED METHODS (I.E. PEG AND TWINE, MULCH NETTING, OR LIQUID MULCH BINDING). GRASS AREAS - AREAS DESIGNATED AS GRASS, OR DISTURBED AREAS NOT DESIGNATED FOR ANY OTHER PLANTINGS SHALL BE PERMANENTLY STABALIZED BY SEEDING WITH THE BUFFALO SUPREME SEED MIXTURE AT THE RATE OF 3 LBS/1,000 S.F. SOIL PREPARATION, SEEDING, MULCHING AND MAINTENANCE SHALL BE DONE AS INDICATED IN THE PLANTING NOTES AND THE DETAILS HEREIN.

IMIT OF DISTURBANCE:

N 39°30'00" W


PROPOSED |


SILT FENCE

22' X 50' PROPOSED

TRANSFORMER ROOM 17'-0" x 25'-0"

SOIL CHARACTERISTICS CHART URBAN LAND, EOLIAN SUBSTRATUM (URDUNB) TYPE OF SOIL PERCENT OF SITE COVERAGE 100% HYDROLOGIC SOIL GROUP

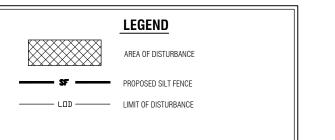

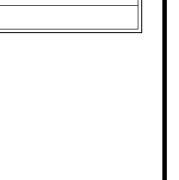






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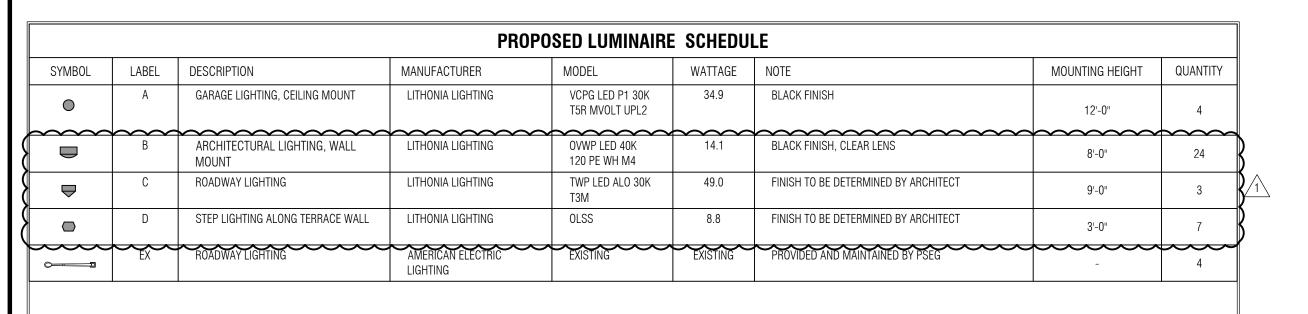
NEW 5-STORY 127 DELAWAR JERSEY CITY, I

CONSULTANTS:



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 \triangleleft **LCM OP 127 DELAWARE LLC** 215 BERKLEY AVE. BELLE MEAD, NJ 08502 PLANNING BOARD SUBMISSION REVISIONS: PROPOSED TREE PROTECTION SILT FENCE JCMUA UPDATES IAE PROJECT NO: **SHEET TITLE:** SOIL EROSION & SEDIMENT CONTROL SITE PLAN **SOIL EROSION & SEDIMENT** SHEET: **CONTROL SITE PLAN** C-1.30

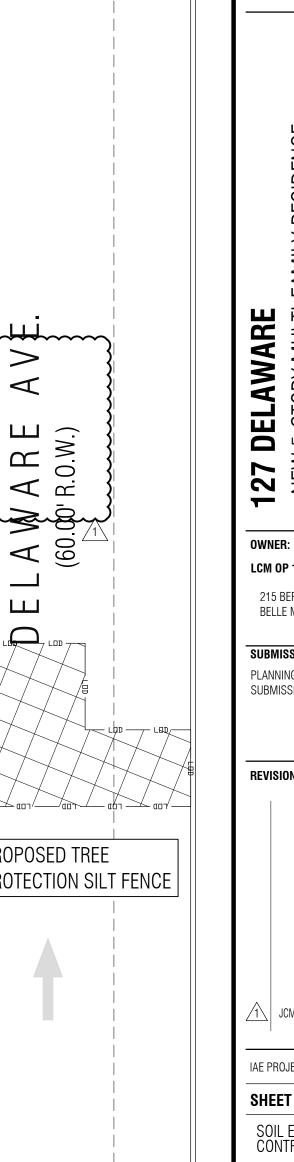

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CEILING MOUNTED LIGHTING	WALL MOUNTED LIGHTING	WALL MOUNTED LIGHTING	WALL MOUNTED STEP LIGHT	ROADWAY LIGHTING FIXTURE
FIXTURE TYPE 'A'	FIXTURE TYPE 'B'	FIXTURE TYPE 'C'	FIXTURE TYPE 'D'	TYPE 'EX'

GENERAL LIGHTING NOTES

PARKING LOT

(ZONING) 345-69 PROPERTY LINE

(ZONING) 345-69 SIDFWAI K

(ZONING) 345-69

- THE LIGHTING LEVELS DEPICTED WITHIN THE PLAN SET ARE CALCULATED UTILIZING DATA OBTAINED FROM THE LISTED MANUFACTURER. ACTUAL ILLUMINATION LEVELS AND PERFORMANCE OF ANY PROPOSED LIGHTING FIXTURE MAY VARY DUE TO UNCONTROLLABLE VARIABLES SUCH ARE WEATHER, VOLTAGE SUPPLY, LAMP TOLERANCE, EQUIPMENT SERVICE LIFE AND OTHER VARIABLE FIELD CONDITIONS.
- WHERE APPLICABLE. THE EXISTING LIGHT LEVELS DEPICTED WITHIN THE PLAN SET SHALL BE CONSIDERED APPROXIMATE. THE EXISTING LIGHT
- LEVELS ARE BASED ON FIELD OBSERVATIONS AND THE MANUFACTURER'S DATA OF THE ASSUMED OR MOST SIMILAR LIGHTING FIXTURE MODEL. UNLESS NOTED ELSEWHERE WITHIN THIS PLAN SET, THE LIGHT LOSS FACTORS USED IN THE LIGHTING ANALYSIS ARE AS FOLLOWS:
- LIGHT EMITTING DIODES (LED): 0.90

LIGHTING LEVEL

MIN (FC)

1.0

MAX (FC)

2.0

0.5

- HIGH PRESSURE SODIUM: 0.72 METAL HALIDE:
- THE CONTRACTOR SHALL NOTIFY INGLESE ARCHITECTURE + ENGINEERING IN WRITING, PRIOR TO THE START OF CONSTRUCTION, OF ANY
- PROPOSED LIGHTING LOCATIONS THAT CONFLICT WITH EXISTING/PROPOSED DRAINAGE, UTILITY, OR OTHER IMPROVEMENTS.
- THE CONTRACTOR IS RESPONSIBLE TO PREPARE A WIRING PLAN AND PROVIDE ELECTRIC SERVICE TO ALL PROPOSED LIGHTING FIXTURES. THE CONTRACTOR IS REQUIRED TO PREPARE AN AS-BUILT PLAN OF WIRING AND PROVIDE COPIES TO THE OWNER AND INGLESE ARCHITECTURE +

PROPOSED PLANTING SCHEDULE						
SYMBOL	QUANTITY	COMMON NAME	BOTANICAL NAME	PLANTING SIZE	MATURE SIZE	REMARKS
£3. 20"	1	EXISTING STREET TREE		20" CALIPER EXISTING		
AL	2	AMERICAN LINDEN	TILIA AMERICANA	12' H. 3 1/2" CAL	MATURE HT.: UP TO 40 FT.	TREES TO BE BRANCHED AT 7FT TYPICAL.

GENERAL LANDSCAPING NOTES

- ALL MATERIALS TO BE TYPE AND SIZE AS LISTED UNLESS OTHERWISE APPROVED.
- TREES TO BE IN ACCORDANCE WITH THE AMERICAN ASSOCIATION OF NURSERYMEN (AAN) STANDARDS REGARDING SIZE AND QUALITY.
- CALIPER MEASURED 1 FT. ABOVE TRUNK CROWN. PLANTS ARE TO BE PLANTED UPRIGHT IN A DIRECTION SO AS TO PROVIDE BEST APPEARANCE IN RELATIONSHIP TO ADJACENT AREAS.
- TREES SHALL BE SUPPORTED IMMEDIATELY AFTER PLANTING (REFER TO DETAILS).
- TREE PITS, PLANT BEDS, AND GROUND COVER AREAS SHALL BE MULCHED WITH A MINIMUM DEPTH OF 3" (AFTER SETTLEMENT) OF SHREDDED HARDWOOD MULCH. PROVIDE NEW OR AMENDED TOPSOIL BACK FILL FOR ALL NEWLY PLANTED MATERIAL ORGANIC MATTER = 5% MINIMUM, PH RANGE BETWEEN 5.0-6.5 INCLUSIVE, FREE OF STONES 1" OR GREATER AND


PLANTING PITS ARE TO BE PREPARED TO A MINIMUM DEPTH OF 12" AND PITS ARE TO HAVE A MINIMUM OF 9" OF GOOD TOPSOIL. LAWN AREAS ARE TO HAVE A MINIMUM OF 6" (4" FOR SOD) OF TOPSOIL.

- FREE OF ALL DEBRIS AND EXTRANEOUS MATERIALS.
- CHEMICAL FERTILIZERS TO BE DERIVED FROM ORGANIC SOURCES AND APPLIED IN ACCORDANCE WITH MANUFACTURERS SPECIFICATIONS.
- ALL OPEN SPACES SHALL BE SEEDED OR SADDLED AS NOTED IN PLAN.
- LANDSCAPING PLAN IS DIAGRAMMATIC, PLANT LOCATIONS MAY BE ADJUSTED FOR FIELD CONDITIONS WITH PRIOR APPROVAL.
- THE CONTRACTORS MUST VERIFY LOCATION OF ALL UNDERGROUND UTILITIES PRIOR TO ANY IMPLEMENTATION.
- ANY DISCREPANCIES AND/OR INCONSISTENCIES ARE TO BE BROUGHT TO THE CITY FOR REVIEW AND RESOLUTION. ALL LANDSCAPING NOT SURVIVING FOR A PERIOD OF ONE YEAR SHALL BE REPLACED WITH THE SAME OR EQUIVALENT SIZE SPECIFIES.
- STREET TREES SHALL BE BRANCHED AT 7 FT. ALL LANDSCAPE SHALL BE MAINTAINED BY OWNER.
- TREES SHALL BE PLANTED AT A MIN. INITIAL SIZE OF 3" CALIPER BALLED AND BURLAPPED. WHEREVER POSSIBLE, THE APPLICANT SHALL PROVIDE FOR ADDITIONAL LANDSCAPING OPPORTUNITIES IN THE PROJECT, AS WELL AS ENHANCE THE EXISTING LANDSCAPING SPACE.
- FINAL PLANTERS SHALL BE APPROVED BY PLANNING AND ENGINEERING STAFF.
- ALL PAVING AND COMPACTED SUB-SURFACE WILL BE REMOVED FROM PLANTING AREAS AND REPLACED WITH SOIL. ALL PLANTING SHALL HAVE A TWO (2) YEAR MAINTENANCE GUARANTEE FOR ALL PROPOSED PLANT MATERIAL.
- UNLESS OTHERWISE NOTED IN PLAN, CONTRACTOR MUST RESTORE ALL DISTURBED GRASS AND LANDSCAPING AREAS, TO MEET THE EXISTING CONDITIONS. RESTORATION WILL BE DONE WITH A
- MINIMUM 4" LAYER OF TOPSOIL AND SEED, AND A MINIMUM OF 3" MULCH LAYERS WHEN RESTORING MULCH AREAS. UNLESS OTHERWISE NOTED IN PLAN, CONTRACTOR MUST MAINTAIN A VERTICAL (3:1 SLOPE) DURING LANDSCAPE RESTORATION
- PRIOR TO CONSTRUCTION CONTRACTOR MUST LOCATE ALL EXISTING SPRINKLER HEADS IN LANDSCAPING AREAS. WITHIN AREAS DISTURBED THE CONTRACTOR SHALL, WITH THE OWNER'S DIRECTIVE RELOCATE SPRINKLER HEADS AND LINES.
- ALL DISTURBED LANDSCAPE AREAS MUST BE GRADED TO MEET FLUSH WITH WALKWAY AND TOP OF CURB ELEVATIONS UNLESS OTHERWISE NOTED IN DRAWINGS. ANY DEVIATIONS OR CHANGES MUST BE COMMUNICATED TO ENGINEER PRIOR TO IMPLEMENTATION.

PROTECTION OF EXISTING VEGETATION NOTES:

. BEFORE COMMENCING WORK, ALL EXISTING VEGETATION WHICH COULD BE IMPACTED AS A RESULT OF THE PROPOSED CONSTRUCTION ACTIVITIES MUST BE PROTECTED FROM DAMAGE BY THE INSTALLATION OF TREE PROTECTION FENCING. FENCING SHALL BE LOCATED AT THE DRIP-LINE OR LIMIT OF DISTURBANCE AS DEPICTED WITHIN THE APPROVED OR FINAL PLAN SET, ESTABLISHING THE TREE PROTECTION ZONE. FENCE INSTALLATION SHALL BE IN ACCORDANCE WITH THE PROVIDED "TREE PROTECTION FENCE DETAIL." NO WORK MAY BEGIN UNTIL THIS REQUIREMENT IS FULFILLED. THE FENCING SHALL BE INSPECTED REGULARLY BY THE LANDSCAPE CONTRACTOR AND MAINTAINED UNTIL ALL CONSTRUCTION ACTIVITIES HAVE BEEN COMPLETED.

- P. IN ORDER TO AVOID DAMAGE TO ROOTS, BARK OR LOWER BRANCHES, NO VEHICLE, EQUIPMENT, DEBRIS, OR OTHER MATERIALS SHALL BE DRIVEN, PARKED OR PLACED WITHIN THE TREE PROTECTION ZONE. ALL ON-SITE CONTRACTORS SHALL USE ANY AND ALL PRECAUTIONARY MEASURES WHEN PERFORMING WORK AROUND TREES, WALKS, PAVEMENTS, UTILITIES, AND ANY OTHER FEATURES EITHER EXISTING OR PREVIOUSLY INSTALLED UNDER THIS CONTRACT.
- B. IN RARE INSTANCES WHERE EXCAVATING, FILL, OR GRADING IS REQUIRED WITHIN THE DRIP-LINE OF TREES TO REMAIN, THE WORK SHALL BE PERFORMED AS FOLLOWS: TRENCHING: WHEN TRENCHING OCCURS AROUND TREES TO REMAIN. THE TREE ROOTS SHALL NOT BE CUT. BUT THE TRENCH SHALL BE TUNNELED UNDER OR AROUND THE ROOTS BY CAREFUL HAND.
- DIGGING AND WITHOUT INJURY TO THE ROOTS. NO ROOTS, LIMBS, OR WOODS ARE TO HAVE ANY PAINT OR MATERIAL APPLIED TO ANY SURFACE. • RAISING GRADES: WHEN THE GRADE AT AN EXISTING TREE IS BELOW THE NEW FINISHED GRADE, AND FILL NOT EXCEEDING 6 INCHES (6") IS REQUIRED, CLEAN, WASHED GRAVEL FROM ONE TO TWO INCHES (1" - 2") IN SIZE SHALL BE PLACED DIRECTLY AROUND THE TREE TRUNK. THE GRAVEL SHALL EXTEND OUT FROM THE TRUNK ON ALL SIDES A MINIMUM OF 18 INCHES (18") AND FINISH APPROXIMATELY TWO INCHES (2") ABOVE THE FINISH GRADE AT TREE. INSTALL GRAVEL BEFORE ANY EARTH FILL IS PLACED. NEW EARTH FILL SHALL NOT BE LEFT IN CONTACT WITH THE TRUNK OF ANY TREE REQUIRING FILL. WHERE FILL EXCEEDING 6 INCHES (6") IS REQUIRED, A DRY LAID TREE WELL SHALL BE CONSTRUCTED. IF APPLICABLE, TREE WELL INSTALLATION SHALL BE IN
- ACCORDANCE WITH THE PROVIDED "TREE WELL DETAIL." • LOWERING GRADES: EXISTING TREES LOCATED IN AREAS WHERE THE NEW FINISHED GRADE IS TO BE LOWERED, SHALL HAVE RE-GRADING WORK DONE BY HAND TO THE INDICATED ELEVATION, NO GREATER THAN SIX INCHES (6"). ROOTS SHALL BE CUT CLEANLY THREE INCHES (3") BELOW FINISHED GRADE UNDER THE DIRECTION OF A LICENSED ARBORIST. WHERE CUT EXCEEDING 6 INCHES (6") IS REQUIRED, A DRY LAID RETAINING WALL SHALL BE CONSTRUCTED. IF APPLICABLE, THE RETAINING WALL INSTALLATION SHALL BE IN ACCORDANCE WITH THE PROVIDED "TREE RETAINING WALL

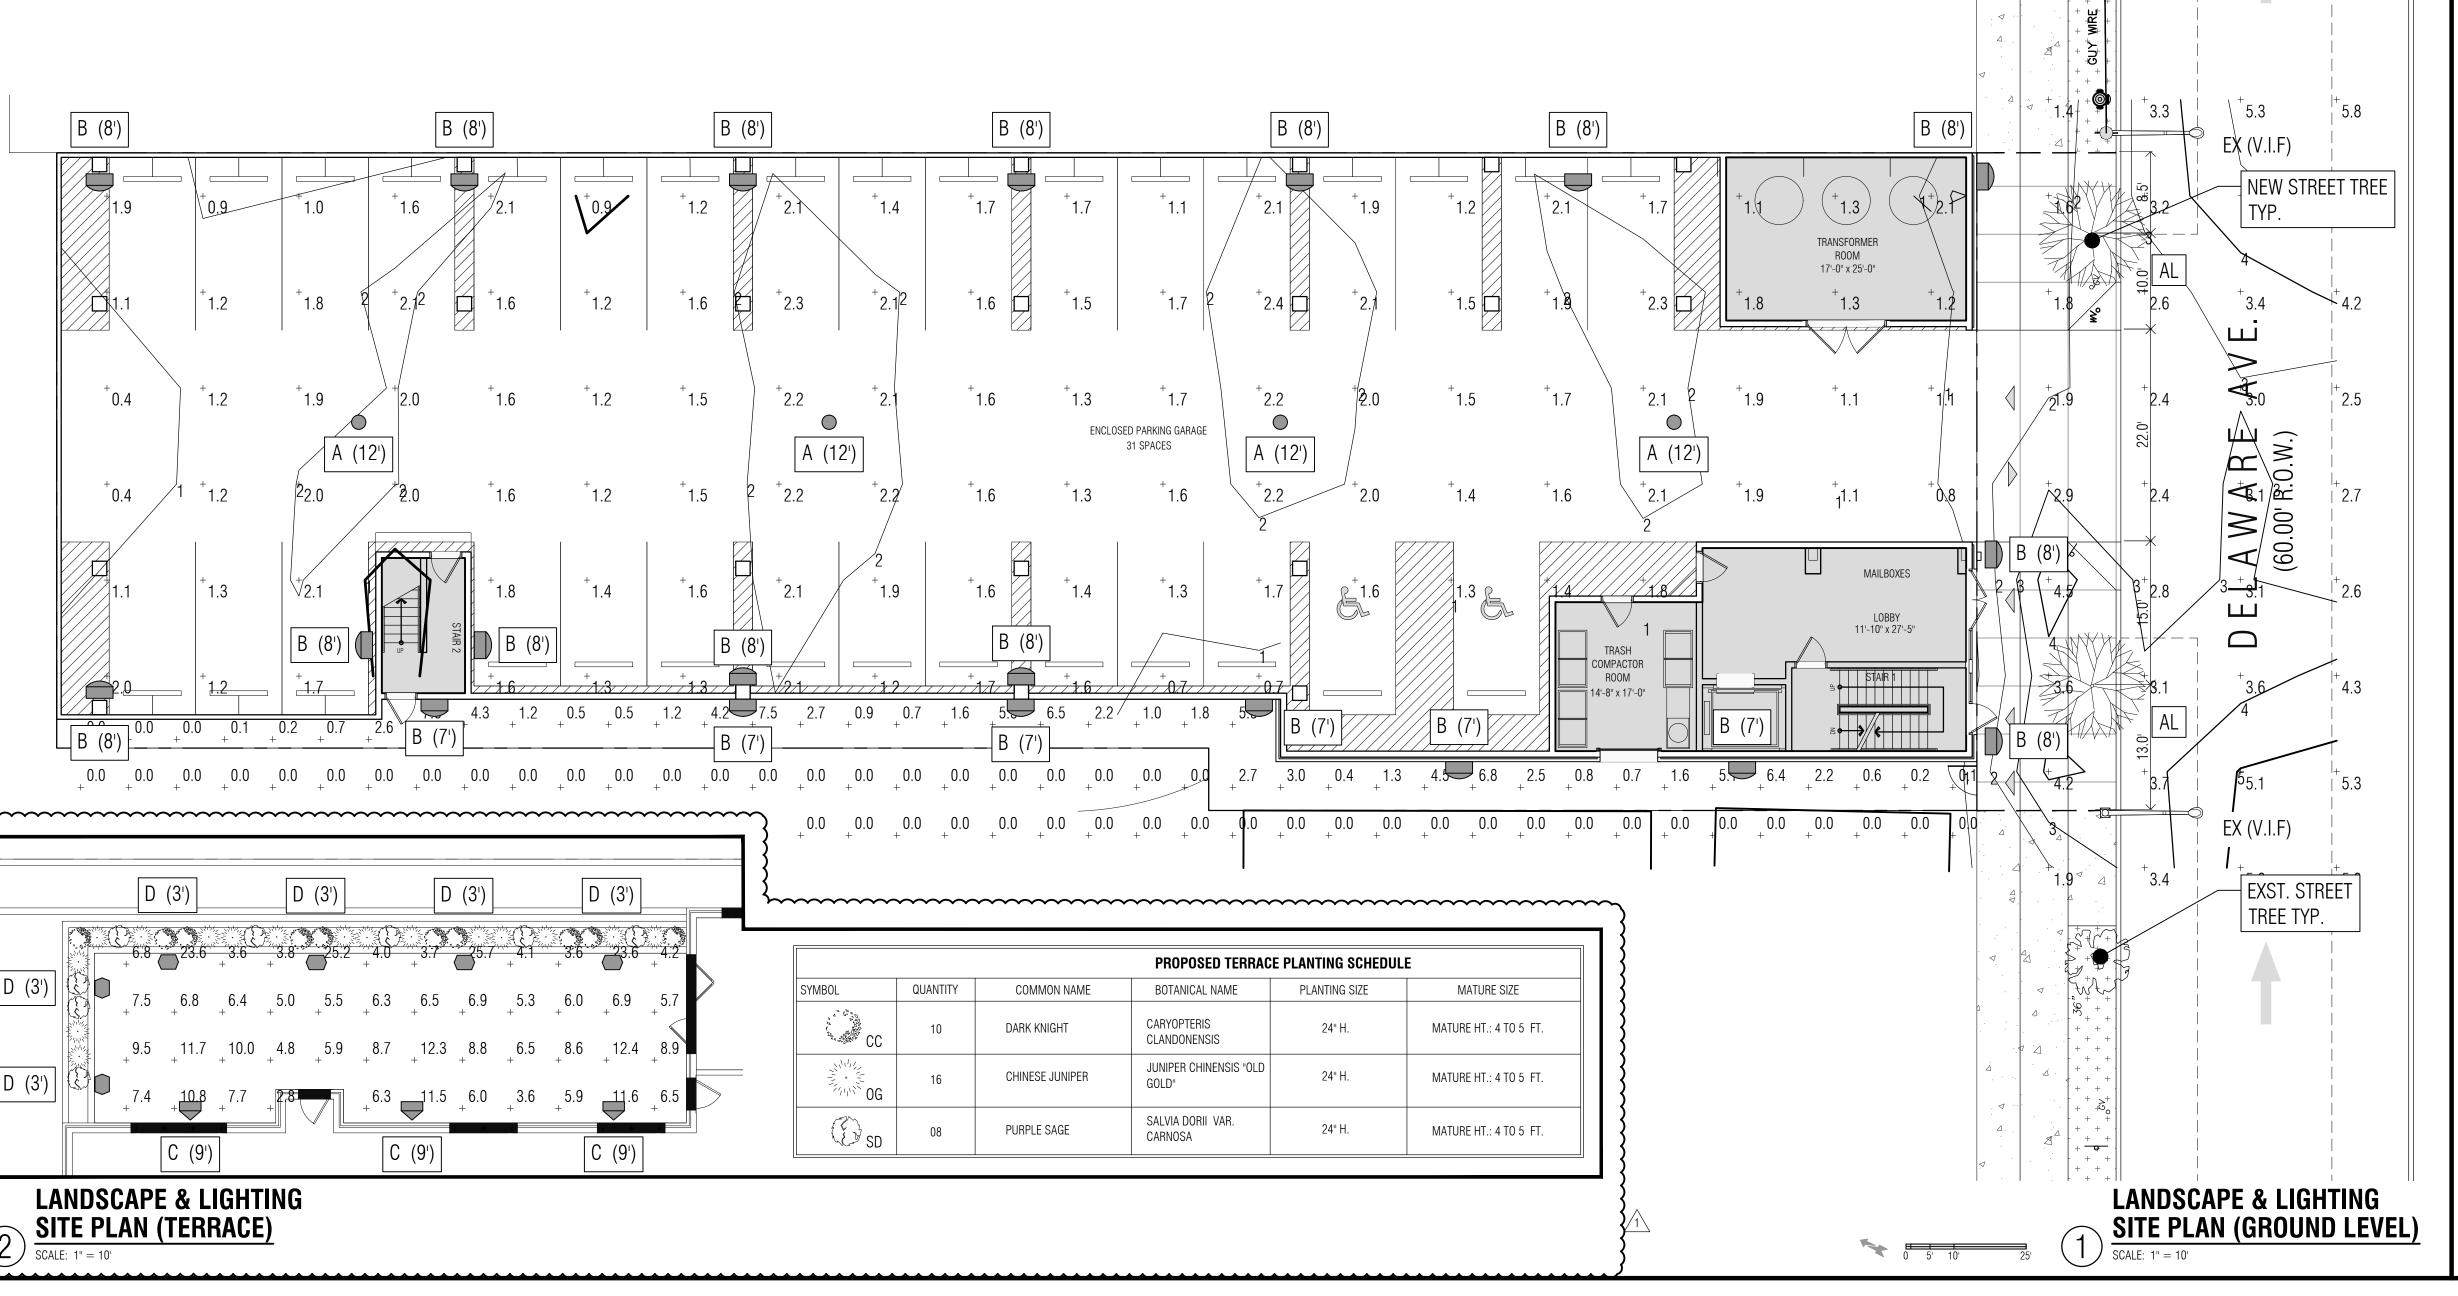

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CONSULTANTS:

NEW 5-STORY MULTI-FA 127 DELAWARE AVENUE JERSEY CITY, NJ 07306 127 DELAWARE

OWNER: **LCM OP 127 DELAWARE LLC**

BELLE MEAD, NJ 08502 PLANNING BOARD

REVISIONS:

SUBMISSION

JCMUA UPDATES

IAE PROJECT NO: **SHEET TITLE:**

LANDSCAPE AND LIGHTING SITE PLAN

SHEET: C-1.40

PART 1 - GENERAL

THE INTENT OF THIS DOCUMENT IS TO SPECIFY THE MINIMUM CRITERIA FOR THE DESIGN, SUPPLY, INSTALLATION, AND COMMISSIONING OF A PEDESTRIAN ALERT SAFETY SYSTEM USED TO NOTIFY PEDESTRIANS AND STREET TRAFFIC OF A VEHICLE EXITING A PARKING FACILITY OR BLIND CORNER.

1.01 SUMMARY

A CAR COMING PEDESTRIAN ALERT SAFETY SYSTEM IS DESIGNED TO PROVIDE A CLEAR VISUAL AND AUDIBLE VOICE ALERT TO PEDESTRIAN AND STREET TRAFFIC WHEN A VEHICLE IS EXITING A PARKING FACILITY OR BLIND CORNER. THE ALERT SYSTEM SHALL BE SELF-CONTAINED WITH ALL CONTROLS OF THE SYSTEM CONTAINED WITHIN THE ENCLOSURE OF THE SIGN. THE ALERT SYSTEM SHALL BE DESIGNED WITH AESTHETICS OF THE ARCHITECTURE OF THE FACILITY IN MIND, AND NOT TO DETRACT FROM

1.02 SYSTEM DESCRIPTION

THE CAR COMING PEDESTRIAN ALERT SAFETY SYSTEM ACTIVATES WHEN A VEHICLE IS DETECTED EXITING A PARKING FACILITY. WHEN ACTIVATED THE ALERT SYSTEM PROVIDES A FLASHING AMBER ALERT, BRIGHTLY BACKLIT TEXT INDICATING A "CAR COMING", AND A VOICE ALERT NOTIFYING NEARBY PEDESTRIANS.

PART 2 - PRODUCTS

2.01 MANUFACTURED UNITS

MODEL NUMBER/DESCRIPTIONS TABLE

PEDESTRIAN ALERT SYSTEM

"PASSCC" CAR COMING, PEDESTRIAN ALERT SAFETY SYSTEM WITH INTEGRATED PASS CONTROLLER BOARD. MFG PASS

2.02 TECHNICAL OVERVIEW

THE CAR COMING PEDESTRIAN ALERT SAFETY SYSTEM ACTIVATES WHEN A VEHICLE IS DETECTED EXITING A PARKING FACILITY. WHEN ACTIVATED THE ALERT SYSTEM PROVIDES A FLASHING AMBER ALERT, BRIGHTLY BACKLIT TEXT INDICATING A "CAR COMING", AND A VOICE ALERT NOTIFYING NEARBY PEDESTRIANS.

SYSTEM ACTIVATION TRIGGERS

THE SYSTEM CAN BE ACTIVATED BY ANY DETECTION DEVICE THAT HAS A NORMALLY OPEN OUTPUT CONTACT THAT CLOSES UPON DETECTION OF THE VEHICLE. MULTIPLE DEVICES, SUCH AS PARKING BARRIERS OR VEHICLE LOOP DETECTORS, CONNECTED IN PARALLEL CAN BE LINKED TOGETHER TO PROVIDE ACTIVATION OF THE SIGN IF ANY DEVICE DETECTS A VEHICLE MOVEMENT.

TYPICAL SYSTEM ACTIVATION TRIGGERS

- THE FOLLOWING IS A LIST OF TYPICAL SYSTEM ACTIVATION TRIGGERS
- PARKING BARRIER "GATE OPEN" OUTPUT
- PARKING BARRIER SAFETY LOOP ACTIVATED OUTPUT
- VEHICLE LOOP DETECTOR
- VEHICLE MOTION DETECTOR
- ROLL-UP DOOR "OPEN" CONTACT SLIDING/SWING GATE "OPEN" CONTACT
- BEAM DETECTOR ACTIVATION OUTPUT

CASH DRAWER OPEN/CLOSE CONTACT

THE SIGN HAS TWO VISUAL ALERTS TO DRAW THE ATTENTION OF PEDESTRIANS AND STREET TRAFFIC WARNING OF A VEHICLE EXITING A FACILITY.

FLASHING AMBER LEDS - A CONSPICUOUS VISUAL ALERT THAT PROVIDES A WARNING TO DRIVERS AND PEDESTRIANS BACKLIT TEXT MESSAGE - THE LED BACKLIT TEXT PROVIDES A CLEAR MESSAGE WARNING OF A CAR COMING OUT OF THE FACILITY. THE BACKLIT TEXT MESSAGE CAN OPTIONALLY FLASH SYNCHRONIZED WITH THE FLASHING AMBER LED BY MOVING THE WIRES FROM OUTPUT 1 TO OUTPUT 2

THE AUDIBLE ALERT IS DESIGNED TO PROVIDE EITHER A CLEAR VOICE MESSAGE OR SOUND FILE ALERTING NEARBY PEDESTRIANS WHO ARE DISTRACTED FROM THE VISUAL ALERTS, THIS IS TYPICAL OF PEDESTRIANS WALKING AND USING A MOBILE DEVICE. THE AUDIBLE ALERT HAS THE ABILITY TO PLAY ANY MP3 FILE. THE FILE IS STORED ON AN ONBOARD REMOVABLE MICRO SD CARD THAT PROVIDES TECHNICIANS AND END USERS AN EASY PATH TO MODIFYING THE FILE. THE AUDIBLE ALERT VOLUME CAN BE CONTROLLED BY AN ONBOARD VOLUME CONTROL DIAL. THE SYSTEM HAS AN ONBOARD SOUND AMPLIFIER AND AN INTEGRATED 30WATT SPEAKER IS LOCATED AT THE BOTTOM OF THE SIGN. THE INTEGRATED CONTROLLER PROVIDES AN EXTERNAL SPEAKER OUTPUT TO ADD ADDITIONAL SPEAKERS TO THE SYSTEM IF THE AMBIENT NOISE AROUND THE SYSTEM IS LOUDER THAN 65DB.

TIMER CONTROLS

THE CONTROLLER INTEGRATED INTO THE SYSTEM CONTAINS TWO TIMERS FOR CUSTOMIZATION. ACTIVATION TIMER - THIS TIMER IS USED TO CONTROL THE DURATION OF ACTIVATION OF THE SYSTEM. THE TIMER IS CONTROLLED BY A DIAL THAT ALLOWS A 5 \sim 60 SECOND ACTIVATION OF THE SIGN.

DELAY ACTIVATION TIMER - THIS TIMER IS USED TO PROVIDE A DELAY BETWEEN TRIGGER INPUT AND ACTIVATION OF THE SYSTEM. THIS TIMER IS TYPICALLY USED WHEN A VEHICLE HAS A LONGER THAN NORMAL DISTANCE TO TRAVEL FROM THE TRIGGER TO THE

2.03 FEATURES

THE FOLLOWING FEATURES ARE REQUIRED IN THE PEDESTRIAN ALERT SAFETY SYSTEM

- VISUAL ALERT CAN BE VIEWED 180°, FROM BOTH SIDES AND FROM THE FRONT OF THE SIGN.
- A FLASHING AMBER ALERT PROVIDING A VISUAL WARNING A BRIGHTLY BACKLIT MESSAGE INDICATING THAT A "CAR COMING" OR "VEHICLE EXITING"
- ALL LIGHTING IS LED WEATHERPROOF MODULES PROVIDE 50,000+ HOURS OF SERVICE
- A CLEAR VOICE ALERT MESSAGE INDICATING THAT "ATTENTION. VEHICLE EXITING." AN INTEGRATED ADJUSTABLE PLAY ACTIVATION TIMER FROM 5-60 SECONDS
- AN INTEGRATED DELAY ACTIVATION TIMER FROM 0-30 SECONDS
- AN INTEGRATED SPEAKER PROVIDING UP TO 65DB
- AN INTEGRATED VOLUME CONTROL SOUND FILES ARE CAN EASILY BE CHANGED BY TECHNICIAN OR END USER
- SOUND FILES ARE MP3 FORMAT STORED ON A REMOVABLE MICRO SD CARD
- ALL INTEGRATED CONTROLS ARE SOLID STATE AND WITHOUT ANY MECHANICAL POINTS OF FAILURE ACTIVATION INPUT CAN ACCEPT A DRY CONTACT, 12VDC PULSE, OR 24VDC PULSE


2.04 SPECIFICATIONS

- ENCLOSURE SHAPE: PRISM
- DIMENSIONS: 40"H X 10"SIDES ENCLOSURE: 14 GAUGE STEEL
- WEIGHT: 37LBS VIEWING RANGE: >180
- FINISH POWDER COATING: HAMMERED COPPER TEXTURED ELECTRICAL POWER115VAC~120VAC OR 12VDC 2A
- TRIGGER INPUTS DRY CONTACT, 12VDC, 24VDC OPERATING TEMPERATURE-20°F TO 110°F (-29°C TO 43°C)OPERATING HUMIDITY0% TO 90%CONTROLLER POWER
- 12VDCCONTROLLER OUTPUTS1 STEADY, 1 FLASHING (1 SECOND ON/1 SECOND OFF) VOLUME CONTROLO TO 65DBTIMER CONTROLS ACTIVATION TIMER $5{\sim}60$ SECONDS, DELAY ACTIVATION TIMER $0{\sim}30$

SECONDS SOUND FILE FORMATMP3SOUND FILE STORAGE MICRO SD CARD MOUNTING WALL MOUNT BOTTOM OF UNIT 76" FROM THE GROUND

2.05 INSTALLATION

THE BOTTOM OF THE SYSTEM IS SURFACE MOUNTED ON WALLS AT APPROXIMATELY 76" FROM THE GROUND. THE SIGN SHOULD BE LOCATED NO MORE THAN 12' FROM THE EXIT OF THE FACILITY. FOR EXITS OVER 30' WIDE IT IS RECOMMENDED THAT TWO SYSTEM SIGNS BE CONNECTED IN TANDEM ON EITHER SIDE OF THE EXIT.

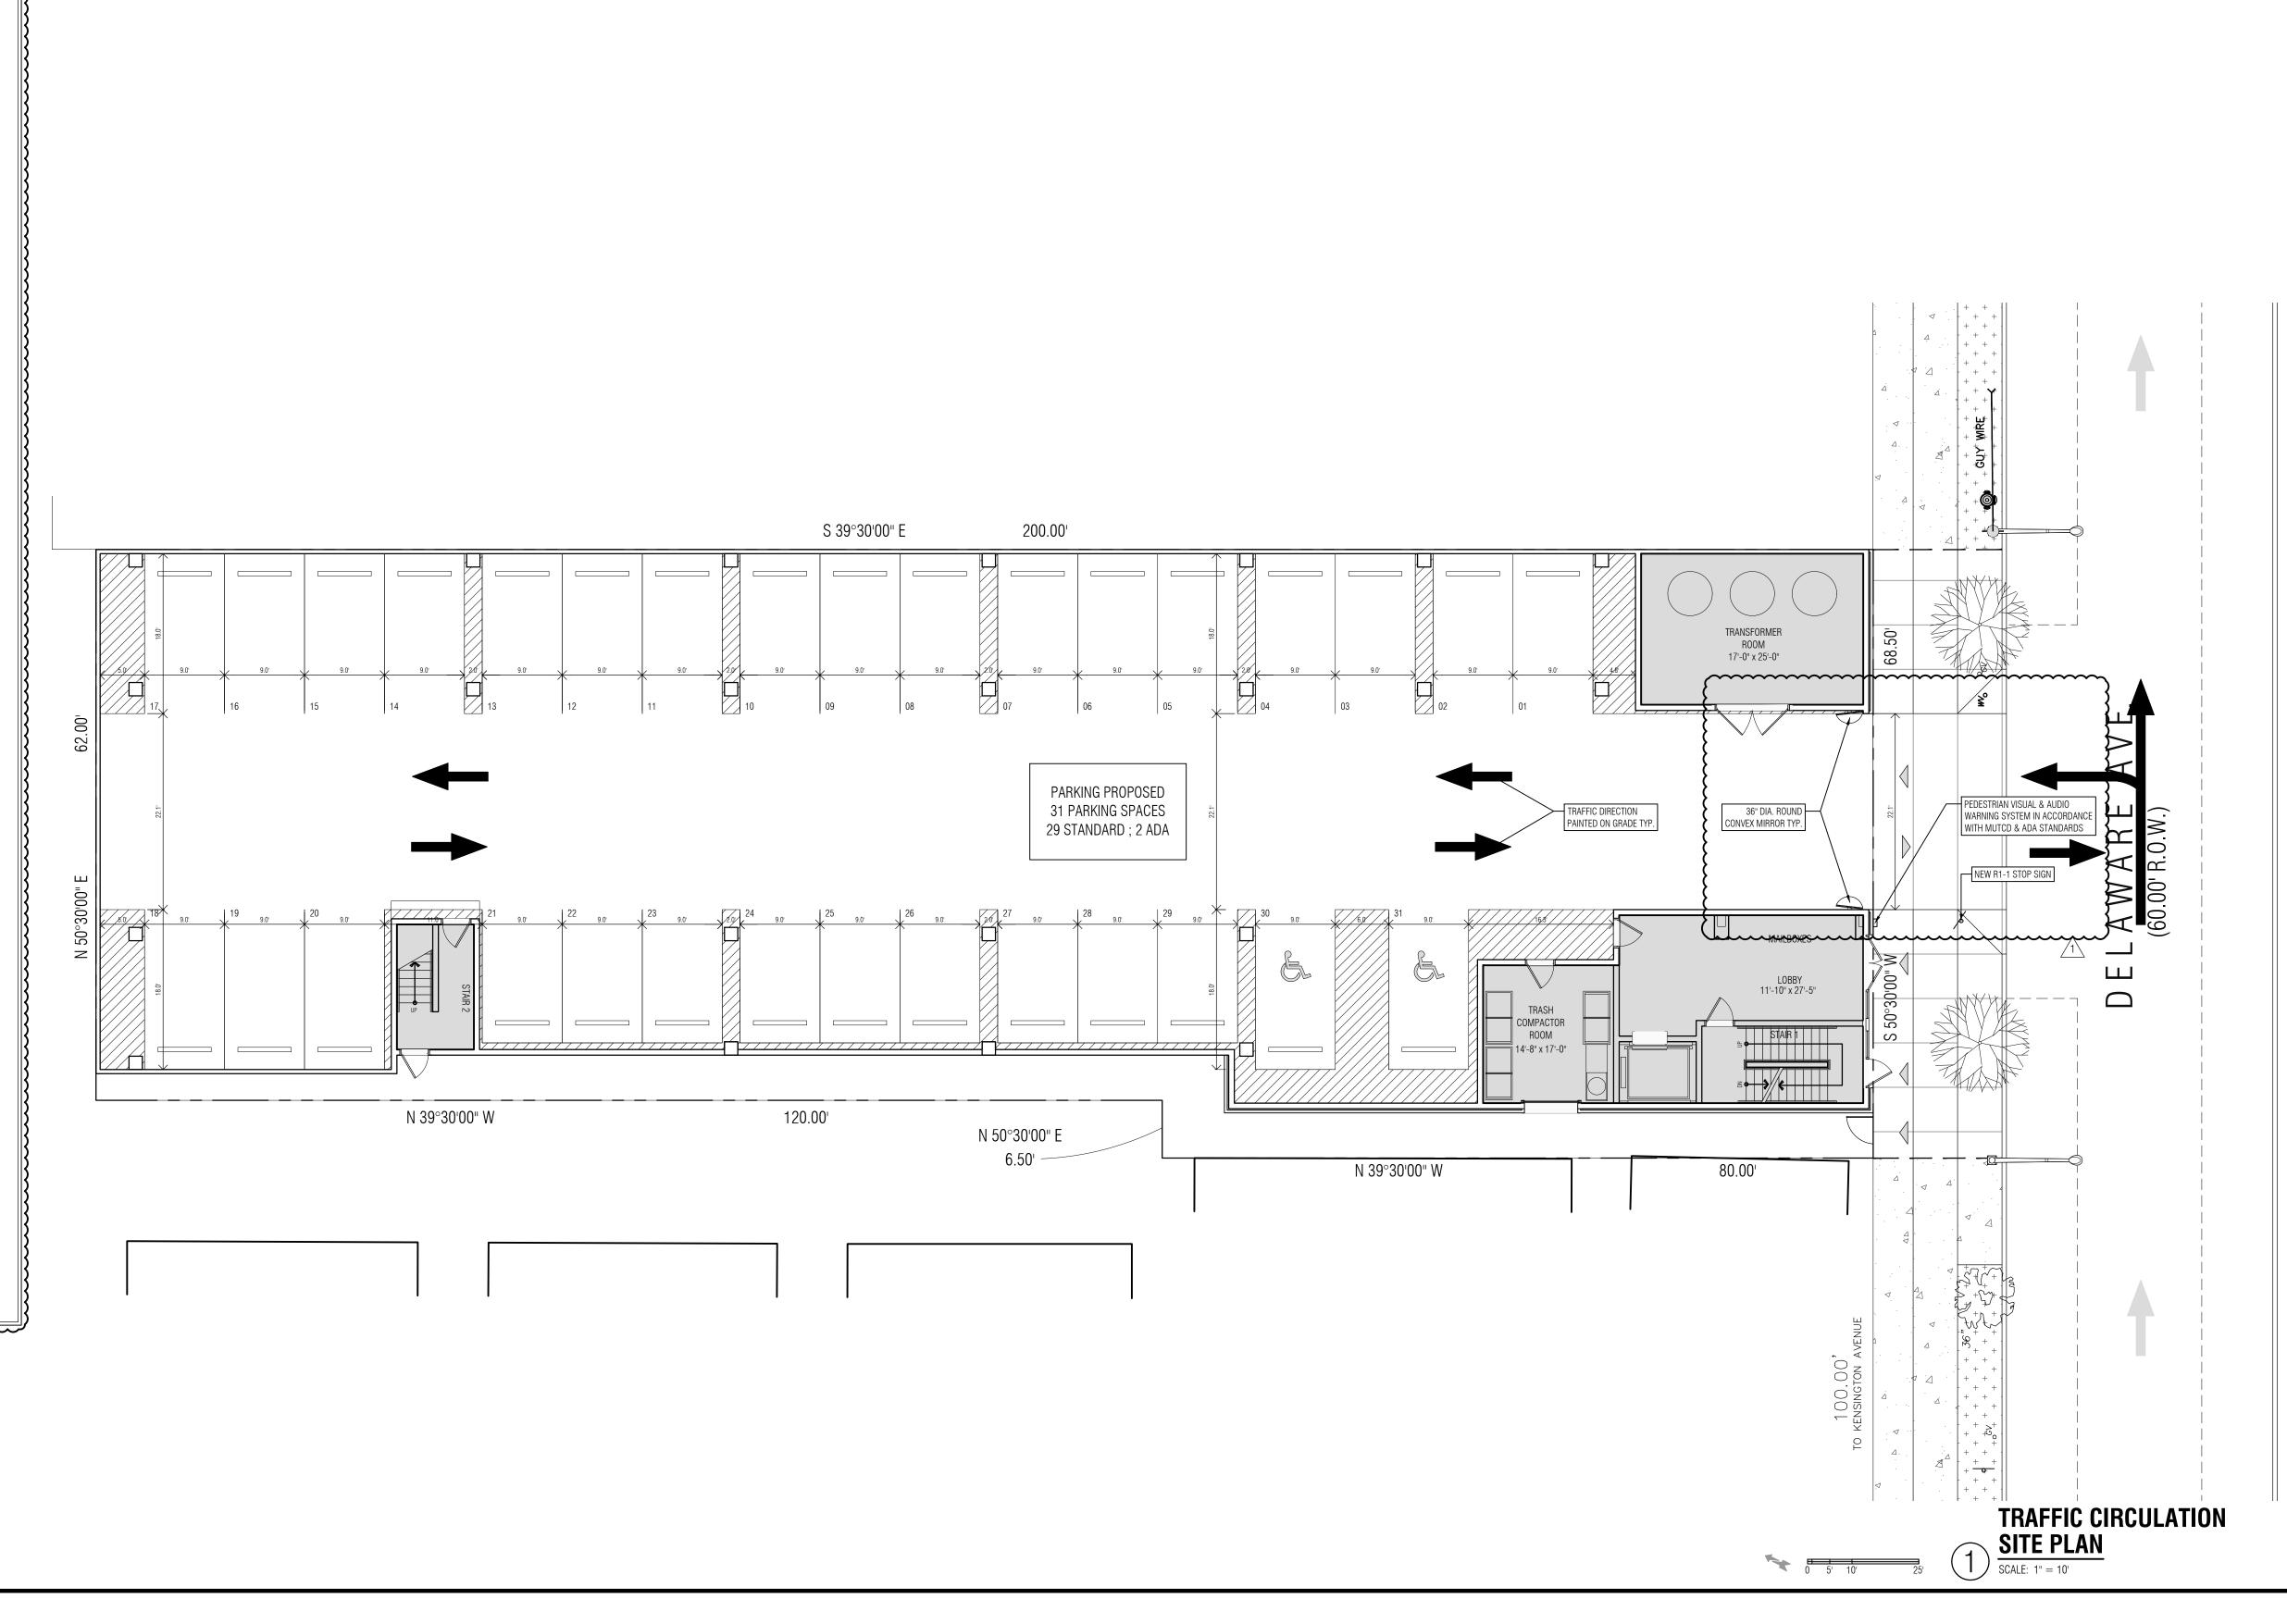



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CONSULTANTS:

27 DELAWARE

OWNER: LCM OP 127 DELAWARE LLC 215 BERKLEY AVE.

BELLE MEAD, NJ 08502

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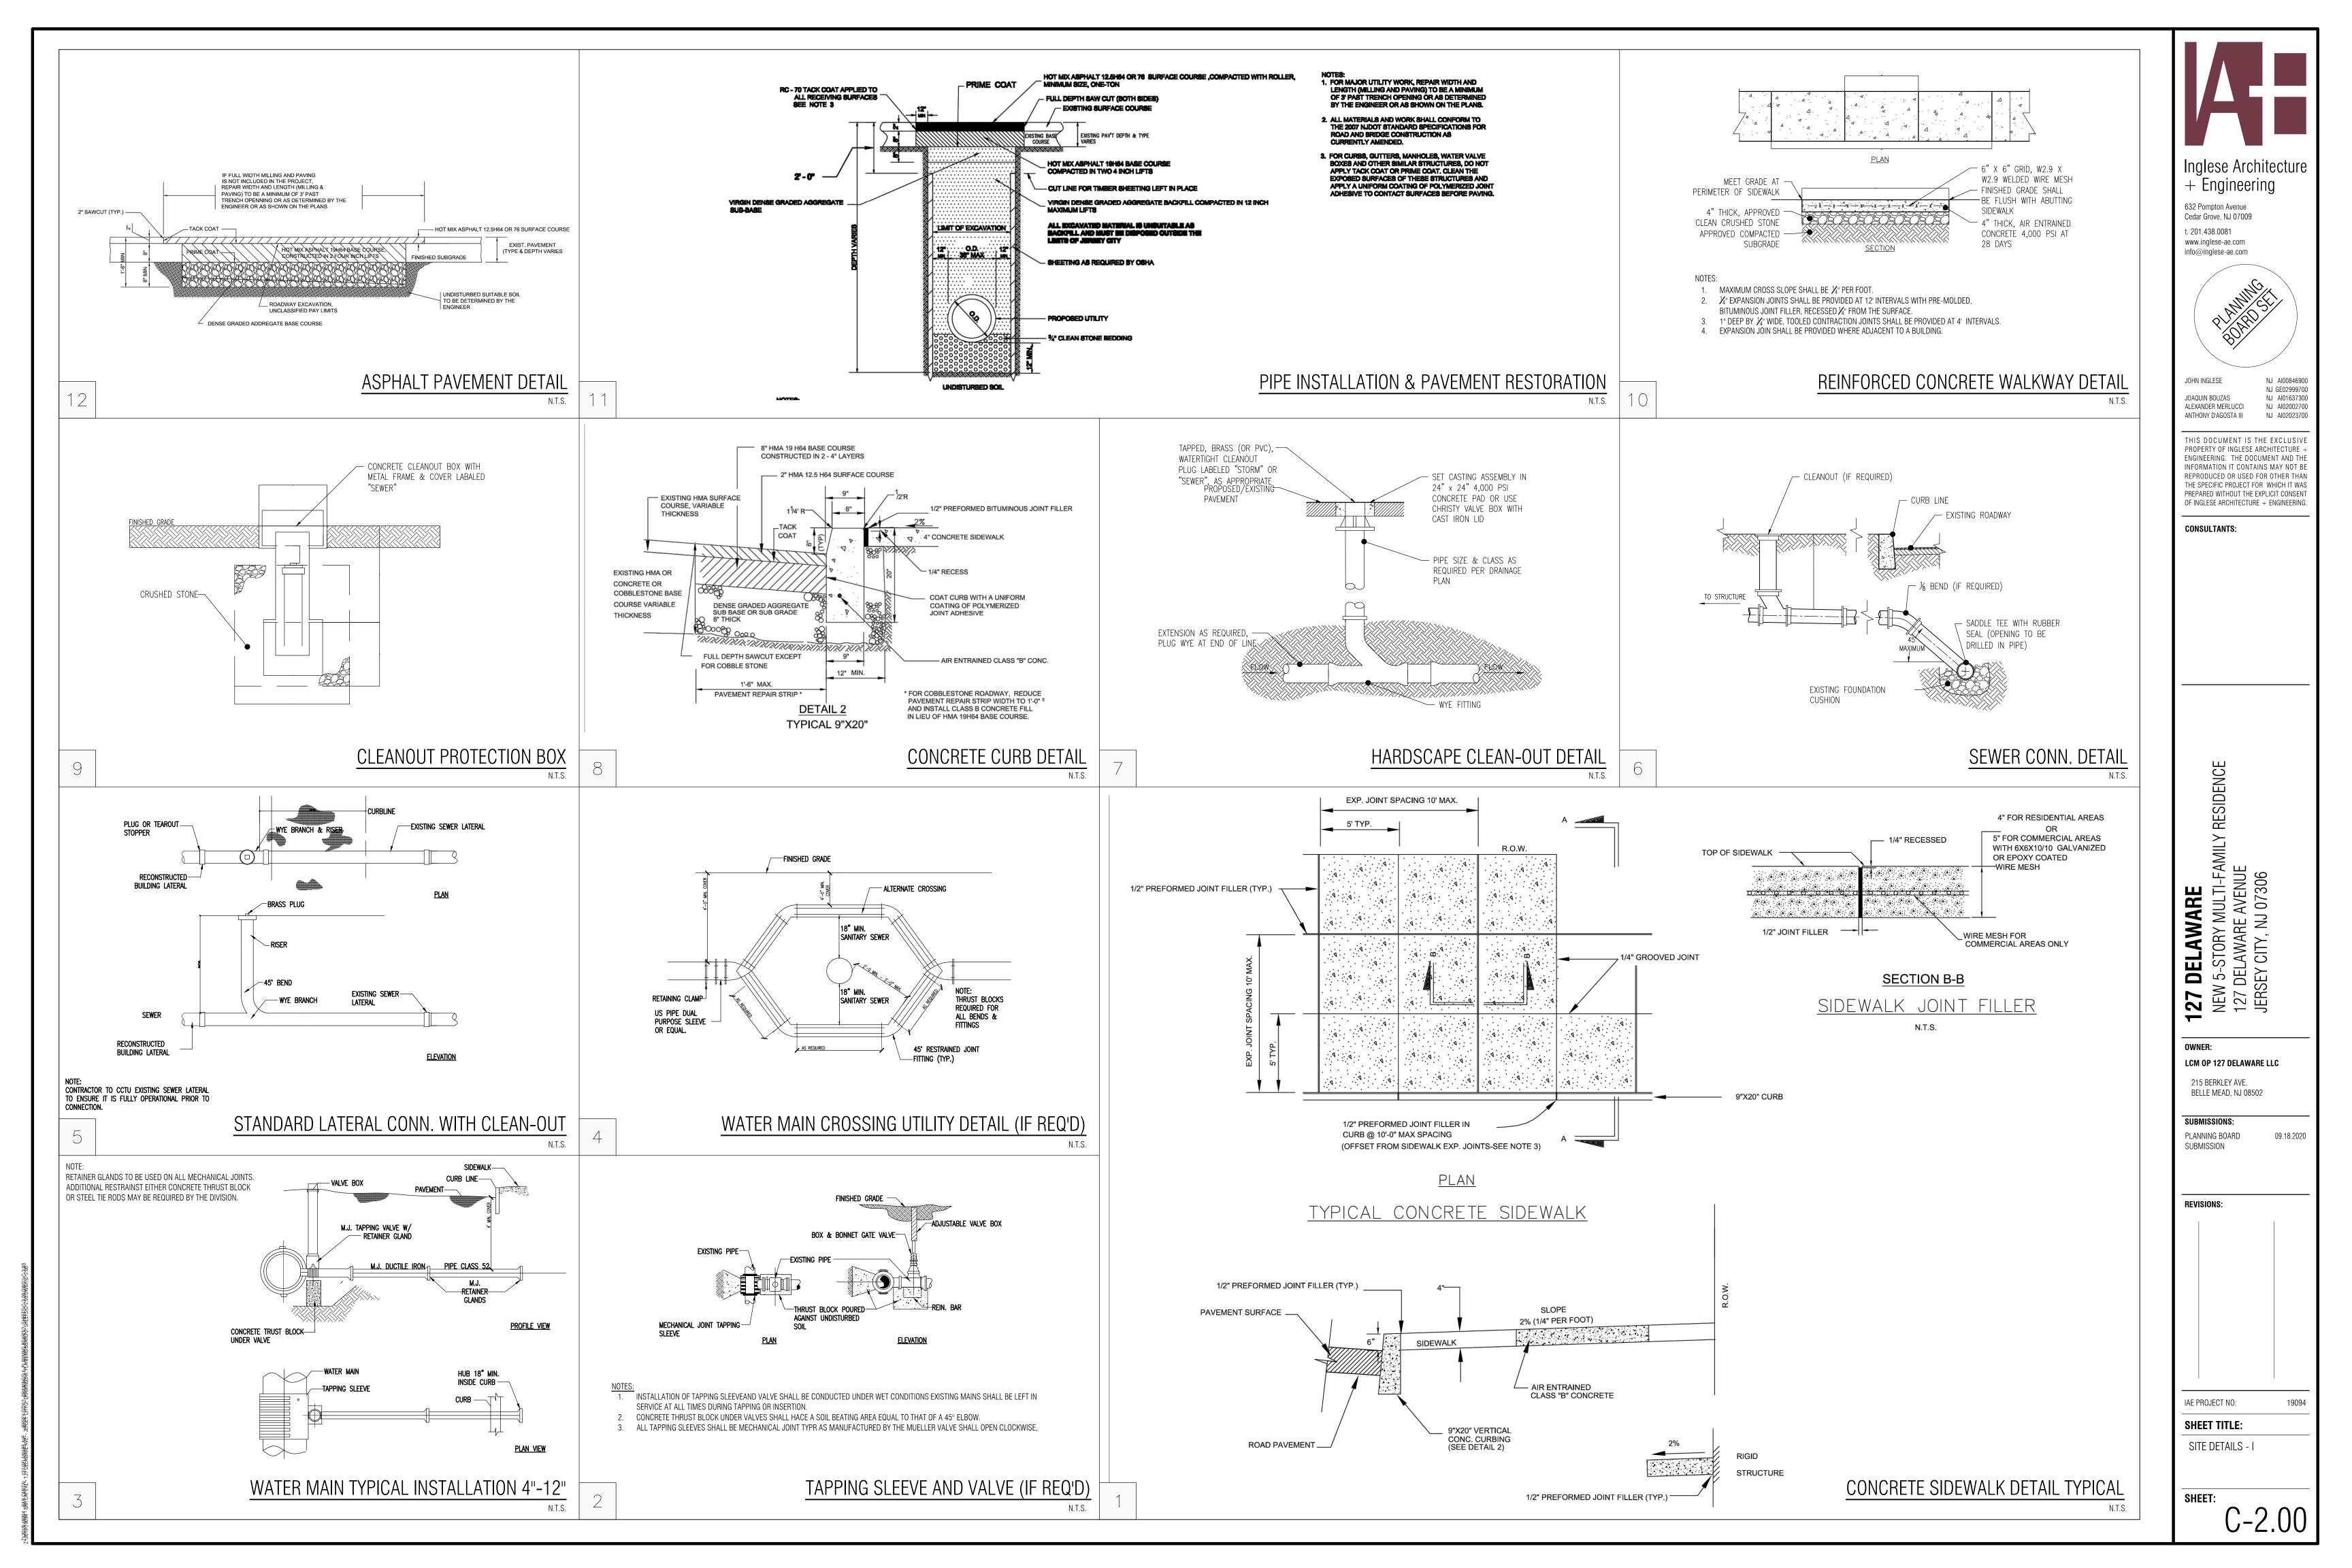
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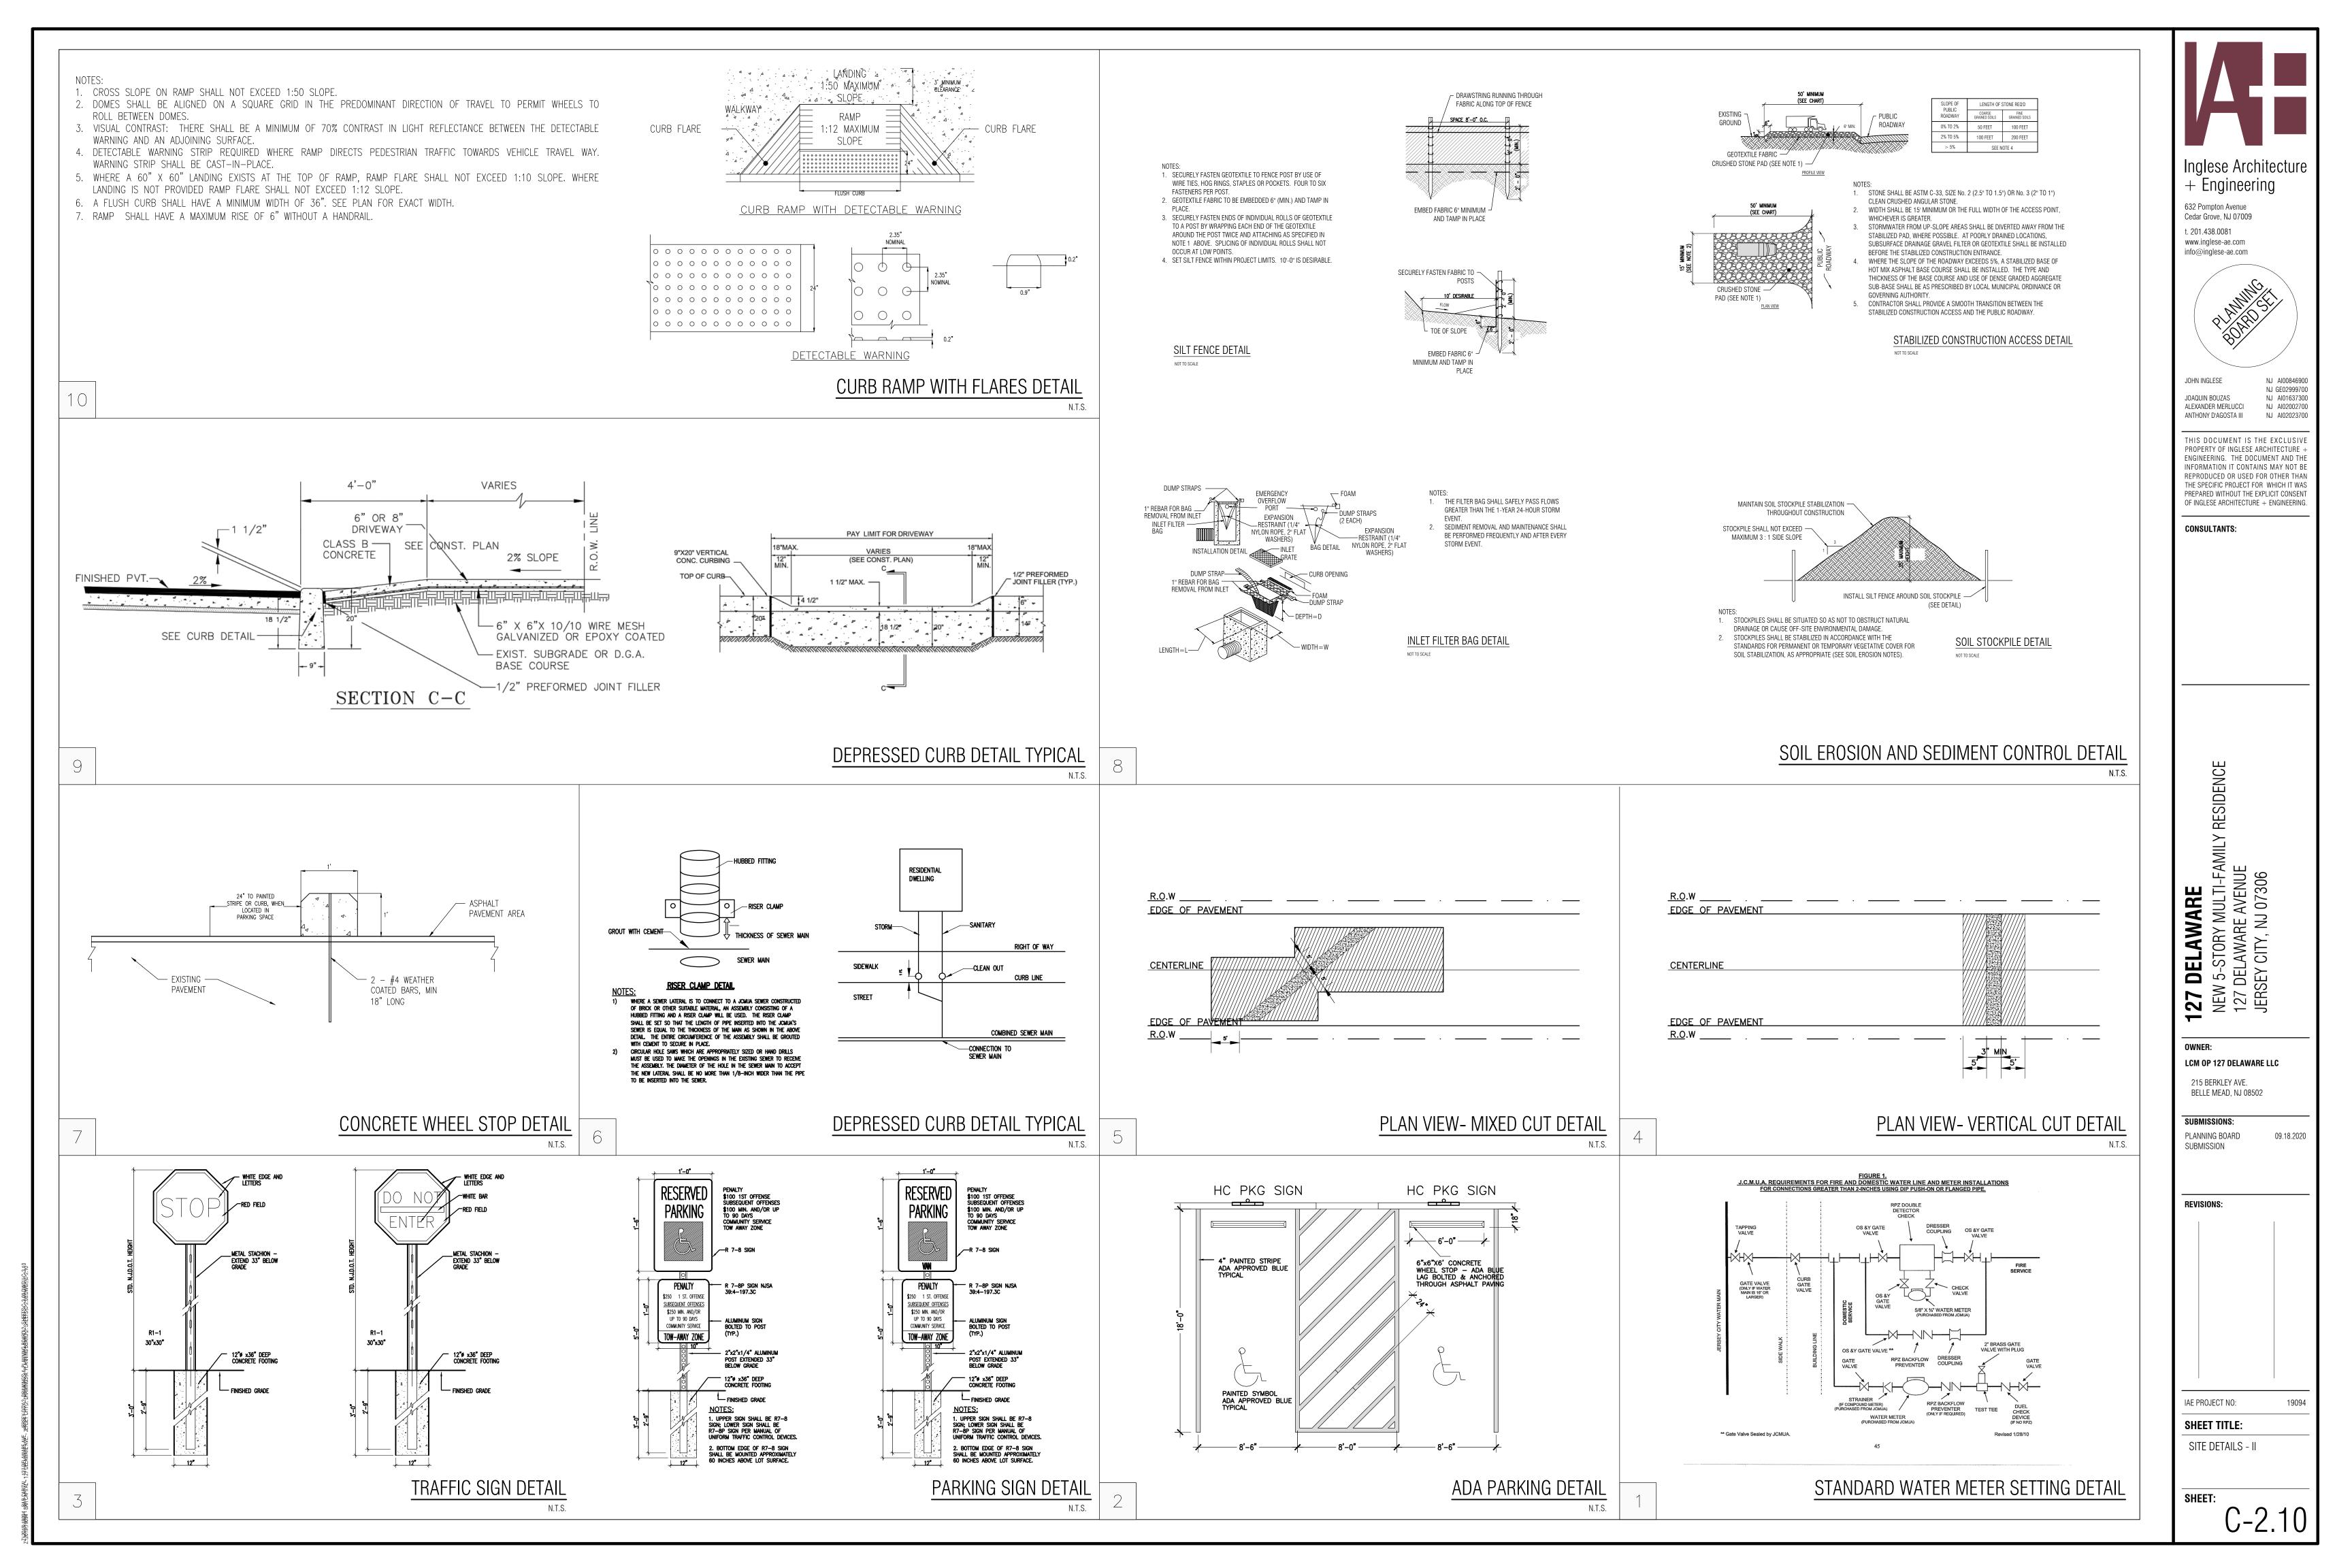
REVISIONS:

JCMUA UPDATES 01.11.2021

SHEET TITLE: TRAFFIC CIRCULATION SITE PLAN

IAE PROJECT NO:







JERSEY CITY MUNICIPAL UTILITIES AUTHORITY

STANDARD REQUIREMENTS FOR NEW SANITARY AND STORM SEWERS AND SERVICE LATERALS (Revised: December 26, 2018)

Plans and any additional information as applicable must be presented to the JCMUA for review and comments for all proposed sanitary and storm sewer connections to the JCMUA sewer system or that are proposed in Jersey City. Repairs to existing services do not require the review and approval of the JCMUA. All plans must be signed and sealed by a Professional Engineer or Registered Architect licensed to practice in New Jersey and submitted to the JCMUA's Sewer Engineering Office, 555 Route 440, Jersey City, NJ 07305 for approval.

The following technical requirements shall be addressed in preparation of site/utility plans:

- 1.) All sewer service connections 6-inches in size or smaller must be made directly to the sewer main and all connections 8-inches in size or larger must be made to a manhole. Where a connection to a manhole is required, manhole bench and channel may require modification.
- The JCMUA requires that sewer service connections to be re-used be televised to verify structural integrity and that the pipe is free from any defects or
- Each building service lateral storm and sanitary must have a T-Wye cleanout installed approximately 1-ft from the curb in the sidewalk. Cleanouts shall be 5" (min) Cast Iron Ferrule With a 4" IBTS Brass Cap. T-Wye cleanouts which enable cleaning in both directions should be installed on both the storm and sanitary lateral. See our detail titled "Standard Sanitary Cleanout" (refer to attached detail drawings).
- Proposed sewer lateral connection to JCMUA's sewer main shall be made above horizontal center line of pipe (refer to attached sewer service connection details).
- The size, material, depth, condition, direction of flow and any other relevant conditions of the existing JCMUA sewer to which you plan to connect must be field verified by developer to determine if said connection is physically possible and practical. In addition, manhole inverts and rim elevation must be shown on plans. This verification is to be included on the plans for the project.
- Circular hole saws or core drills appropriately sized to make the openings in the existing sewer to receive the laterals must be used. Jackhammers, sledgehammers and other unsuitable tools or machinery which may damage the JCMUA's sewer main are not allowed to be used to make the lateral openings. All debris must be removed and not allowed to fall into pipe.

7.) A detail of any proposed manhole or catch basin showing all dimensions in addition to rim, grate and invert elevations of the structure and all pipes connected to the structure must be shown on plans. Refer to JCMUA standard detail drawings for manholes and catch basins.

Proposed manholes constructed in the public R.O.W. on existing or proposed JCMUA sewers shall be furnished with concentric manhole covers as manufactured by Campbell Foundry Co., Pattern #4428 or equal with outside cover diameter of 31-3/4 inches and inside cover diameter of 24 inches.

The letters "JCMUA" and "SEWER" shall be cast in the outer face cover. Manhole frames shall be Campbell Foundry Co. Pattern #4428 (for 30-inch opening) or #1206 (for 41-inch opening) or equal furnished with a Pattern #4428 concentric cover as specified in the preceding paragraph.

Refer to JCMUA's standard detail for manhole frame and covers.

- 9.) Storm inlets which are connected directly to JCMUA combined sewers must be furnished with a sump and trap as per JCMUA standard details.
- 10.) The JCMUA has a combined sewer system which surcharges during wet weather periods resulting in possible sewage back-ups through plumbing fixtures (sinks, toilets, floor drains, etc.) below street level. JCMUA will not be responsible for any possible sewage back-ups and flooding in basements due to surcharging sewer conditions in wet weather events. This possibility must be addressed during the design and construction phase.
- 11.) A drop manhole connection shall be used where there is a difference in elevation of two (2) feet or greater between the invert of a sanitary or combined inlet pipe to manhole and the crown of the outlet pipe from manhole. Refer to attached JCMUA:s standard detail for drop manhole connection which must be shown on site plan if required.
- 12.) Test pits must be performed at the developer's expense during the design phase of the project to ensure that proposed sewers and sewer services may be constructed as proposed without conflicting with other underground utilities or structures.
- 13.) Lateral connections must be cut 8-inches from sewer main, a non-hub stainless steel coupling and a 6-inch long section of SCH-40 PVC pipe with cap must be installed as per attached "JCMUA - Sewer Lateral Abandonment Detail". All existing sewer mains and upstream sanitary laterals to be abandoned must be filled with concrete slurry or removed from the ground. Precautions must be undertaken by the contractor to ensure concrete and other materials do not enter the sewer main and create obstruction(s). Catch basins and manholes must be

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removed from the ground.

Engineering Department.

having jurisdiction.

- 14.) All new sanitary and storm lateral connections into the combined sewers and all sanitary and storm lateral disconnections must be witnessed and inspected by JCMUA inspectors. JCMUA must be notified two days in advance prior to making any sanitary and storm lateral connections or disconnections. All notifications must be done by certified mail: JCMUA Engineering, 555 Route 440 Jersey City, New Jersey 07305 or email: engineering@jcmua.com.
- 15.) Bedding and backfill material shall comply with the requirements of the NJDOT's Standard Specification for Road and Bridge Construction, and the Design and Construction of Urban Stormwater Management Systems, ASCE Manuals and Reports of Engineering Practice No. 77, 1993, as applicable.
- 16.) Street Pavement must restore and InfraRed as per Jersey City Division of Engineering, Traffic and Transportation requirements.
- 17.) All proposed inlets/catch basins must be constructed with a bicycle safe grate and Campbell Foundry Co. Type "N" curb piece where required.
- 18.) Proposed water services require the review and approval of the JCMUA
- 19.) The contractor is responsible for obtaining permits for street openings from the Jersey City Division of Engineering, Traffic and Transportation located at 13-15 East Linden Ave, Jersey City, NJ and all other applicable permits from agencies


The system designer is also responsible for compliance with the applicable regulations of the New Jersey Administrative Code, NJDEP Rules and Regulations Governing treatment Works Approval Program, local codes and ordinances, federal and state regulations etc. in addition to other requirements that may be imposed by the JCMUA.

JCMUA - SEWER LATERAL ABANDONMENT DETAIL

CUT, CAP & FILL ABANDONED PIPE WITH GROUT OR NON-HUB FLOWABLE FILL **EXISTING SEWER MAIN** STAINLESS STEEL COUPLING 6" LENGTH OF SCH-40 PVC 8" LENGTH OF EXISTING THE PROPERTY OF THE PARTY OF TH **SEWER LATERAL PIPE**

TREE PLANTING NOTES:

- 1. GAS OR ELECTRIC LINES SHALL BE 2' MINIMUM FROM EDGE OF TREE PIT. OIL FILLED PIPES SHALL BE 4' MINIMUM FROM EDGE OF TREE PIT. WATER AND SEWER LINES SHALL BE 2' FROM TRUNK.
- TREES SHALL NOT BE LOCATED IN FRONT OF DOORWAYS MINIMUM RECOMMENDED DISTANCE FROM TREE TRUNK: TO UTILITY POLES AND/OR LIGHTS SHALL BE 15'.
- TO WATER MAIN OVER 20" DIA. SHALL BE 6'. TO STREET SIGNS AND TRAFFIC SIGNS SHALL BE 5'
- 3.4. TO CURB SHALL BE 7'. 3.5. TO FIRE HYDRANT SHALL BE 5'.
- 3.6. TO CURB OF NEAREST INTERSECTION SHALL BE 30'.
- 4. MINIMUM DISTANCE FROM EDGE OF TREE PIT TO NEAREST WALL OR FENCE SHALL BE 5'.
- 5. NO TREES SHALL BE INSTALLED BETWEEN UTILITY VAULTS AND
- 6. DO NOT PLANT NEW TREES UNDER OVERHEAD BRANCHES OF ADJACENT TREES.
- 7. TREE CROWN AND TRUNK SHALL BE FREE OF DEFECTS AND TRUE TO FORM.
- MAINTENANCE TRACKING TAG SHALL BE ATTACHED TO STURDY SCAFFOLD BRANCH. 9. NO PAVERS, 4 SIDED TREE GUARDS, OR OTHER MATERIALS
- SHALL BE PLACED WITHIN THE TREE BED. 10. CUT AND REMOVE BURLAP FROM TOP 2/3 OF ROOT BALL,
- REMOVE WIRE BASKET COMPLETELY. 11. FLOOD TREES WITH WATER WITHIN THE FIRST 24 HOURS OF PLANTING.
- 12. NSTALL PHC TREE SAVER MYCORRHIZAL FUNGAL TRANSPLANT INOCULANT FOR TREES AND SHRUBS. INSTALL ONE 3 OUNCE PACKET PER CALIPER INCH OR PER 1 FOOT OF ROOTBALL DIA. 13. CONTRACTOR SHALL HAVE A GUARANTEE PERIOD OF 2 YEARS
- FOR EACH TREE PLANTED. 14. TOPSOIL SHALL COMPLY WITH THE FOLLOWING REQUIREMENTS: 14.1. NATURAL LOAM WITH THE ADDITION OF COMPOST OR HUMUS 14.2. ORGANIC MATTER CONTENT SHALL BE BETWEEN 5% - 12%
- 14.3. THE pH SHALL BE IN THE RANGE OF 6.0 TO 7.0 INCLUSIVE UNLESS OTHERWISE APPROVED OR SPECIFIED BY THE JERSEY CITY FORESTER 14.4. SOIL TEXTURAL ANALYSIS: TOP SOIL SHALL CONSIST OF THE FOLLOWING PERCENTAGES OF SAND, SILT, AND CLAY. ANY SOIL THAT DOES NOT MEET THE REQUIREMENTS BELOW WILL
- BE REJECTED AND REMOVED FROM THE SITE. ROCKS, STONE AND GRAVEL >2.0 mm <5% 40 - 60% SAND (0.05-2.0 mm) SILT (0.002 - 0.05mm) 20 - 50%
- 20% MAXIMUM CLAY (<0.002 mm) 14.5. WHEN TOPSOIL OTHERWISE COMPLIES WITH THE REQUIREMENTS OF THE SPECIFICATION BUT SHOWS A DEFICIENCY IN ORGANIC MATTER, COMPOST MAY BE INCORPORATED WHEN AND AS PERMITTED BY THE
- FORESTER. 15. ROOT BALL SIZE RELATIVE TO TREE HEIGHT SHALL BE WITHIN THE RANGES SET BY THE AMERICAN NURSERY STANDARDS

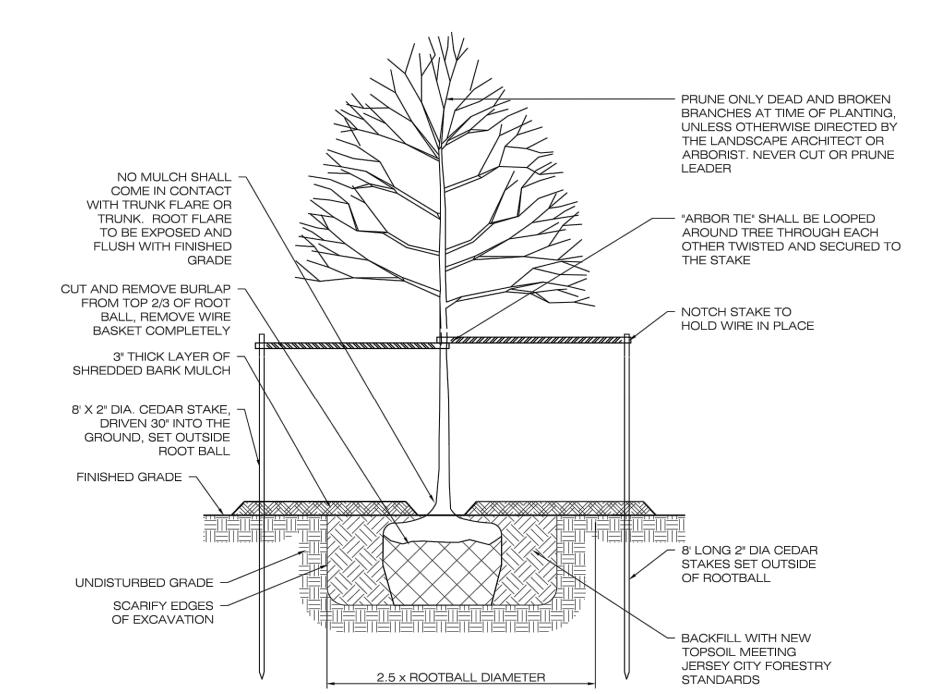

TYPICAL TREE PLANTING DETAIL AND NOTES

9" X 20" CONCRETE

PERMEABLE PRECAST

5" x 0.25" STEEL EDGE,

ALONG PERMEABLE

CONCRETE PAVER

BAND - 5' WIDE

CURB

PAVERS

STREET TREE

5' x 10' PLANTED AND

632 Pompton Avenue

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ANTHONY D'AGOSTA III

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REVISIONS:

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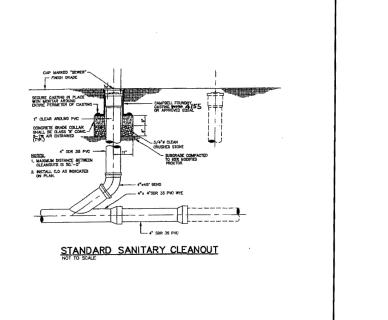
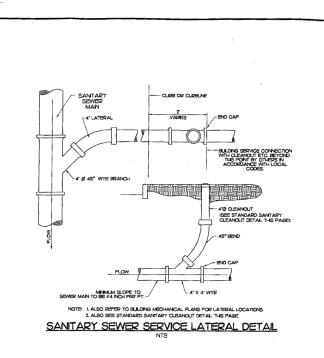
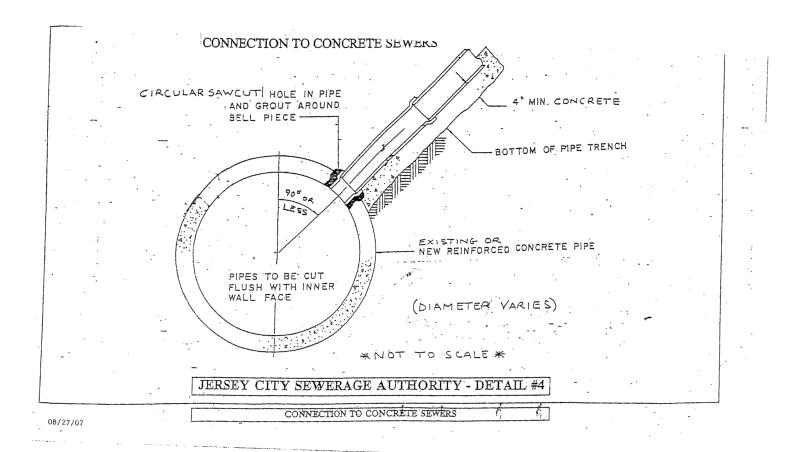
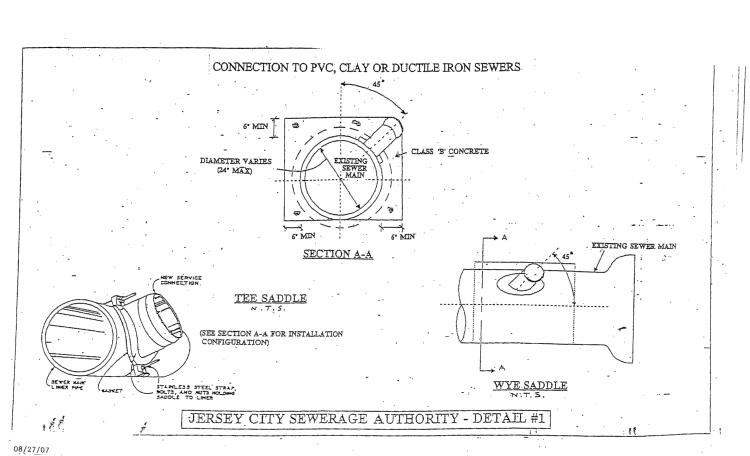
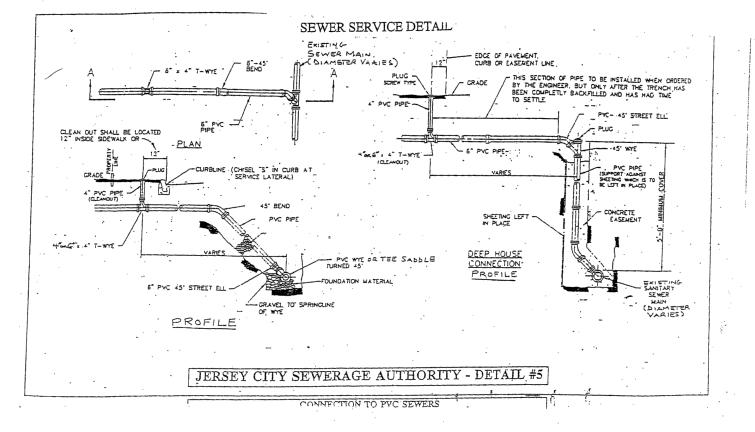


Figure 6.1 SDR-35 PVC Sanitary Sewer Trench Detail









8' LONG 2" DIA CEDAR STAKES SET OUTSIDE OF ROOT BALL 'ARBOR TIE" SHALL BE LOOPED AROUND TREE THROUGH EACH OTHER TWISTED AND SECURED TO THE STAKE 18" HT., 3-SIDED TREE GUARD, SEE JERSEY CITY FORESTRY STANDARDS APPENDIX E ROOT FLARE TO BE EXPOSED AND FLUSH WITH FINISHED GRADE GROUNDCOVER PLANTING WITH 3" SHREDDED BARK MULCH LAYER ADJACENT SIDEWALK CUT AND REMOVE BURLAP FROM TOP 2/3 OF ROOT BALL, REMOVE WIRE BASKET COMPLETELY BACKFILL WITH NEW TOPSOIL MEETING JERSEY CITY FORESTRY STANDARDS - PLACE BALL ON 95% COMPACTED TOPSOIL SECTION A 18" HT., 3-SIDED TREE GUARD, SEE JERSEY CITY FORESTRY STANDARDS APPENDIX E ROOT FLARE TO BE EXPOSED AND FLUSH WITH FINISHED GRADE PERMEABLE PRECAST CONCRETE PAVERS OVER AGGREGATE BASE 5" x 0.25" STEEL EDGE - GROUNDCOVER PLANTING WITH 3" SHREDDED BARK MULCH LAYER BACKFILL WITH NEW TOPSOIL MEETING JERSEY CITY FORESTRY STANDARDS PLACE BALL ON 95%

COMPACTED TOPSOIL

MULCHED OPENING, PLANT WITH PERENNIALS OR GROUNDCOVER TREE GUARD, SEE JERSEY CITY FORESTRY STANDARDS APPENDIX E 5" x 0.25" STEEL EDGE, ALONG PERMEABLE **PAVERS ADJACENT** SIDEWALK PERMEABLE PRECAST CONCRETE PAVER BAND - 5' WIDE PLAN VIEW

STREET TREE PLANTING DETAIL AND TREE PIT DETAIL

N.T.S.

01.11.2021

SEWER CONNECTION DETAIL

SECTION B


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JCMUA UPDATES

IAE PROJECT NO:

SHEET TITLE:

SITE DETAILS - III

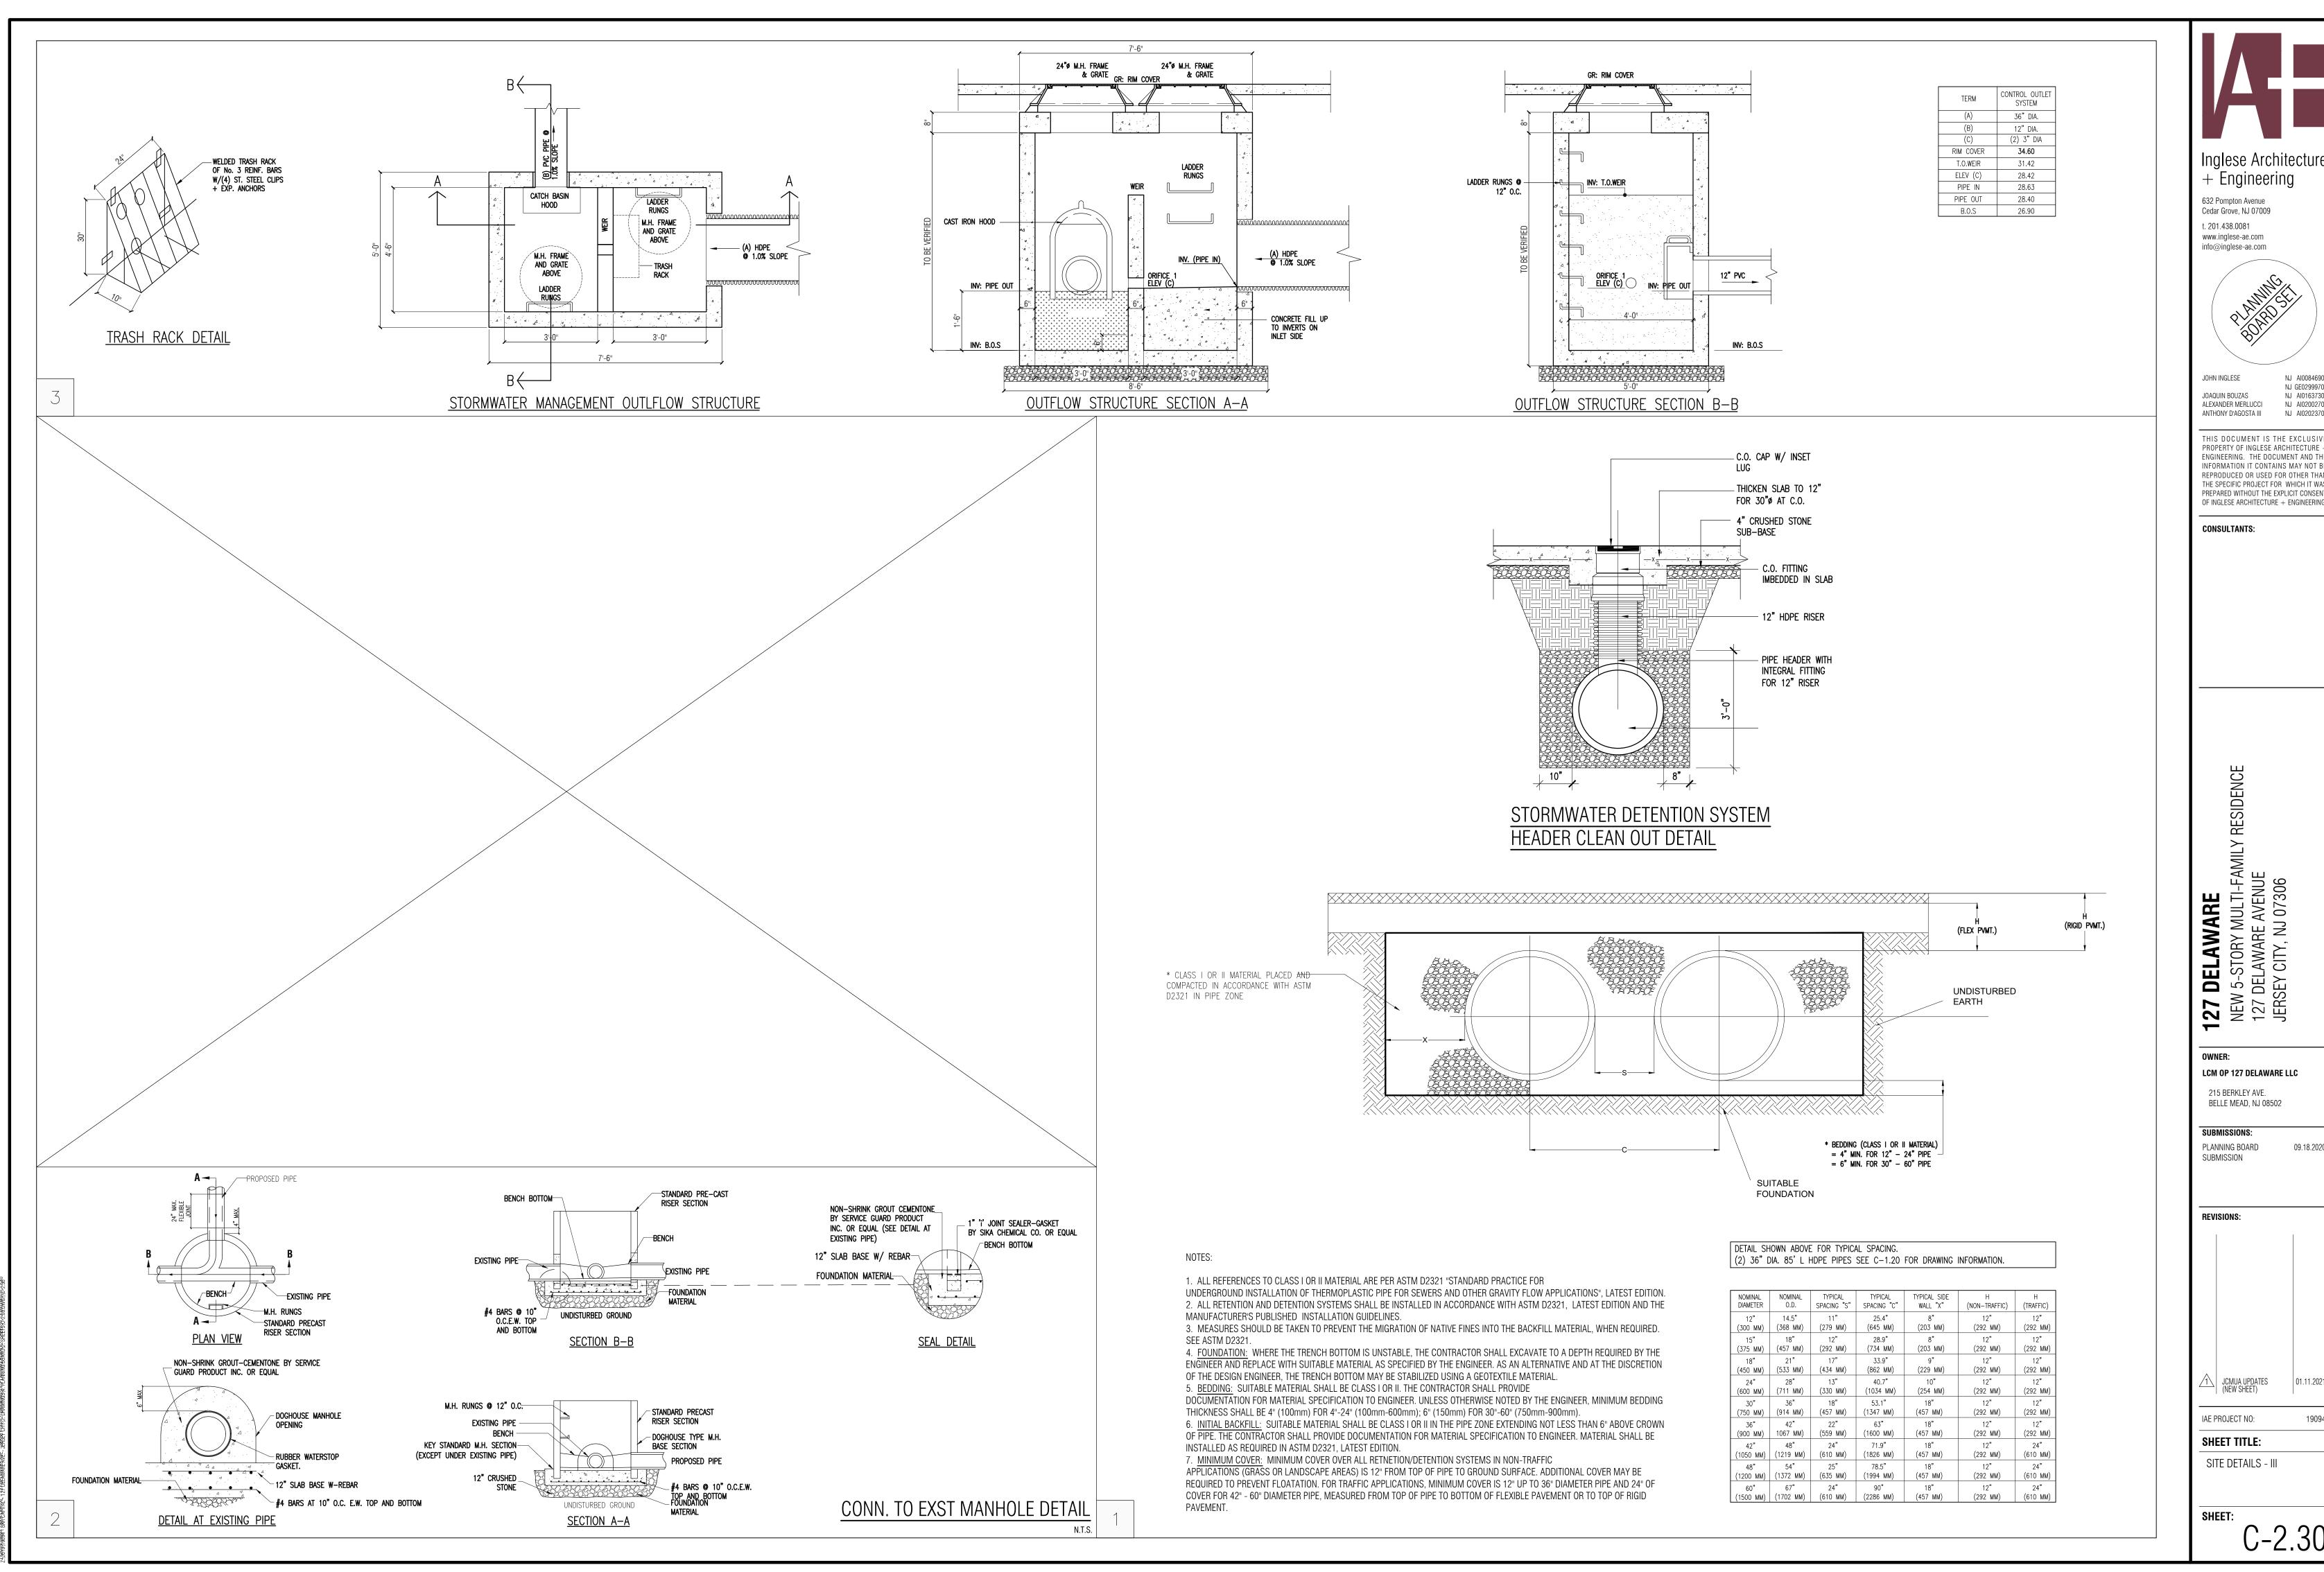

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LCM OP 127 DELAWARE LLC


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SUBMISSIONS: PLANNING BOARD SUBMISSION

01.11.2021

JCMUA UPDATES (NEW SHEET)

SHEET TITLE: SITE DETAILS - III

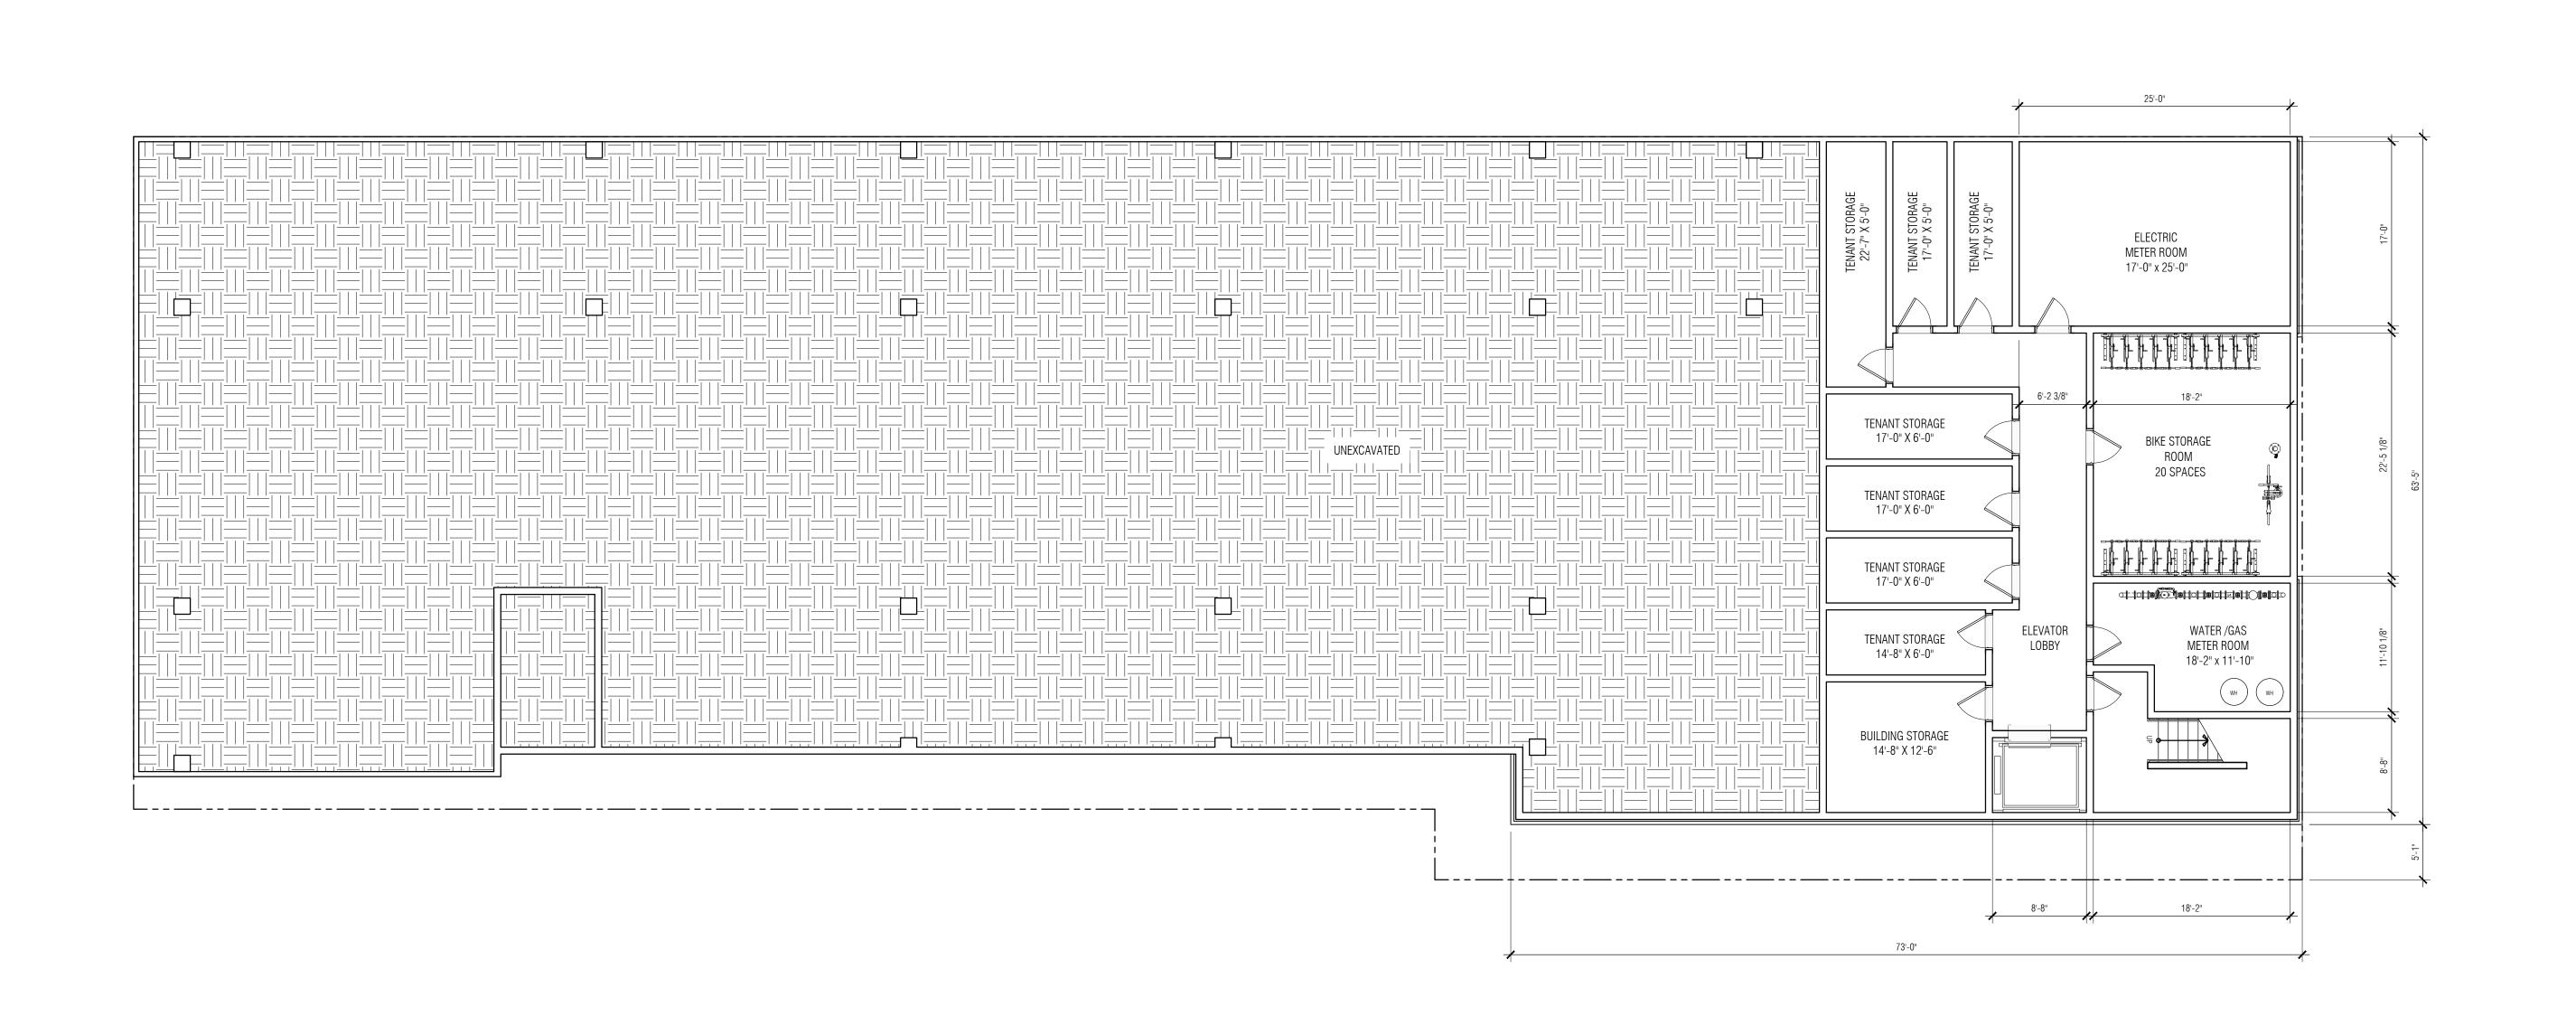

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09.18.2020

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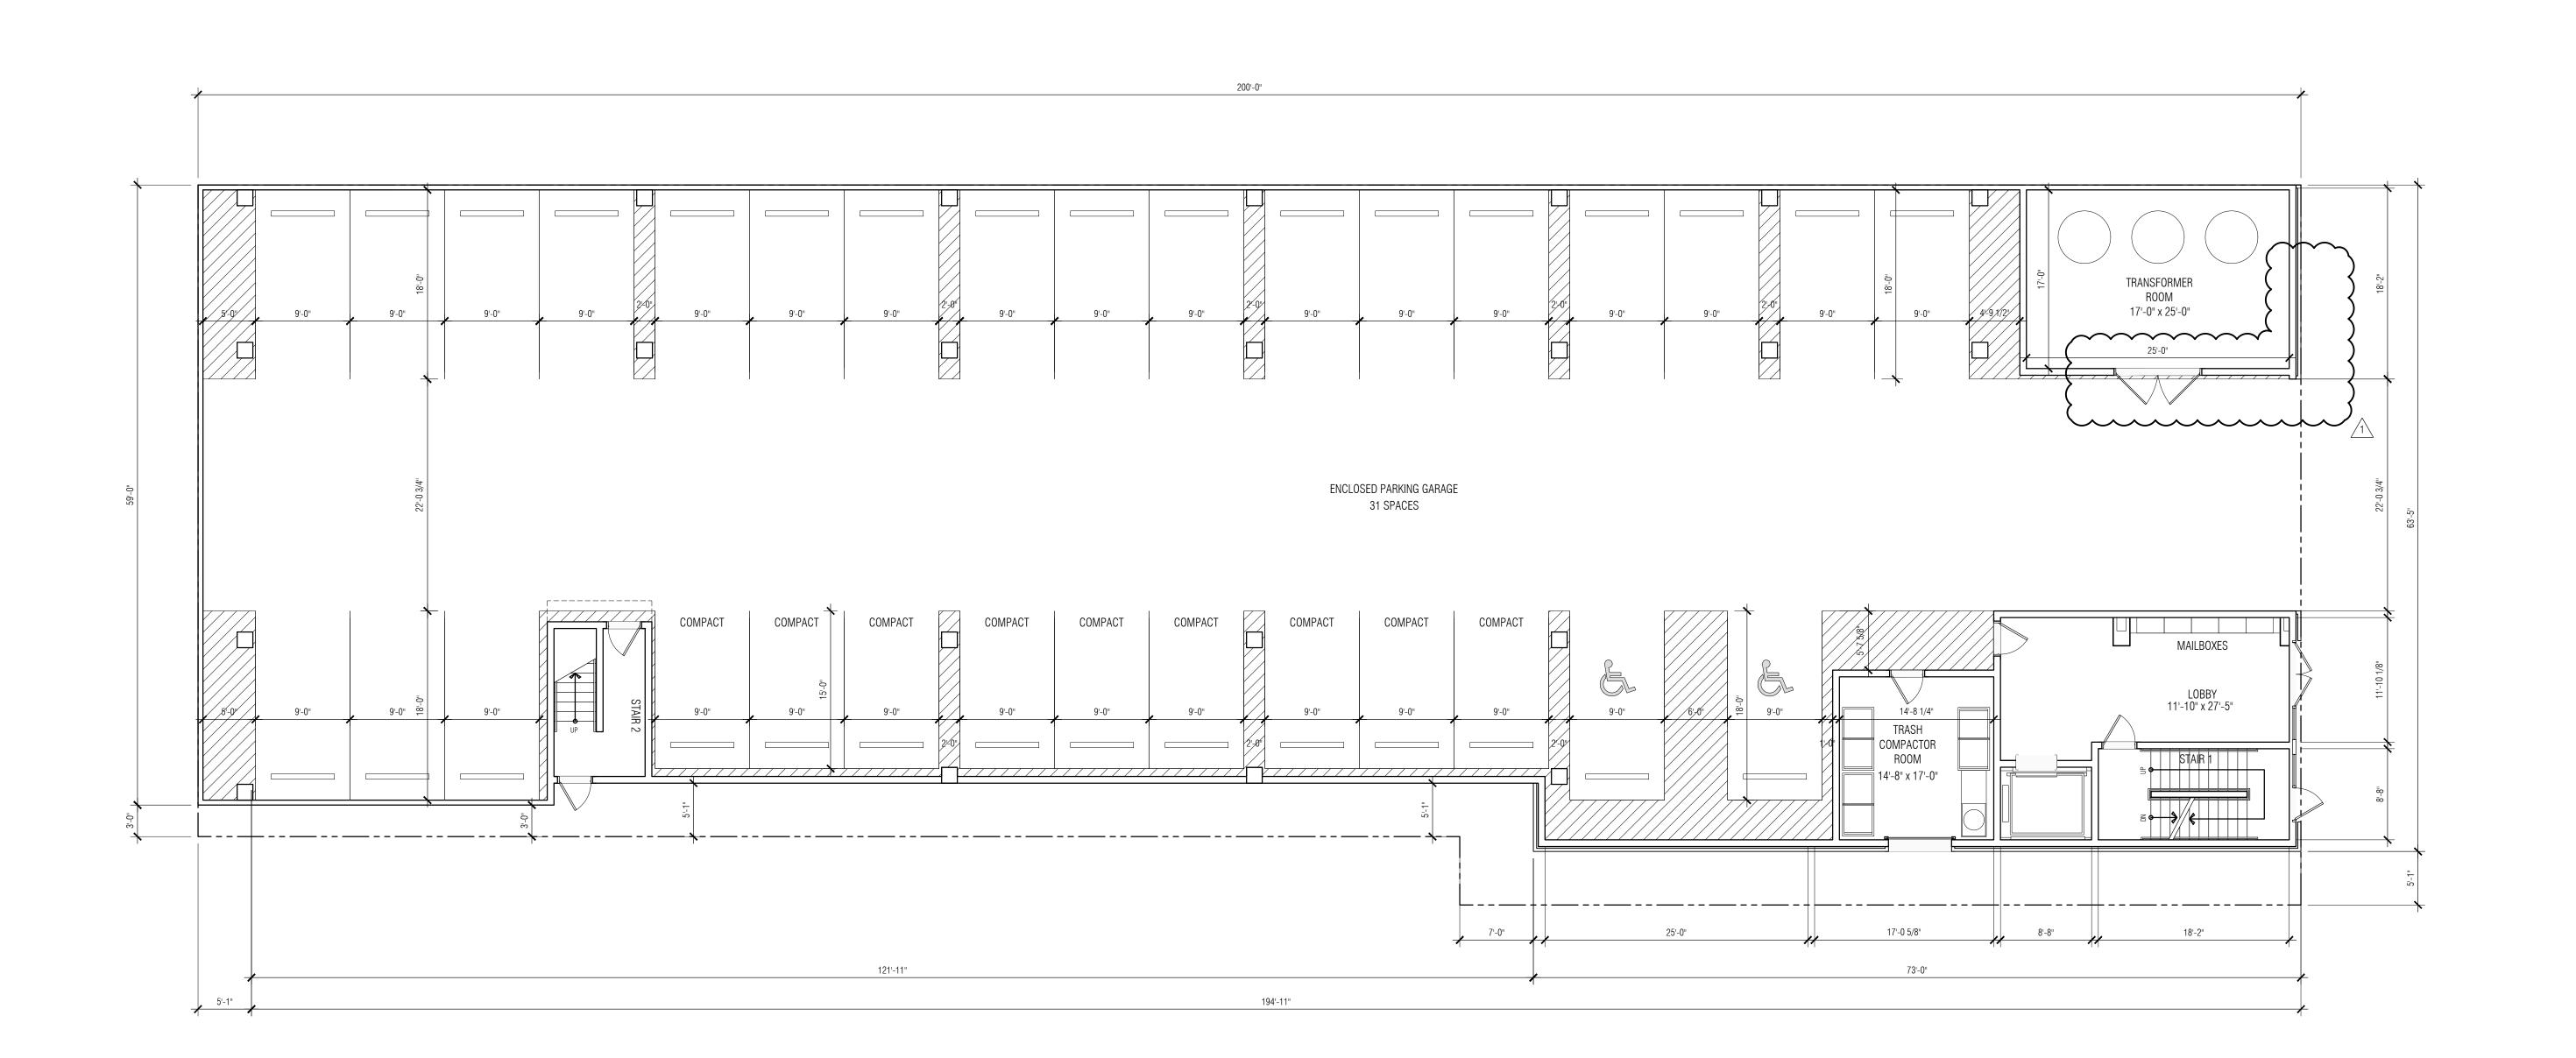
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SHEET TITLE:


BASEMENT FLOOR PLAN

BASEMENT FLOOR PLAN

SCALE: 1/8" = 1'-0"



GROUND FLOOR PLAN
SCALE: 1/8" = 1'-0"

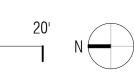



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OWNER: LCM OP 127 DELAWARE LLC 215 BERKLEY AVE. BELLE MEAD, NJ 08502

SUBMISSIONS: PLANNING BOARD SUBMISSION

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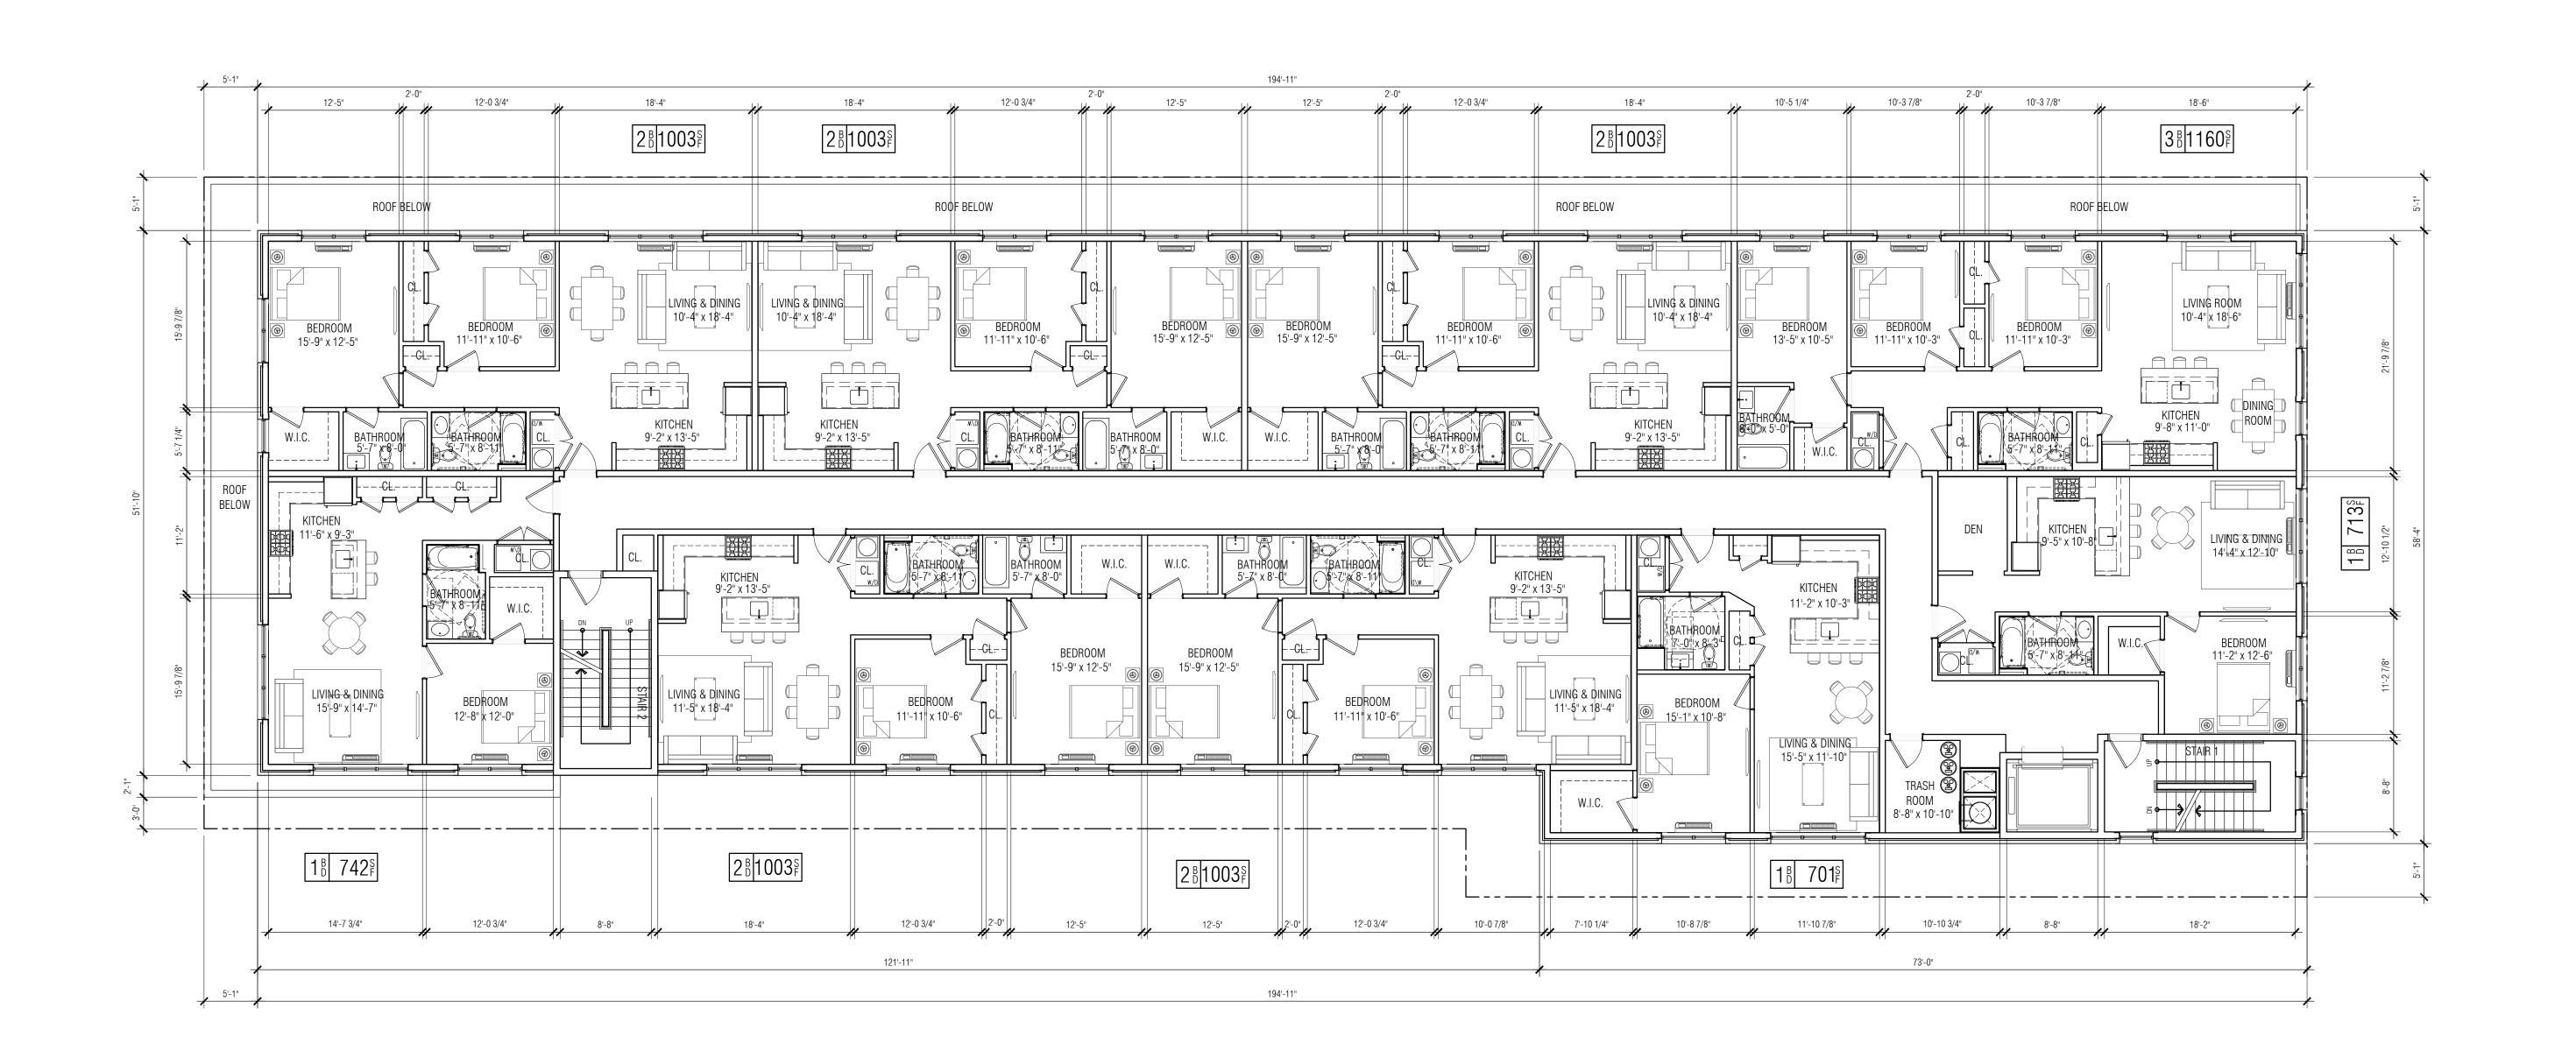
1 UTILITY REVISION 01.12.2021

IAE PROJECT NO:

SHEET TITLE: GROUND FLOOR PLAN

SHEET:

A-1.01



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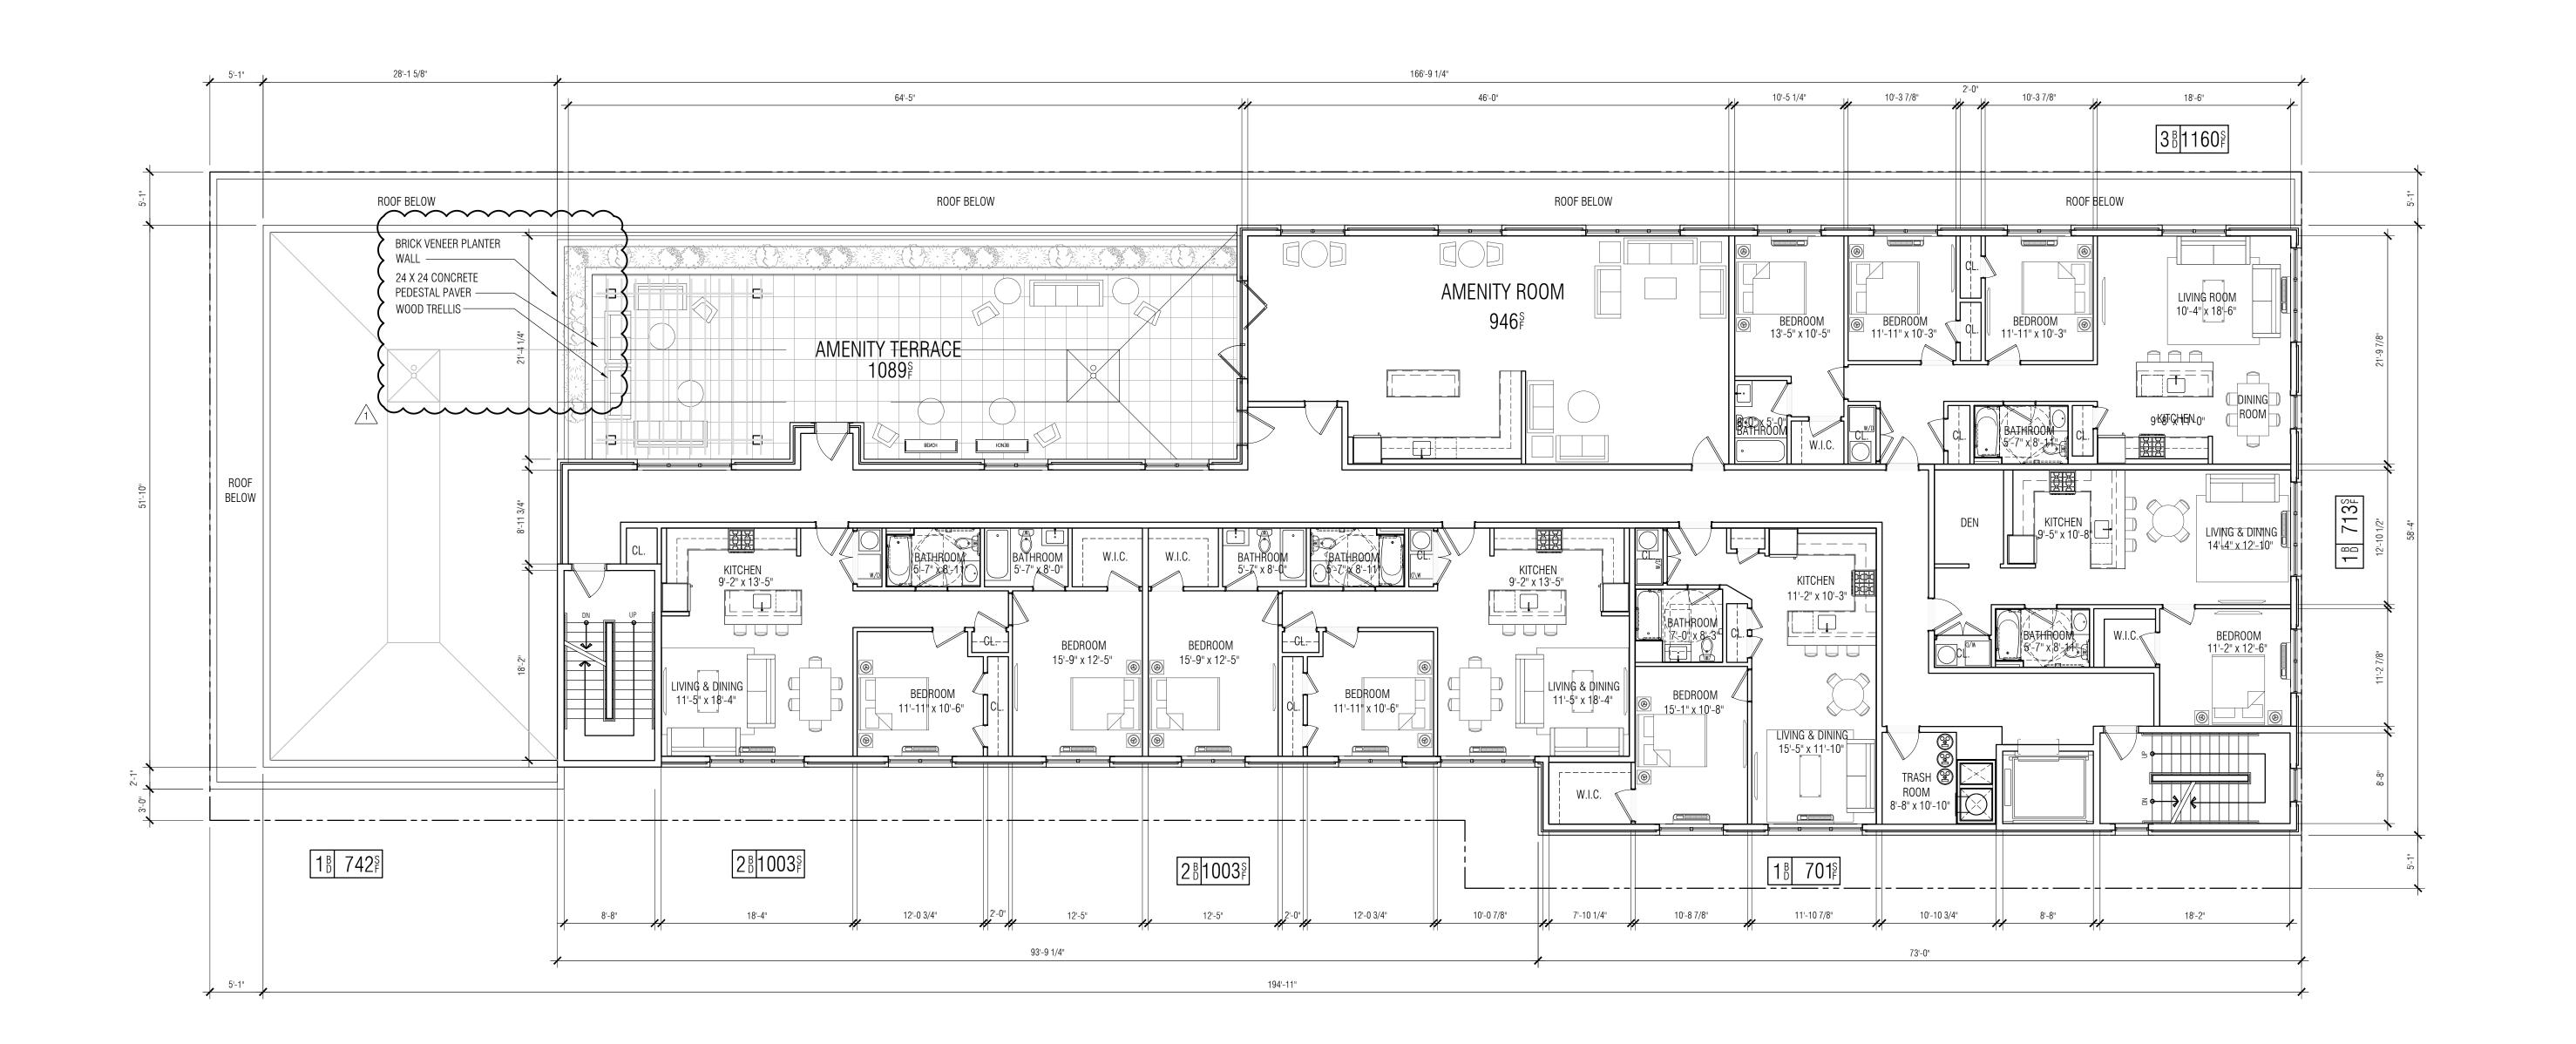
SECOND - FOURTH FLOOR PLAN

SCALE: 1/8" = 1'-0"

IAE PROJECT NO:

SHEET TITLE: SECOND - FOURTH FLOOR PLAN

SHEET: A-1.02



Tip Fifth Floor Plan

| Scale: 1/8" = 1'-0"



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CONSULTANTS:

127 DELAWARENEW 5-STORY MULTI-FAMILY RESIDE 127 DELAWARE AVENUE JERSEY CITY, NJ 07306

OWNER:
LCM OP 127 DELAWARE LLC
215 BERKLEY AVE.

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PLANNING BOARD 09 SUBMISSION

REVISIONS:

70NING COMMENTS 01.1


ZONING COMMENTS 01.12.2021

AE PROJECT NO: 19094

SHEET TITLE:

FIFTH FLOOR PLAN

SHEET: A-1 C

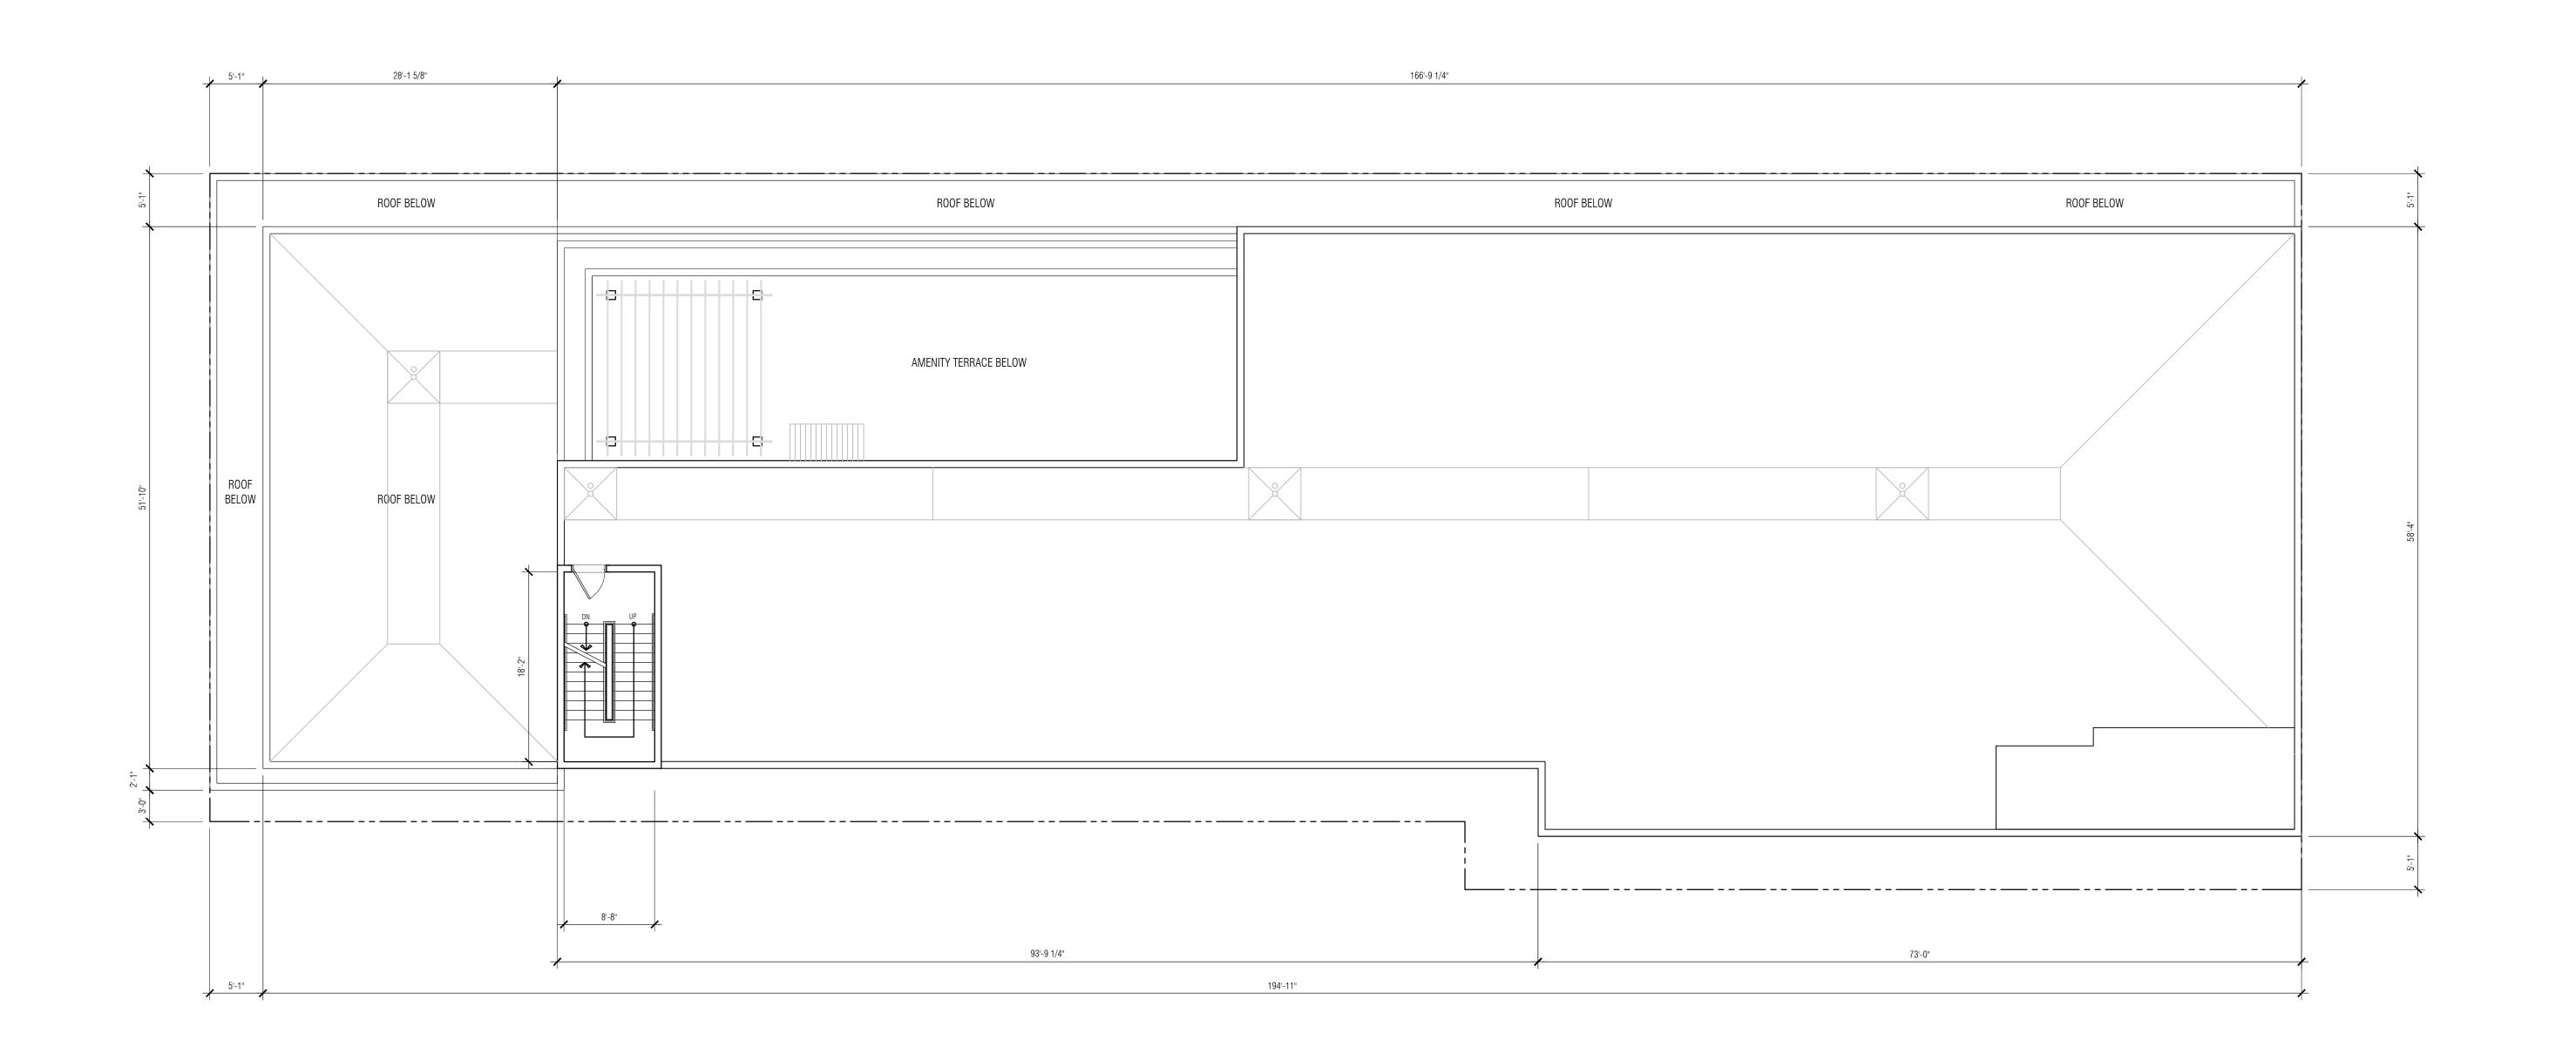

+ Engineering 632 Pompton Avenue Cedar Grove, NJ 07009 t. 201.438.0081 www.inglese-ae.com info@inglese-ae.com JOHN INGLESE NJ Al00846900 NJ GE02999700 JOAQUIN BOUZAS NJ AI01637300 ALEXANDER MERLUCCI NJ AI02002700 ANTHONY D'AGOSTA III NJ AI02023700 THIS DOCUMENT IS THE EXCLUSIVE PROPERTY OF INGLESE ARCHITECTURE + ENGINEERING. THE DOCUMENT AND THE INFORMATION IT CONTAINS MAY NOT BE REPRODUCED OR USED FOR OTHER THAN THE SPECIFIC PROJECT FOR WHICH IT WAS PREPARED WITHOUT THE EXPLICIT CONSENT OF INGLESE ARCHITECTURE + ENGINEERING. CONSULTANTS:

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JERSEY CITY, NJ 07306

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PLANNING BOARD SUBMISSION

REVISIONS:

ZONING COMMENTS 01.12.2021 IAE PROJECT NO:

SHEET TITLE: MAIN ROOF PLAN

SHEET:

 $) \frac{\text{MAIN ROOF PLAN}}{\text{SCALE: } 1/8" = 1'-0"}$

20'



FIFTH FLOOR

FOURTH FLOOR

SECOND FLOOR

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1 UTILITY REVISION

01.12.2021 IAE PROJECT NO:


SHEET TITLE: EXTERIOR ELEVATIONS I

SHEET:

NORTH ELEVATION

SCALE: 1/8" = 1'-0"



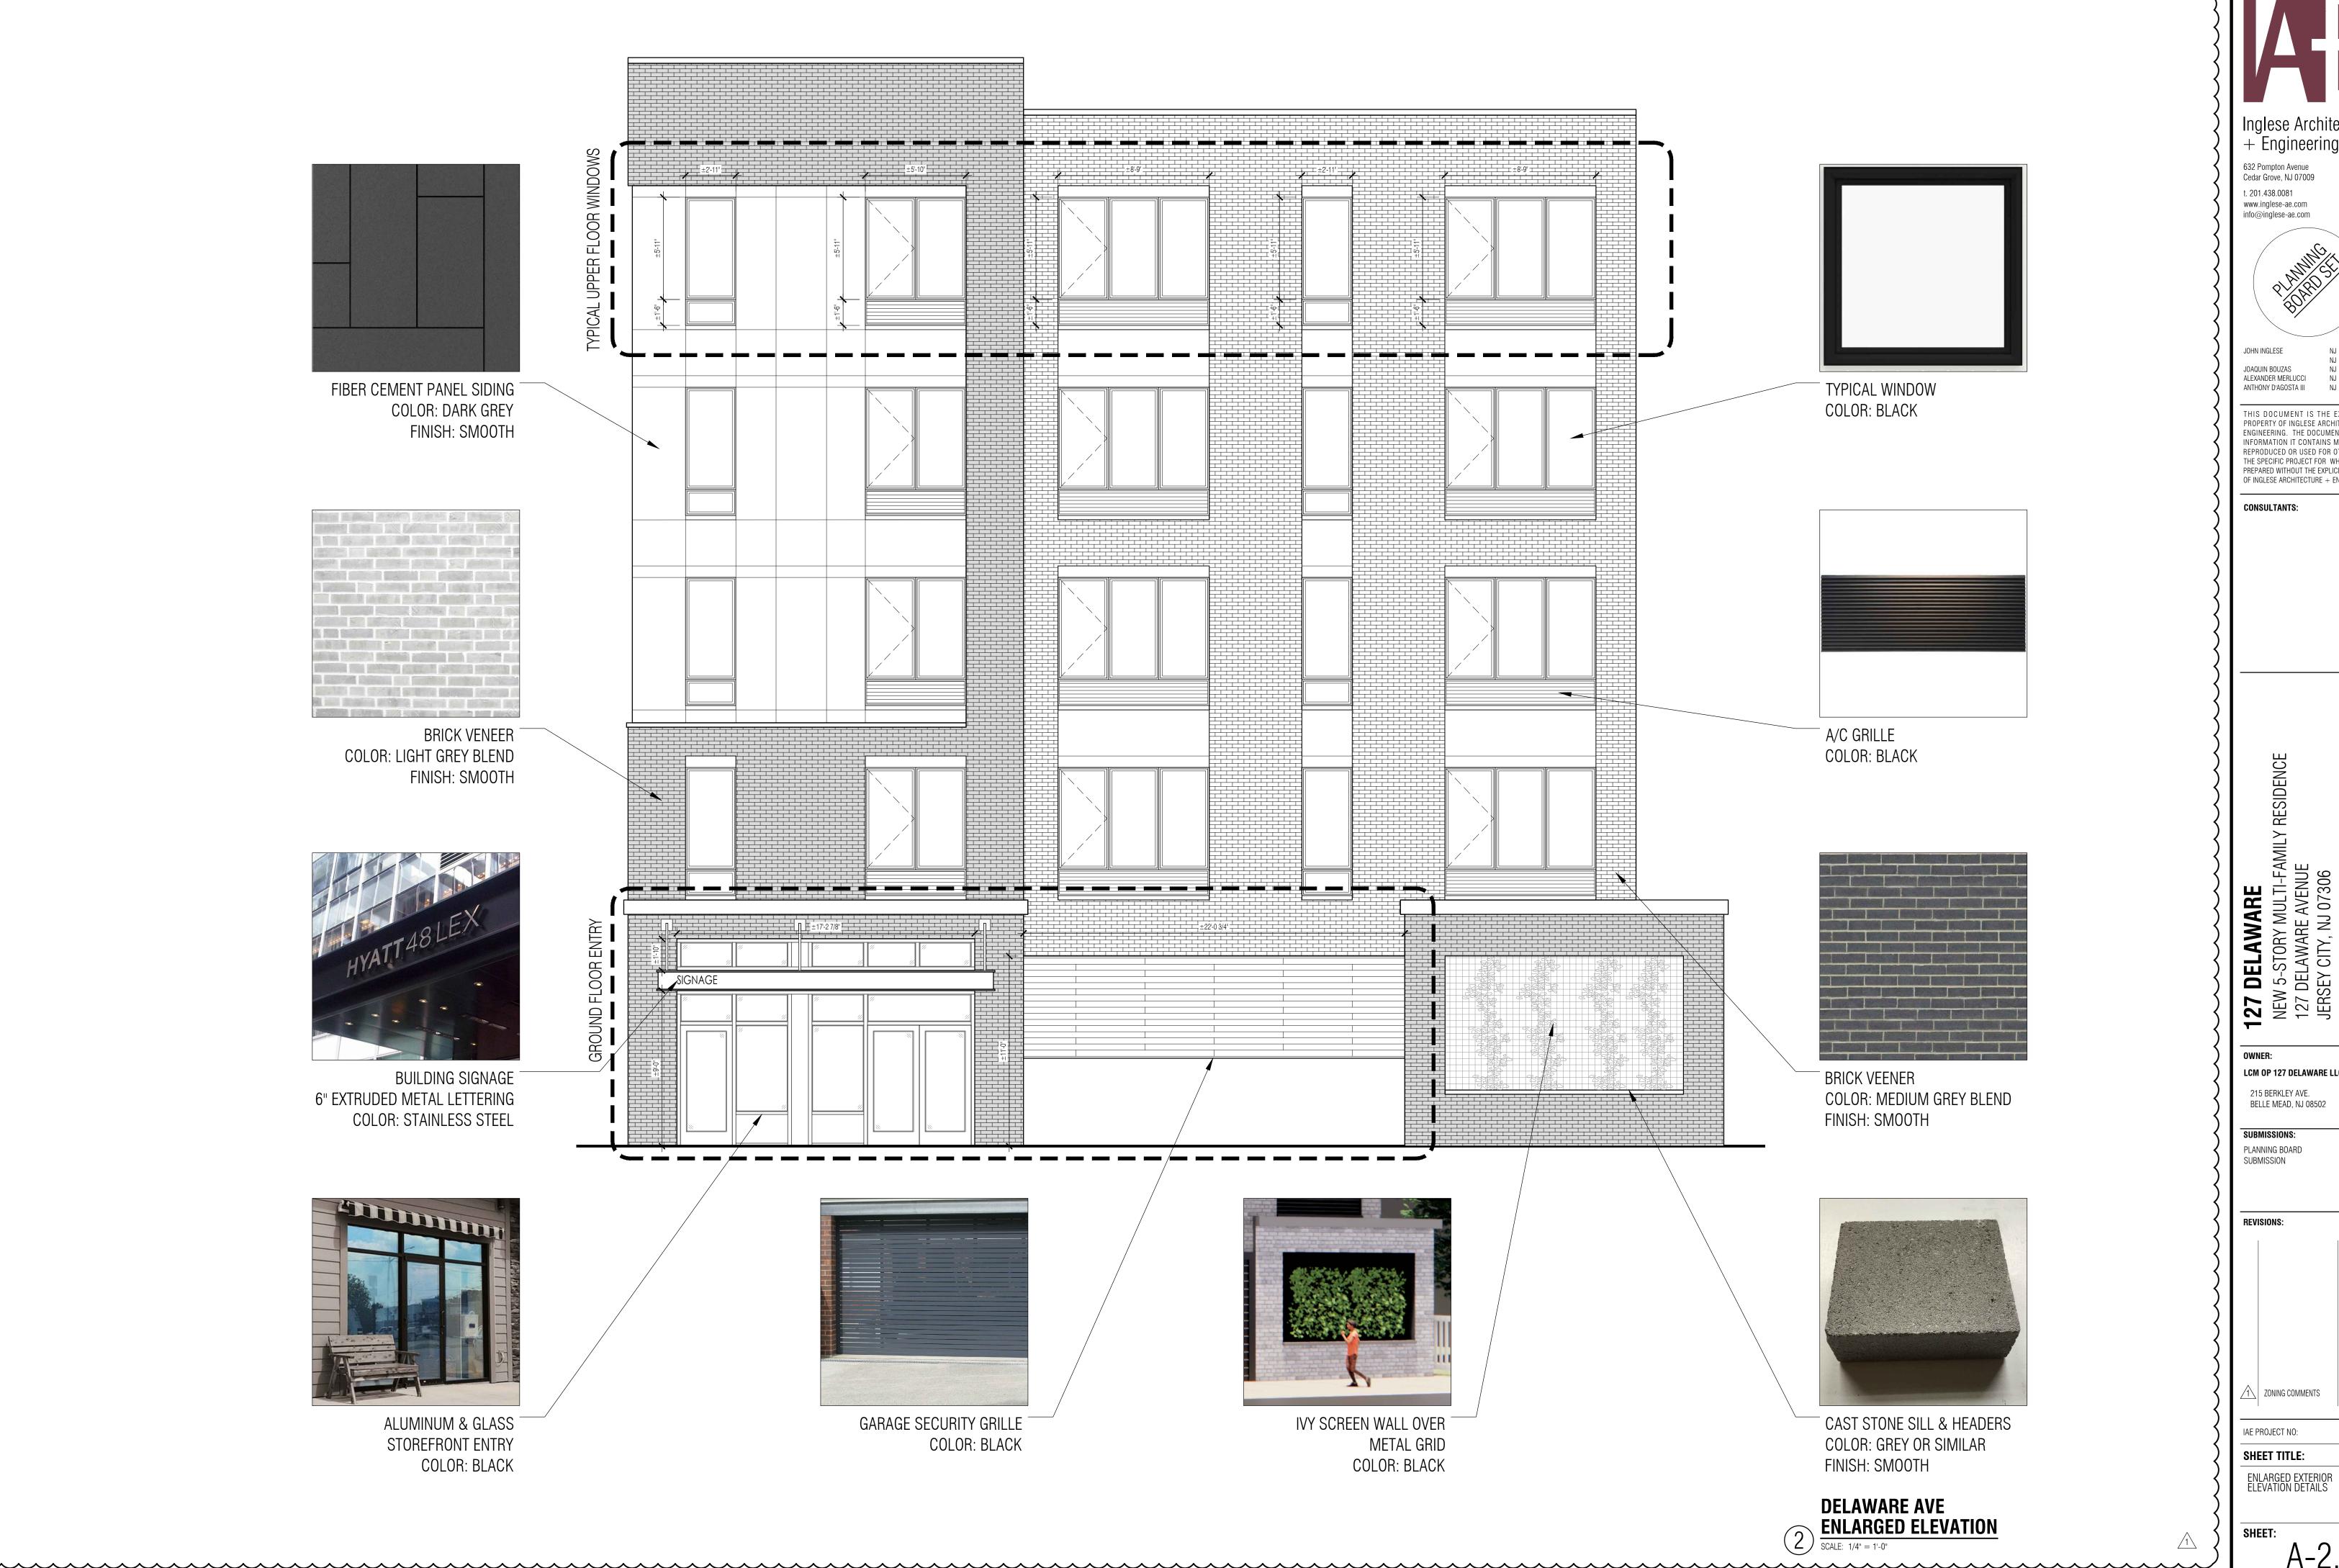

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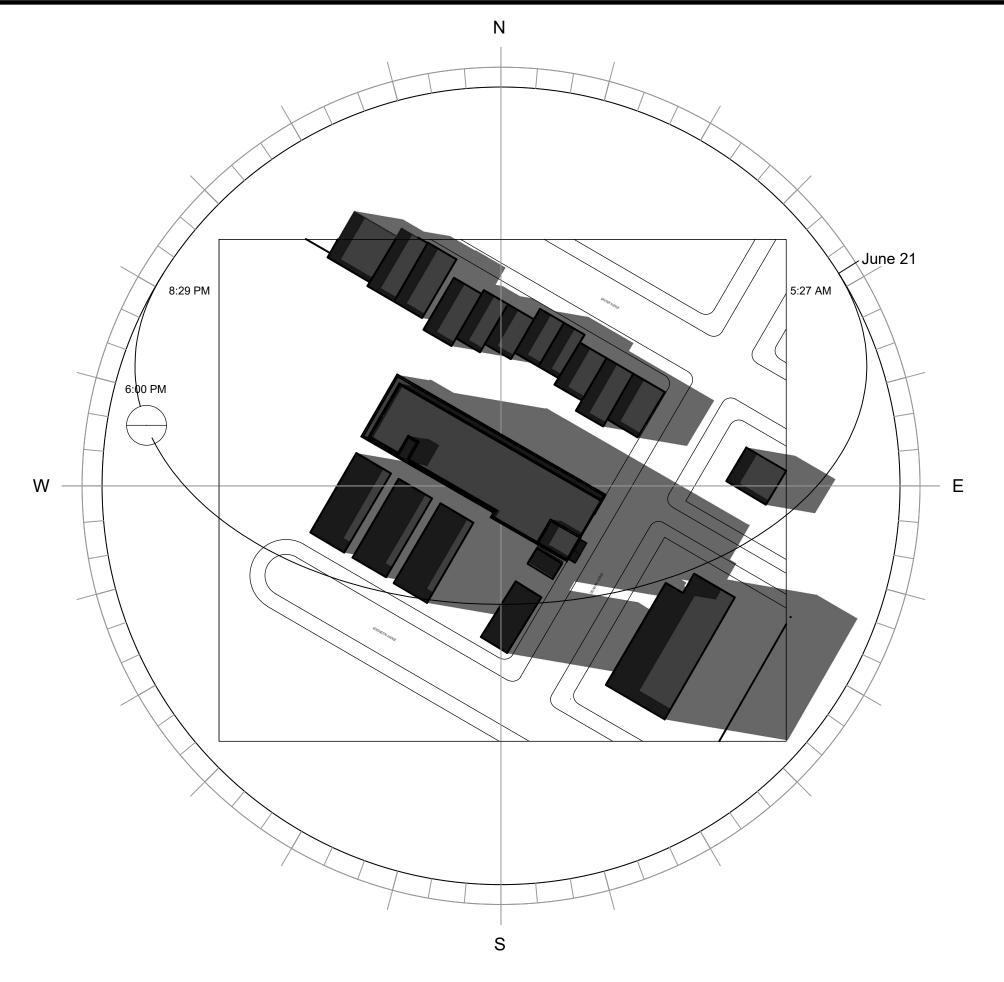
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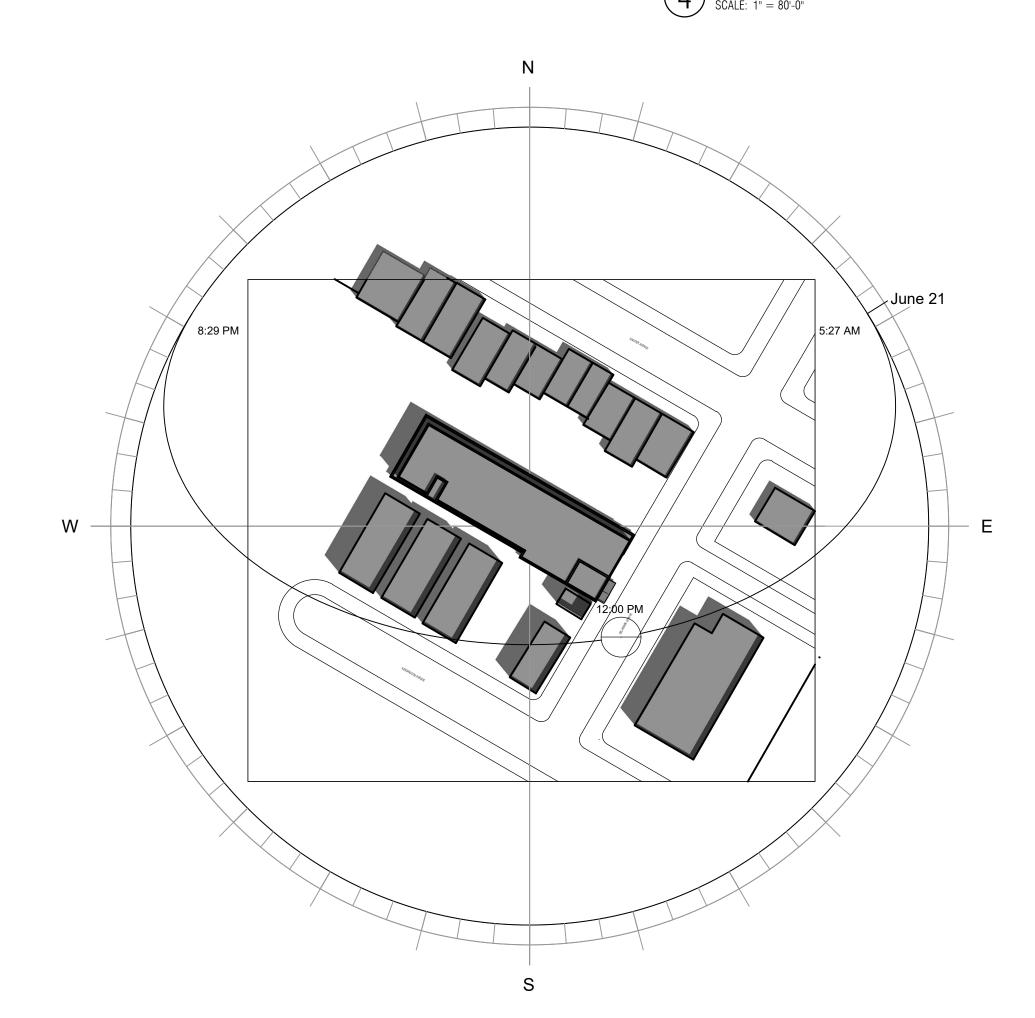
REVISIONS:

1 ZONING COMMENTS 01.12.2021


SHEET TITLE: ENLARGED EXTERIOR ELEVATION DETAILS




JUNE 21ST 6PM SCALE: 1" = 80'-0"



2 JUNE 21ST 12PM
SCALE: 1" = 80'-0"

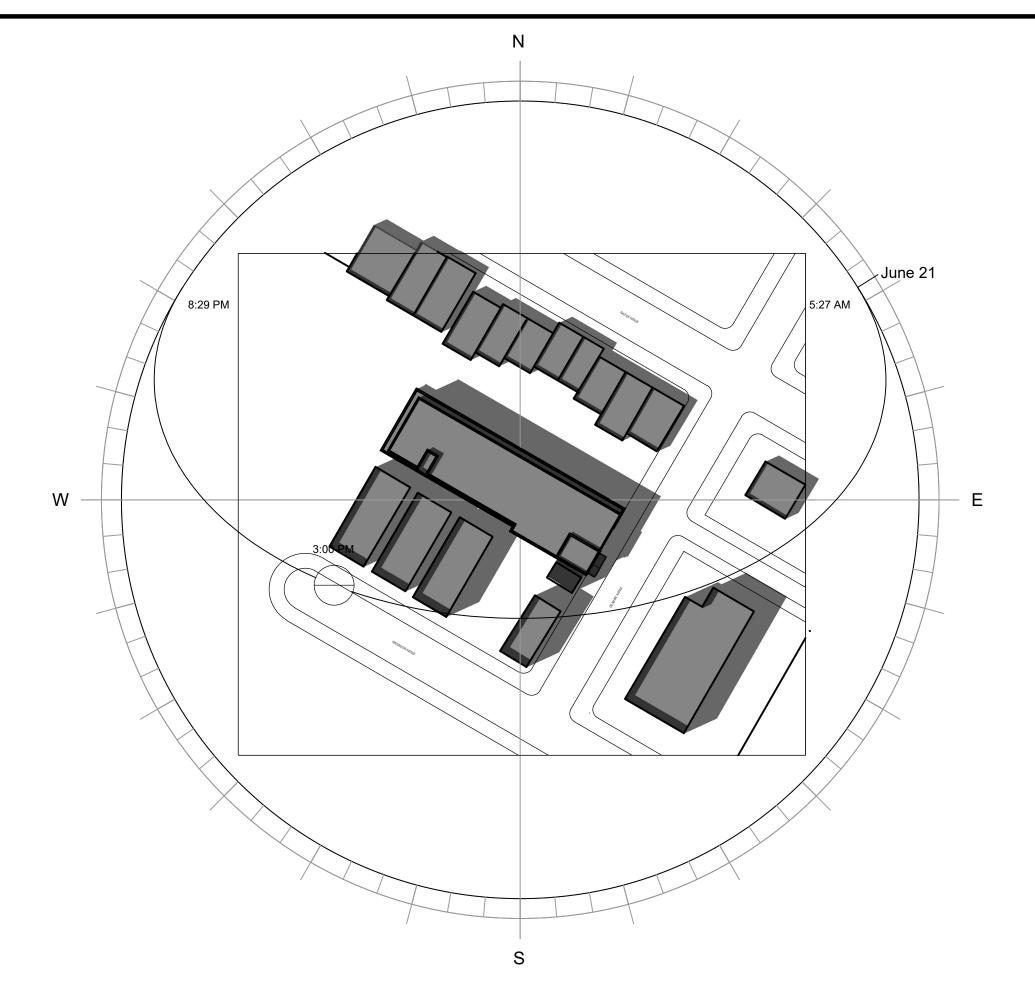

3 JUNE 21ST 3PM SCALE: 1" = 80'-0"

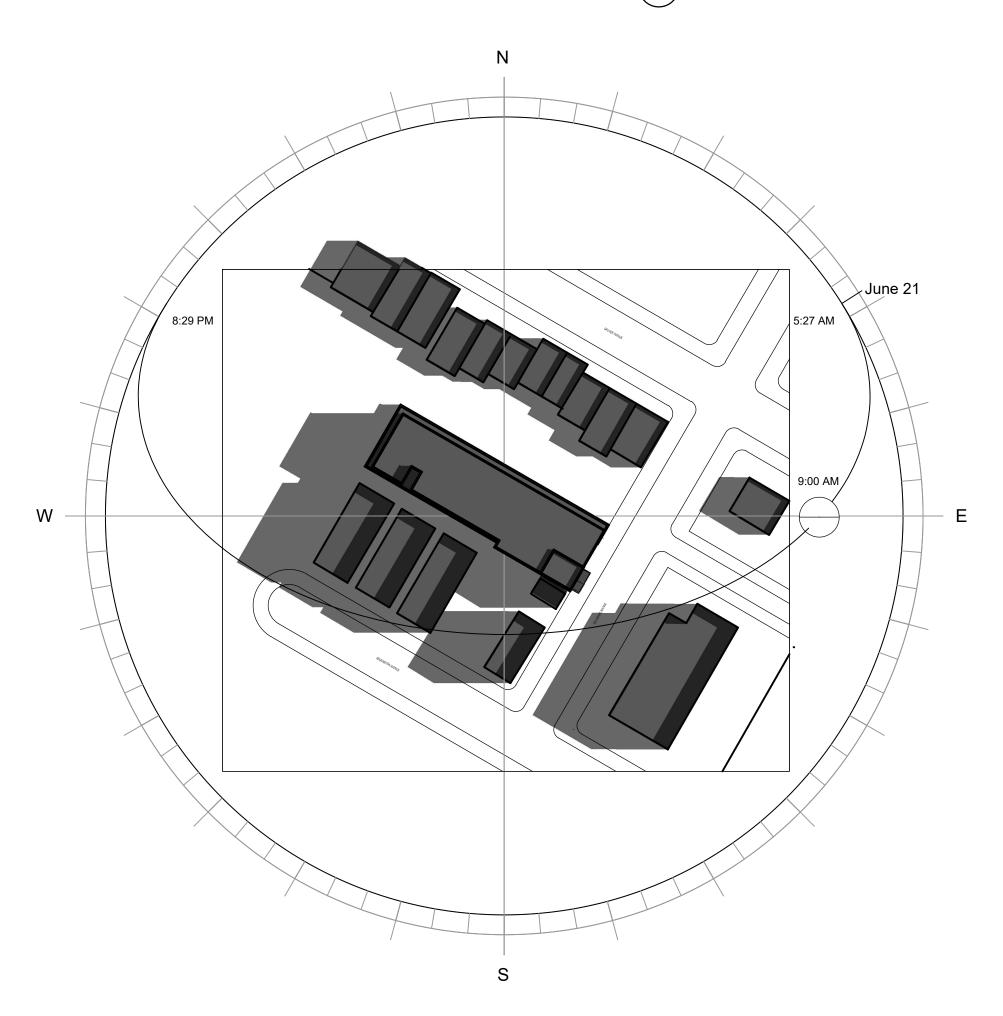

JUNE 21ST 9AM

SCALE: 1" = 80'-0"

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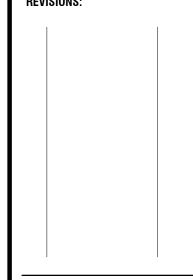
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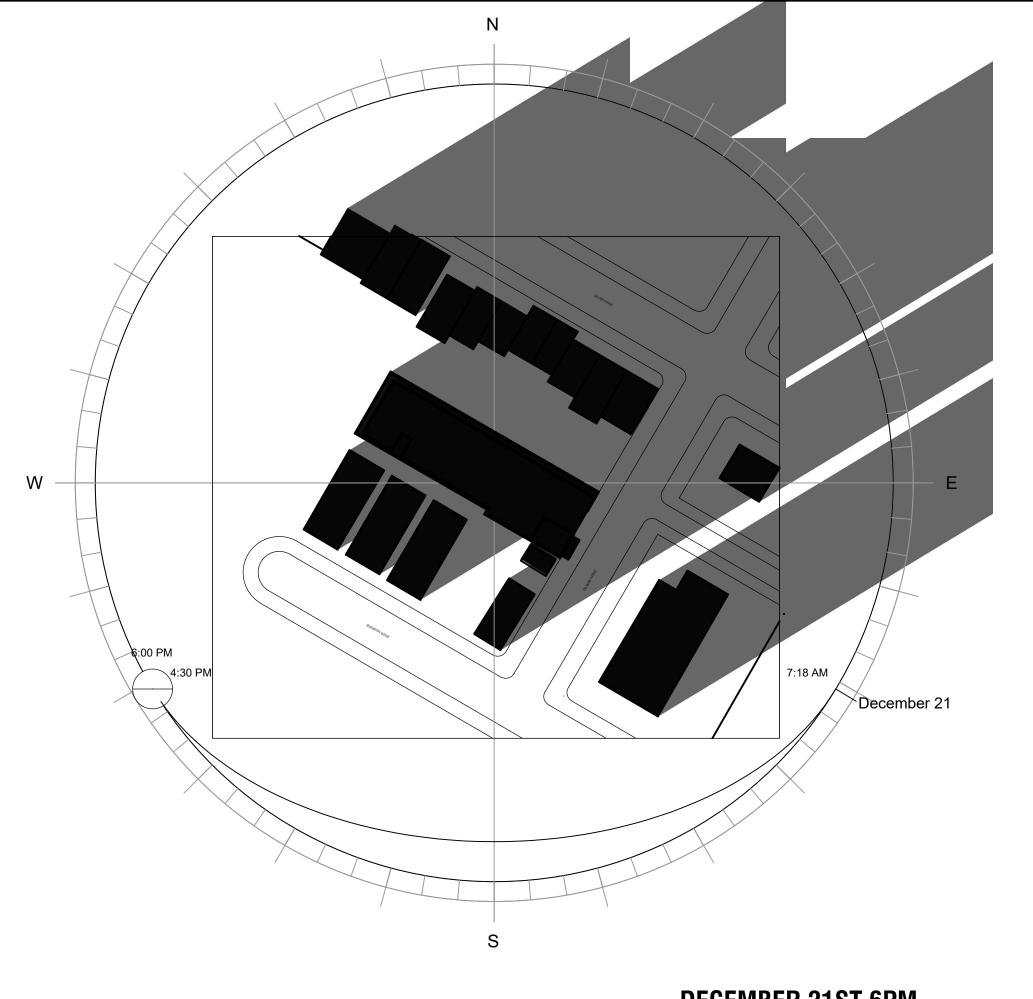
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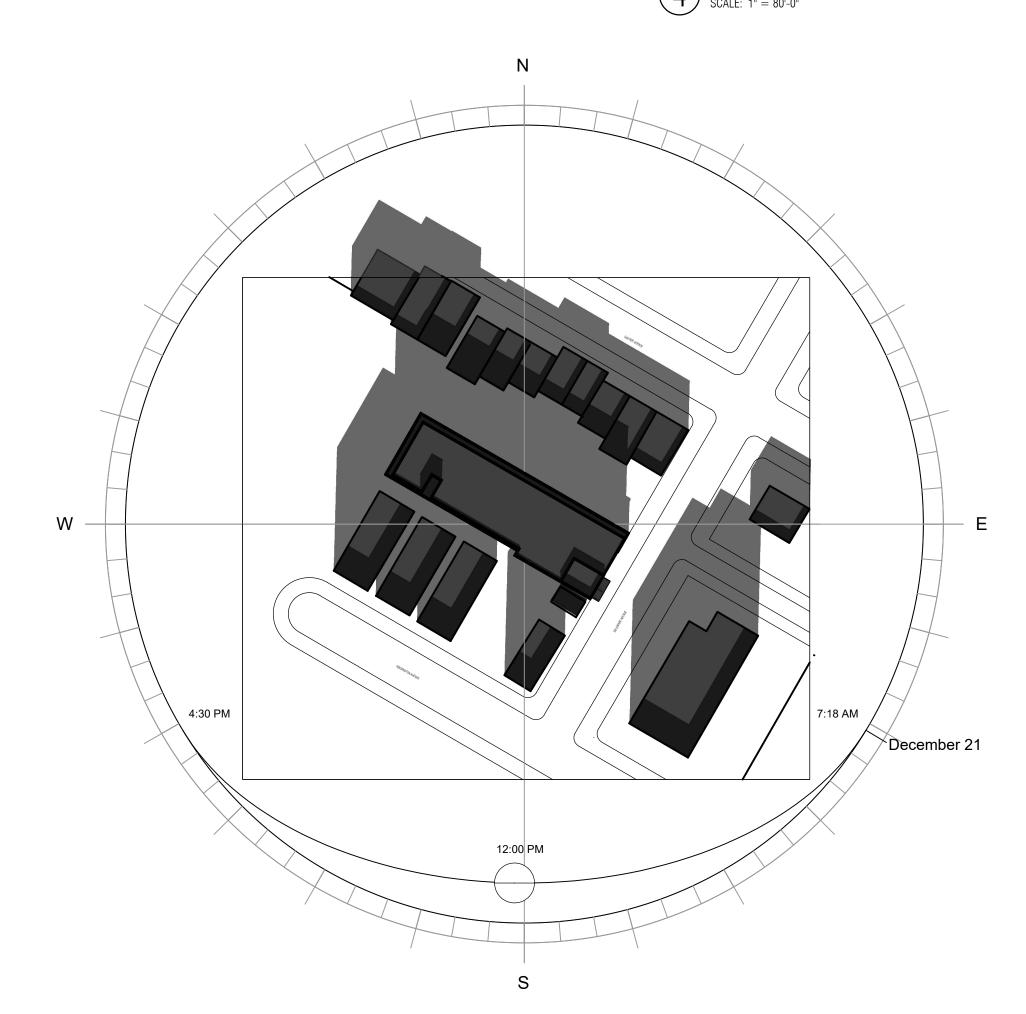
JUNE 21ST SHADOW STUDIES

SHEET:


A-3.00




4 DECEMBER 21ST 6PM SCALE: 1" = 80'-0"



2 DECEMBER 21ST 12PM
SCALE: 1" = 80'-0"

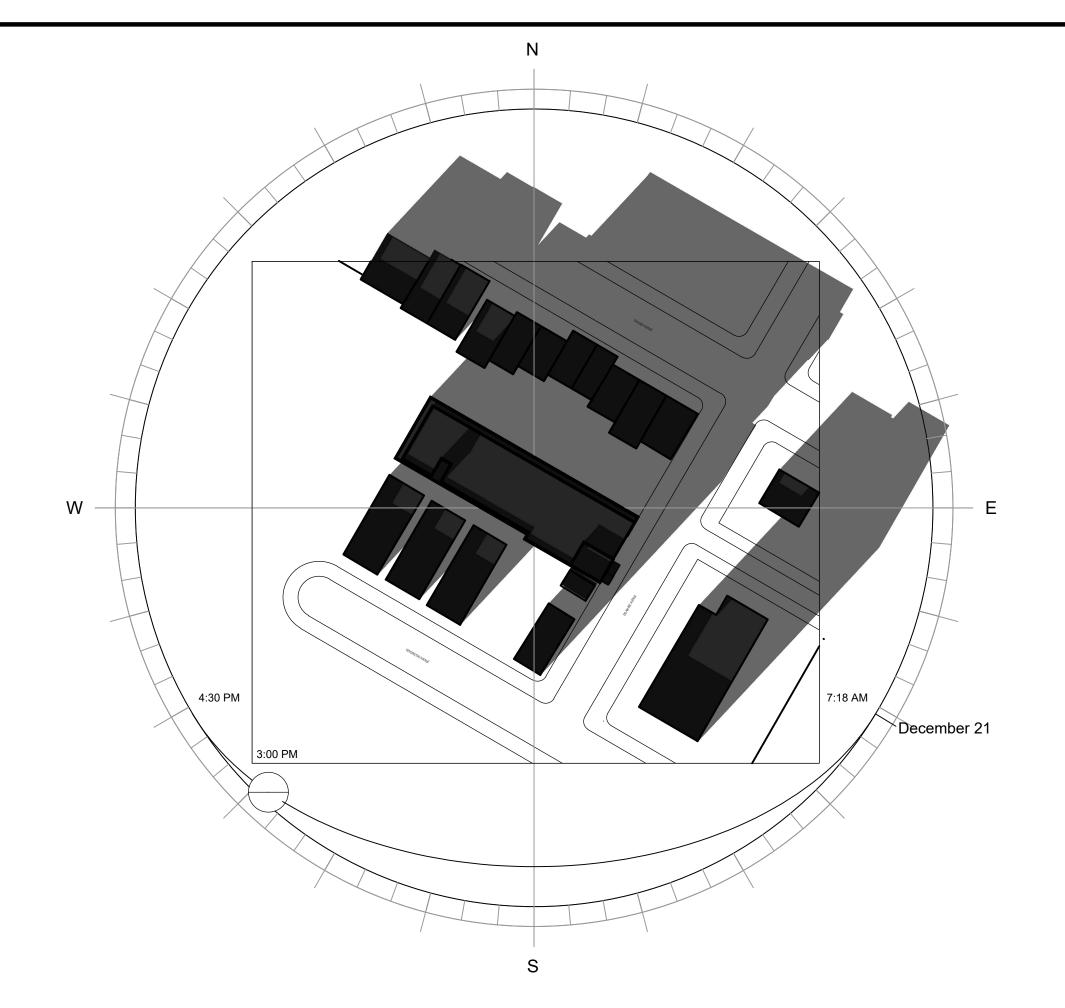

3 DECEMBER 21ST 3PM SCALE: 1" = 80'-0"

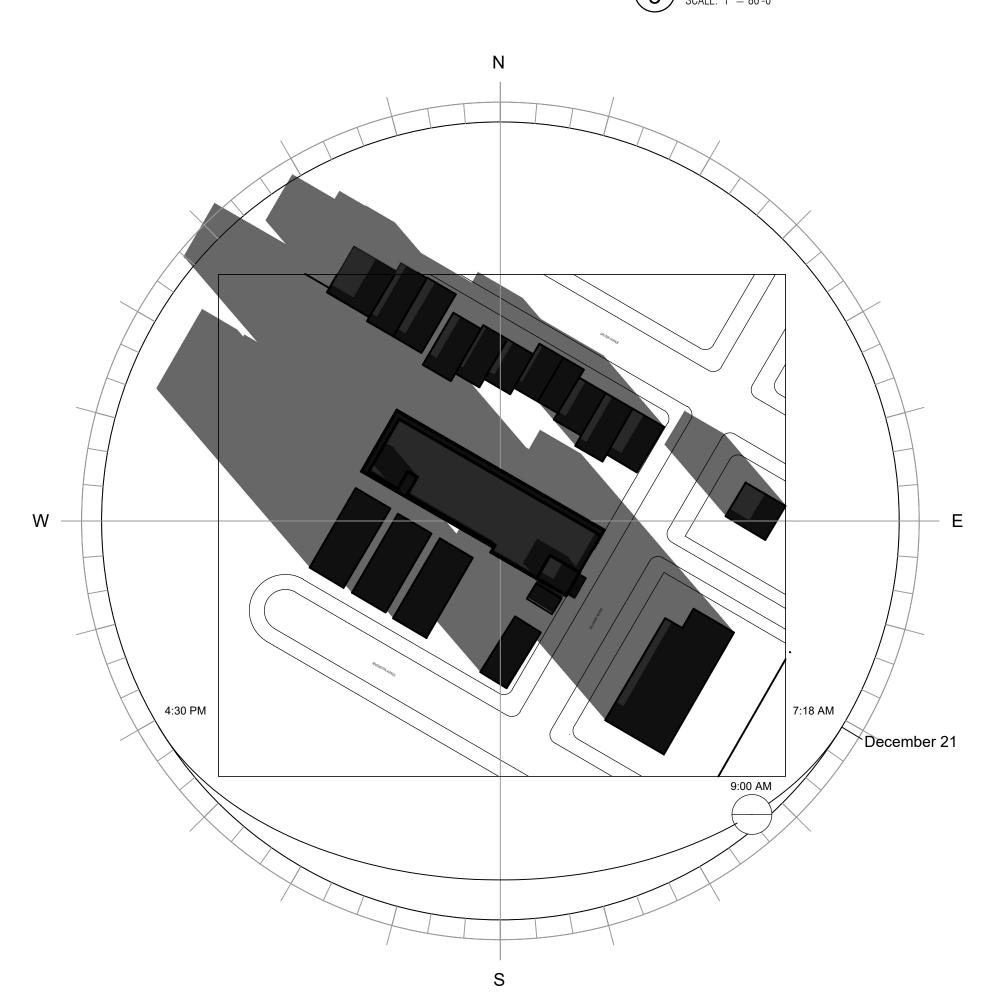

1 DECEMBER 21ST 9AM SCALE: 1" = 80'-0"



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SHEET TITLE:

SHEET:

A-3.01